



SYRACUSE DIVISION
ADDITION & RENOVATIONS

OF THE
HIGHWAY SECTION

AT

MANCHESTER SECTION MAINTENANCE COMPLEX


INTERCHANGE 43

MILEPOST 340.15

IN

ONTARIO COUNTY

TAS 25-9A
D215012

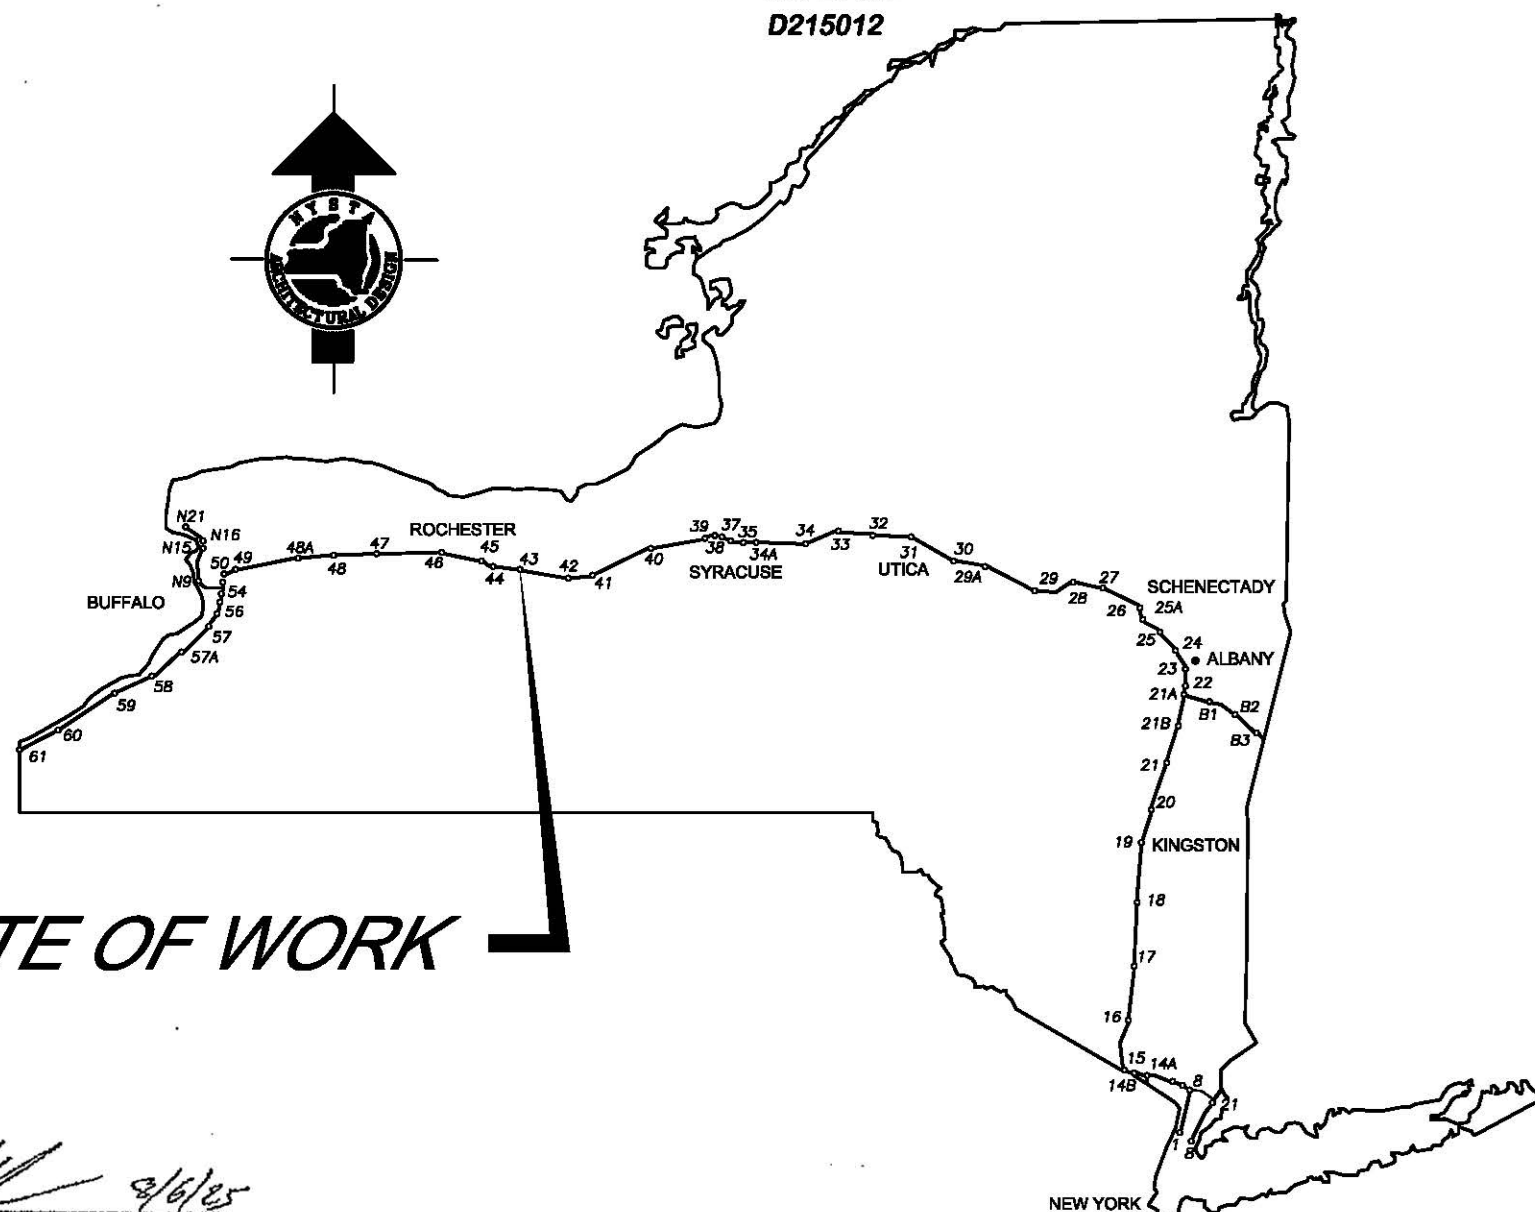

TYPE OF CONSTRUCTION:

ARCHITECTURAL PROJECT REQUIRING LABOR AND MATERIALS FOR GENERAL CONSTRUCTION, MECHANICAL, ELECTRICAL, PLUMBING, ABATEMENT, SITE WORK.

CODE COMPLIANCE:

ALL WORK DESCRIBED AND TO BE PERFORMED UNDER THIS CONTRACT, SHALL CONFORM TO THE PROVISIONS OUTLINED BY 19 NYCRR, 202 BUILDING CODE OF NEW YORK STATE AND ITS REFERENCE STANDARDS, INCLUDING ICC/ANSI 117.1 - 2009.

BUILDING CLASSIFICATIONS:

OCCUPANCY CLASSIFICATION: B
CONSTRUCTION CLASSIFICATION: IIB

NOTES:

ALL WORK CONTEMPLATED UNDER THIS CONTRACT IS TO BE COVERED BY AND IN CONFORMITY WITH THE STANDARD SPECIFICATIONS (US CUSTOMARY) REFERENCED IN THE CONTRACT "PROPOSAL" EXCEPT AS MODIFIED BY THESE PLANS OR CHANGES SET FORTH IN THE CONTRACT "PROPOSAL".

STANDARD SHEETS:

THE LATEST REVISIONS OF THE STANDARD SHEETS MAINTAINED BY NYSDOT, WHICH ARE CURRENT AS OF THE STANDARD SPECIFICATIONS ADOPTION DATE SHOWN ON THE PROPOSAL COVER SHALL BE CONSIDERED TO BE IN EFFECT. ALL PAY ITEMS AND WORK CONTAINED IN THE CONTRACT AND ANY ADDITIONAL PAY ITEMS AND WORK ENCOUNTERED DURING THE COURSE OF THE CONTRACT SHALL BE SUBJECT TO THE APPLICABLE STANDARD SHEET(S) UNLESS OTHERWISE SPECIFIED IN THE CONTRACT DOCUMENTS.

THE LATEST REVISIONS OF THE NYSTA STANDARD SHEETS MAINTAINED BY THE AUTHORITY, WHICH ARE CURRENT ON THE DATE OF ADVERTISEMENT FOR BIDS, SHALL BE CONSIDERED TO BE IN EFFECT. ALL PAY ITEMS AND WORK CONTAINED IN THE CONTRACT AND ANY ADDITIONAL PAY ITEMS AND WORK ENCOUNTERED DURING THE COURSE OF THE CONTRACT SHALL BE SUBJECT TO THE APPLICABLE STANDARD SHEET(S) UNLESS OTHERWISE SPECIFIED IN THE CONTRACT DOCUMENTS. SEE GENERAL NOTES DRAWINGS FOR LISTING.

UDIG NEW YORK
UNDERGROUND FACILITIES PROTECTION ORGANIZATION
CALL 811

CONTRACTOR'S NAME:	
AWARD DATE:	
COMPLETION DATE:	
FINAL ACCEPTANCE DATE:	
INSPECTION FIRM'S NAME:	
RESIDENT ENGINEER:	
FINAL BIDD TOTAL:	
FISCAL SHARE	COST(S)
INSPECTION FIRM CONSULTANT SIGNATURE:	

RECOMMENDED BY: *[Signature]* 8/6/25
DIRECTOR, OFFICE OF DESIGN DATE

RECOMMENDED BY: *[Signature]* 8/11/25
DIVISION DIRECTOR DATE

RECOMMENDED BY: *[Signature]* 8/12/25
DATE TRAFFIC ENGINEER

RECOMMENDED BY: *[Signature]* 8/12/25
DIRECTOR, OFFICE OF CONSTRUCTION MANAGEMENT DATE

RECOMMENDED BY: *[Signature]* 8/19/25
DIRECTOR OF MAINTENANCE AND OPERATIONS DATE

APPROVED BY: *[Signature]* 8/22/25
CHIEF ENGINEER DATE

PREPARED AND RECOMMENDED BY: *[Signature]* DATE 07/30/2025
CONSULTANT COMPANY NAME: CPL
CONSULTANT MANAGERS NAME: MATHEW SMULLEN, P.E.
LICENSE NUMBER: 80043, EXP. DATE: 5/31/2026

REVIEWED BY: *[Signature]*

PROJECT MANAGER

BUREAU DIRECTOR

263

LIST OF ABBREVIATIONS

AFF AP ACOUS ADJ ACT AWP A/C ALT ALUM AB < ANOD APPROX ARCH AD @ AUTO	ABOVE FINISHED FLOOR ACCESS PANEL ACOUSTICAL ADJACENT ACOUSTICAL CEILING TILE ACOUSTICAL WALL PANEL AIR CONDITIONING ALTERNATE ALUMINUM ANCHOR BOLT ANGLE ANODIZED APPROXIMATE ARCHITECT, ARCHITECTURAL AREA DRAIN AT AUTOMATIC	CM CW CFMF COL CONC CMU COND CONN CONST CJT CONT CONTR CJ CG CORR CFCI	CONSTRUCTION MANAGER COLD WATER COLD FORMED MET FRAMING COLUMN CONCRETE CONCRETE MASONRY UNIT CONNECTION CONSTRUCTION CONSTRUCTION JOINT CONTINUOUS CONTRACTOR CONTROL JOINT CORNER GUARD CORRUGATED COURSE CONTRACTOR FURNISHED CONTRACTOR INSTALLED	EL EMER ENCL ENTR EQ EQUIP EST EXHAUST EXIST EXP EXP JT ETR	ELEVATOR EMERGENCY ENCLOSURE ENTRANCE EQUIPMENT ESTIMATE(D) EXHAUST EXISTING EXPANSION EXPANSION JOINT EXISTING TO REMAIN	HEX HWY HM	HEXAGONAL HIGHWAY HOLLOW METAL	MECH MET M MEZZ MM MIN MISC MTD	MECHANICAL METAL METER MEZZANINE MILLIMETER MINIMUM MISCELLANEOUS MOISTURE RESISTANT MOUNTED	QTY QT QT/B	QUANTITY QUARRY TILE QUARRY TILE BASE	TPD TR T&G T&B TOEA TOS TOW T,TR TD TYP	TOILET PAPER DISPENSER TOILET ROOM TONGUE & GROOVE TOP & BOTTOM TOP OF EDGE ANGLE TOP OF SLAB/STEEL TOP OF WALL TREAD TRENCH DRAIN TYPICAL		
BSMT BM BP BM BITUM BLKG BLK BD BOT BRK BLDG BN CAB CI CPT CSMT CB CLG CLG HT CEM CL CM CER CT CB CO CLR CLOS CFCI	BASEMENT BEAM BEARING PLATE BENCH MARK BITUMINOUS BLOCKING BLOCK BOARD BOTTOM BRICK BUILDING BULLNOSE CABINET CAST IRON CARPET(ED) CASEMENT CATCH BASIN CEILING CEILING HEIGHT CEMENT CENTER LINE CENTIMETER CERAMIC CERAMIC TILE CHALK BOARD CIRCUMFERENCE CLEAN OUT CLEAR CLOSET CONTRACTOR FURNISHED CONTRACTOR INSTALLED	CFT CYD DP DL DB DEMO DEPT DET,DTL DIA DIM DISP DSP DO DR C DBL DN DS DT DWR DWG DF DWC DW EA EF E EC ELEC ELEV	CONTRACTOR FURNISHED CONTRACTOR INSTALLED CUBIC FOOT CUBIC YARD DAMP PROOFING DEAD LOAD DECIBEL DEMOLISH DEPARTMENT DETAIL DIAMETER DIMENSION DISPENSER DISPOSAL DITTO, REPEAT, SAME DOOR DOUBLE DOWN DOWNSPOUT DRAIN TILE DRAWER DRAWING DRINKING FOUNTAIN DRYWALL CHANNEL DISHWASHER EACH EACH FACE EAST ELECTRICAL OUTLET ELECT. CONTRACTOR ELECTRICAL ELEVATION	FAB FT FIG FIN FF FEC FH FL, FLR FD FLUOR FT FTG FND FS FUT FRT	FABRICATE /FABRIC FEET FIGURE FINISH FINISHED FLOOR FIRE EXTINGUISHER CABINET FIRE HOSE FLOOR FLOOR DRAIN FLUORESCENT FOOT FOOTING FOUNDATION FULL SIZE FUTURE FIRE RATED TREATED	JAN JANITOR JANITOR SINK JOINT JT	JANITOR JANITOR SINK JOINT	OC OPNG OD OH O	ON CENTER OPENING OUTSIDE DIAMETER OVERHEAD OXYGEN	PTD KIP PR PT PKG PART BD PART PVMT PLAM PL PLBG PLYWD PVC LB PCF PLF PSF PSI PRE CONC PRE FAB PT, PTD PT PL PS CONC PC	PAINTED PAIR PAPER TOWEL RECEPTOR PARKING PARTIAL BOARD PARTITION PAVEMENT PLASTIC LAMINATE PLATE PLUMBING PLYWOOD POLYVINYL CHLORIDE POUND POUNDS PER CUBIC FOOT POUNDS PER LINEAR FOOT POUNDS PER SQUARE FOOT POUNDS PER SQUARE INCH PRECAST CONCRETE PREFABRICATED PAINT, PAINTED PRESSURE TREATED PROPERTY LINE PRESTRESSED CONCRETE PLUMBING CONTRACTOR	SALV SAN SCHED SEC SECT SHT SIM SC STC SCS SPEC SQ SS STD STL STOR STRUCT SGFT ST,STL SUSP SAT SK SGT TEL TV TEMP THK RC	SALVAGE SANITARY SCHEDULE SECOND SECTION SHEET SIMILAR SOUND CORE SOUND TRANSMISSION COEFFICIENT SOUTH SPECIAL COATING SYSTEM SPECIFICATION SQUARE STAINLESS STEEL STANDARD STEEL STORAGE STRUCTURAL STRUCTURAL GLAZED FACING TILE STRUCTURAL STEEL SUSPENDED SUSPENDED ACOUSTICAL TILE SKYLIGHT STRUCTURAL GLAZED TILE TELEPHONE TELEVISION TEMPERATURE THICKNESS ROOFING CONTRACTOR	V VEND VEN VF VERT VEST VN VB VCT VF VWC VT VOL WH W WF WC WR WT WWF WWW (W) WIND W/O WO WI YD	VACUUM VENDER VENEER VERIFY IN FIELD VERTICAL VESTIBULE VINYL VINYL BASE VINYL COMPOSITION TILE VINYL FABRIC VINYL WALL COVERING VINYL TILE VOLUME WALL HUNG WATER WEST WATER CLOSET WATER RESILIENT/ RESISTANT WEIGHT WELDED WIRE FABRIC WELDED WIRE MESH WIDTH WINDOW WITH WOOD WROUGHT IRON YARD

MATERIAL SYMBOLS


GRAPHIC SYMBOLS


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




ARCHITECTURE
ENGINEERING
PLANNING
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REVISIONS			
DATE	DESCRIPTION	BY	SYM.



NEW YORK
STATE OF
OPPORTUNITY.

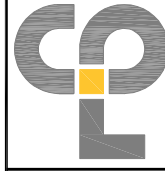Thruway
Authority

TITLE OF PROJECT
ADDITIONS TO MAINTENANCE
SECTION

LOCATION OF PROJECT
MANCHESTER
MP 340.15

TITLE OF DRAWING
INDEX OF DRAWINGS
AND
ABBREVIATIONS

CONTRACT NUMBER:
TAS 25-9A

DATE:
07/30/2025

DRAWING NUMBER:
IND-1

TA NUMBER/DWGSS/DWG NUMBER

CHECKED BY: XXX

DRAFTED BY: XXX

CHECKED BY: XXX

DESIGNED BY: XXX

BUREAU DIRECTOR: J.L. MORRIS

TA NUMBER: 07/30/2025
CHECKED BY: J.L. MORRIS
DRAFTED BY: J.L. MORRIS
DESIGNED BY: J.L. MORRIS
BUREAU DIRECTOR: J.L. MORRIS

TABLE OF BENCHMARKS			
NAME	STATION OFFSET	ELEVATION	DESCRIPTION
CPBM-1	N/A	559.94	X CUT IN ANCHOR BOLT ON RADIO TOWER 87' SOUTH EAST OF CBP 2
CPBM-2	N/A	558.76	RAILROAD SPIKE IN POWER POLE 37' SOUTH OF CBP 1 GPS

NOTES:

ALL UNDERGROUND UTILITIES ARE TAKEN FROM RECORD MAPS UNLESS OTHERWISE NOTED.

HORIZONTAL DATUM:

COORDINATES SHOWN ARE REFERENCED TO THE NEW YORK STATE PLANE COORDINATE SYSTEM WEST ZONE, 3103 NAD 83. COMBINED
SCALE FACTOR FOR THE PROJECT IS 0.999950358

VERTICAL DATUM:

ELEVATIONS ARE REFERENCED TO THE NORTH AMERICAN VERTICAL DATUM 1988, (NAVD 88).

REMOVE AND DISPOSE OF APPROXIMATELY
20 LF OF SANITARY SEWER

PROVIDE FULL
DEPTH SAW CUT

UNKNOWN PIPE RISER
(FIELD VERIFY)
REMOVE AND DISPOSE OF
EXISTING ASPHALT PAVEMENT

REMOVE AND DISPOSE OF
EXISTING MANHOLE

REMOVE AND DISPOSE OF
EXISTING AIR CONDITIONING UNIT
RELOCATE EXISTING WALL MOUNTED
ELECTRIC BOX. SEE ELECTRICAL DRAWINGS.

RELOCATE EXISTING WALL MOUNTED GAS
REGULATOR. SEE PLUMBING DRAWINGS.

VERIFY IN FIELD LOCATION AND FUNCTION
OF ASSUMED SANITARY CLEANOUT. REMOVE
IF NOT NECESSARY AND REPAIR THE PIPE.

REMOVE EXISTING
ENTRANCE VESTIBULE. SEE
ARCHITECTURAL DRAWINGS

CBP 1 GPS
SET REBAR & CAP
N=1085496.343
E=647556.138
ELEV=557.283

GRASS

ASPHALT
PARKING
LOT

CPBM-2
RR SPIKE IN
POWER POLE
ELEV=558.76

10 0 20 40
1 INCH = 20 FEET

3
63



CHAIN LINK FENCE
W-BEAM GUIDE RAIL

DIRT

DIRT

ASPHALT
DRIVE

PROTECT EXISTING SANITARY
SEWER AND WATER MAIN

REMOVE AND DISPOSE
OF EXISTING FENCE

PROTECT EXISTING CONCRETE PAD

REMOVE AND DISPOSE OF EXISTING
ASPHALT. PROVIDE FULL DEPTH SAWCUT

ASPHALT
PARKING
LOT

RELOCATE EXISTING OVERHEAD
ELECTRIC. SEE ELECTRICAL DRAWINGS.

FLAGPOLE

BLACK OUT EXISTING
PAVEMENT STRIPE

EXISTING FLAGPOLE TO REMAIN

PICNIC TABLE TO BE
RELOCATED BY OWNER.

REMOVE AND DISPOSE
OF EXISTING CONCRETE
PAD AND STEP.

SURVEY BASELINE

CBP 2
SET REBAR & CAP
N=1085331.516
E=647625.143
ELEV=557.717

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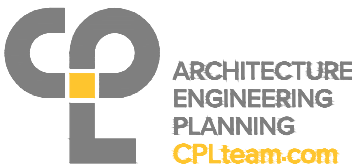
07/30/2025

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SIGNATURE:
STAMP:



EXP. 5/31/2026



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REVISIONS

DATE	DESCRIPTION	BY	SYM.



TITLE OF PROJECT
ADDITIONS TO MAINTENANCE
SECTION

LOCATION OF PROJECT
MANCHESTER
MP 340.15

TITLE OF DRAWING
EXISTING CONDITIONS AND
DEMOLITION PLAN

CONTRACT NUMBER:

TAS 25-9A

DATE:

07/30/2025

DRAWING NUMBER:

C100

TA NUMBER/DWG NUMBER

CHECKED BY: XXX

DRAFTED BY: XXX

CHECKED BY: XXX

XXX


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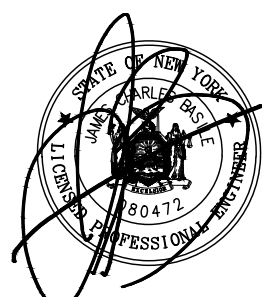
BUREAU DIRECTOR: J.L. MORRIS

24" DIAMETER DRYWELL WITH 6" SOLID ACCESS COVER
(NDS FLO-WELL DRY WELL FWAS24 OR EQUAL;
INSTALL WASHED STONE 24" SURROUNDING ENTIRE STRUCTURE;
WRAP STONE AND STRUCTURE EACH WITH NON-WOVEN GEOFABRIC)
USE ALL SMALL DIAMETER KNOCKOUTS. USE ONE SMALL DIAMETER
KNOCKOUT FOR INCOMING 1" CONDENSATE LINE
RIM = 557.85'; BOTTOM = 554.85'

CBP 1 GPS
SET REBAR & CAP
N=1085496.343
E=647556.138
ELEV=557.283

10 0 20 40
1 INCH = 20 FEET

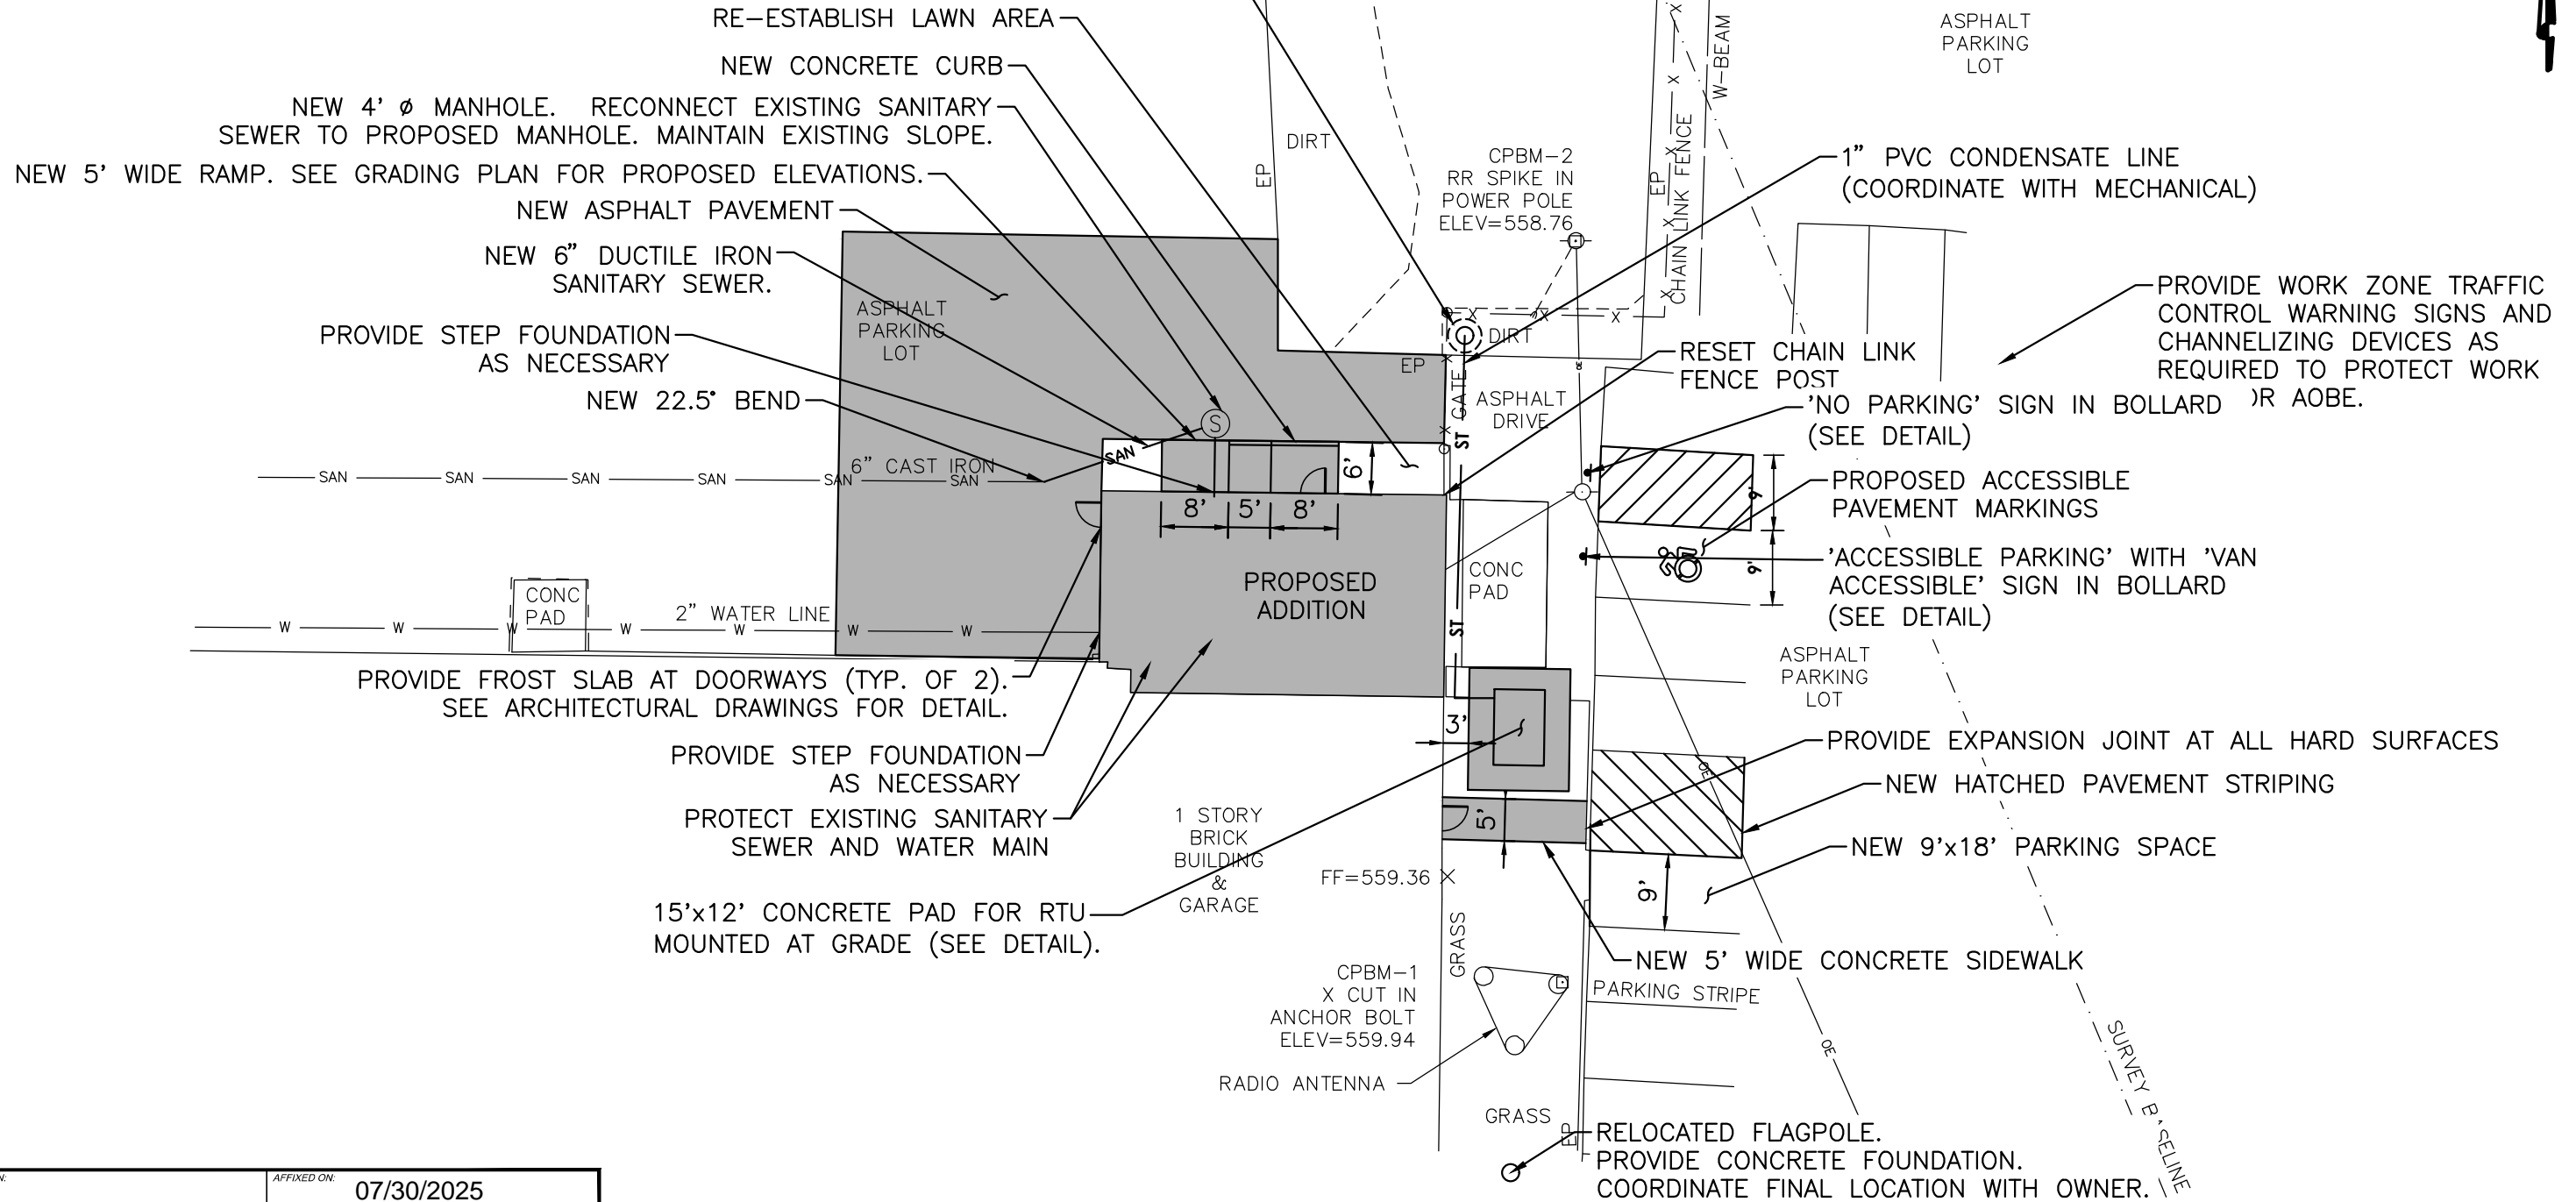

ALTERED ON:	AFFIXED ON: 07/30/2025
SIGNATURE: STAMP:	SIGNATURE: STAMP:
	
EXP. 5/31/2026	



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REVISIONS			
DATE	DESCRIPTION	BY	SYM.



TITLE OF PROJECT ADDITIONS TO MAINTENANCE SECTION	CONTRACT NUMBER: TAS 25-9A
LOCATION OF PROJECT MANCHESTER MP 340.15	DATE: 07/30/2025
TITLE OF DRAWING PROPOSED SITE AND UTILITY PLAN	DRAWING NUMBER: C200

TITLE OF PROJECT ADDITIONS TO MAINTENANCE SECTION		CONTRACT NUMBER: TAS 25-9A
LOCATION OF PROJECT MANCHESTER MP 340.15		DATE: 07/30/2025
TITLE OF DRAWING PROPOSED GRADING PLAN		DRAWING NUMBER: C201

GENERAL NOTES:

1.

ALL WORK IS TO BE COMPLETED IN ACCORDANCE WITH OSHA, COUNTY, TOWN, NYSTA, NYSDEC, USACE AND LOCAL COMMUNITY REQUIREMENTS.
2.

THE LOCATIONS, SIZES AND ELEVATIONS OF EXISTING UTILITIES ARE BASED ON INFORMATION COMPILED BY THE ENGINEER FROM DRAWINGS OF RECORDS AND INFORMATION FURNISHED BY THE VARIOUS UTILITIES, WITH FIELD CHECKING WHERE NECESSARY AND POSSIBLE. THE ACCURACY OF THIS INFORMATION IS NOT GUARANTEED AND MAY BE APPROXIMATE ONLY. IT IS THE CONTRACTOR'S RESPONSIBILITY TO HAVE THIS INFORMATION VERIFIED AND LOCATED PRIOR TO CONSTRUCTION. NO CONSTRUCTION EXCAVATION, BORING, OR BLASTING SHALL BE DONE WITHOUT CERTIFICATION OF THE DEPTH AND LOCATION OF UTILITIES. CALL DIG SAFELY NEW YORK (UFPO) AT 811 OR 1-(800)-962-7962 AT LEAST 48 HOURS PRIOR TO COMMENCING WORK.
3.

THE CONTRACTOR SHALL EXPOSE EXISTING UTILITIES, SERVICES, SEWERS AND LATERALS AHEAD OF PIPE LAYING OR OTHER WORK OPERATIONS SO THAT IF MINOR ADJUSTMENTS MUST BE MADE IN ELEVATION AND/OR ALIGNMENT, DUE TO INTERFERENCE, THESE CHANGES CAN BE MADE IN ADVANCE OF THE WORK.
4.

DRAINAGE SHALL BE MAINTAINED THROUGHOUT THE PERIOD OF CONSTRUCTION. THE ROADS SHALL BE KEPT CLEAN OF MUD AND DEBRIS AT ALL TIMES.
5.

SAFE AND CONTINUOUS THROUGH TRAFFIC AND INGRESS AND EGRESS FOR ADJACENT OWNER DRIVEWAYS, SERVICE ROADS AND PUBLIC STREETS SHALL BE MAINTAINED THROUGHOUT THE PERIOD OF CONSTRUCTION.
6.

THE CONTRACTOR SHALL CONFORM TO ALL CONDITIONS OF ANY APPLICABLE EASEMENTS.
7.

THE CONTRACTOR SHALL LOCATE, FLAG AND PRESERVE SURVEY MONUMENTS AND PROPERTY CORNER MARKERS. THE CONTRACTOR SHALL HAVE A LICENSED SURVEYOR REESTABLISH ANY PROPERTY CORNERS OR SURVEY MONUMENTS DISTURBED DURING CONSTRUCTION AT NO ADDITIONAL COST TO THE OWNER.
8.

THE CONTROL OF EROSION AND SEDIMENT ORIGINATING FROM CONSTRUCTION OPERATIONS IS CONSIDERED A CRITICAL RESPONSIBILITY OF THE CONTRACTOR. EROSION CONTROL DEVICES SHALL BE ESTABLISHED PRIOR TO COMMENCING WORK. THE ENGINEER WILL BE THE FINAL JUDGE OF THE ADEQUACY OF CONTRACTOR'S EROSION AND SEDIMENT CONTROL AND MAY SUSPEND WORK UNTIL ADEQUATE CONTROL IS ATTAINED.
9.

UTILITY POLES SHALL BE SUPPORTED, WHERE NECESSARY, AT NO ADDITIONAL COST TO THE OWNER.
10.

TO PROTECT NEW OR EXISTING WORK, SHEETING OR SHORING (IF REQUIRED DURING CONSTRUCTION) SHALL BE PROVIDED AT NO COST TO THE OWNER.
11.

CONTRACTOR SHALL BE RESPONSIBLE FOR PROPER DISPOSAL OF EXCAVATED MATERIAL FROM THE SITE.
12.

THE CONTROL OF DUST ORIGINATING FROM THE CONSTRUCTION OPERATIONS IS CONSIDERED A CRITICAL RESPONSIBILITY OF THE CONTRACTOR. THE ENGINEER WILL BE THE FINAL JUDGE OF THE ADEQUACY OF THE CONTRACTOR'S DUST CONTROL EFFORTS. WORK MAY BE SUSPENDED BY THE ENGINEER UNTIL ADEQUATE DUST CONTROL IS ATTAINED.
13.

ALL NEW SURFACES SHALL BE SLOPED AWAY FROM THE BUILDING ADDITION UNLESS OTHERWISE NOTED ON THE DRAWINGS.
14.

MAINTAIN FIRE APPARATUS ACCESS ROAD TO ALL PORTIONS OF THE BUILDING. THE FIRE APPARATUS ACCESS ROAD SHALL COMPLY WITH THE FIRE CODE AND EXTEND TO WITHIN 150' OF THE BUILDING.

EROSION CONTROL NOTES:

1.

SEDIMENT FROM THE SITE SHALL BE PREVENTED FROM DISCHARGING TO ANY SURFACE WATER OR STORMWATER PIPING SYSTEM BY THE INSTALLATION OF EROSION AND SEDIMENTATION CONTROL MEASURES AND PRACTICES PRIOR TO OR CONCURRENT WITH LAND DISTURBING ACTIVITIES.
2.

CONTRACTOR SHALL APPOINT A PERSON TO BE RESPONSIBLE FOR ALL EROSION AND SEDIMENT CONTROL MEASURES. THIS PERSON SHALL BE TRAINED IN ACCORDANCE WITH NYSDEC REQUIREMENTS FOR EROSION AND SEDIMENT CONTROL ACTIVITIES.
3.

PROVIDE AND MAINTAIN SILT FENCE AROUND PERIMETER OF ALL WORK AREAS, EXCAVATED SOIL STOCKPILES, AND BETWEEN DISTURBED AREAS AND DRAINAGE WAYS OR WATER BODIES. COORDINATE LOCATIONS WITH OWNER AS WORK PROGRESSES AND AREAS ARE STABILIZED. SILT FENCE TO BE INSTALLED AND ENTRENCHED (MIN 6" BELOW GROUND ELEVATION). SILT SOCK MAY USED ON PAVED OR GRAVEL AREAS.
4.

EROSION CONTROL MEASURES SHALL BE IN PLACE PRIOR TO ANY SOIL DISTURBANCE ACTIVITIES, INCLUDING GRADING OR FILLING OPERATIONS AND INSTALLATION OF PROPOSED STRUCTURES OR UTILITIES.
5.

CONTRACTOR SHALL MAINTAIN EROSION CONTROL MEASURES AT ALL TIMES. IF FULL IMPLEMENTATION OF THE APPROVED PLAN DOES NOT PROVIDE FOR EFFECTIVE EROSION CONTROL, ADDITIONAL EROSION AND SEDIMENT CONTROL MEASURES SHALL BE IMPLEMENTED.
6.

PERMANENT GROUND COVER SHALL BE INSTALLED ON ALL DISTURBED AREAS WITHIN 5 WORKING DAYS FOLLOWING COMPLETION OF CONSTRUCTION OR DEVELOPMENT.
7.

ADJACENT ROADWAYS TO BE KEPT FREE AND CLEAR OF DEBRIS, REFUSE AND SILT AT ALL TIMES.
8.

CONTRACTORS SHALL NOT WASH CONCRETE TRUCKS, TOOLS OR EQUIPMENT OUT ONTO BARE GROUND OR DIRECTLY INTO STORM OR SANITARY SEWER SYSTEMS (INCLUDING SWALES, DITCHES, STREAMS, PONDS, WETLANDS, ETC.). EXCESS CONCRETE AND CONCRETE WASH WATER SHALL BE COLLECTED IN A WASHBASIN AND DISPOSED OF PROPERLY. CONCRETE WASHOUT AREAS SHALL BE DESIGNED TO THE MOST CURRENT VERSION OF THE NEW YORK STATE STANDARDS AND SPECIFICATIONS FOR EROSION AND SEDIMENT CONTROL. ALL CONCRETE WASHOUT AREAS UTILIZED BY THE CONTRACTOR SHALL BE PRE-APPROVED BY THE THRUWAY PROJECT-ENGINEER (TPE). REFER TO ENVIRONMENTAL SPECIAL NOTE 29: CONTROL OF WET CONCRETE WASTE.
9.

EROSION CONTROL MEASURES WILL BE STRICTLY ENFORCED BY THE ENGINEER. ANY EROSION CONTROL DEVICE WHICH IS DEEMED NECESSARY BY THE ENGINEER SHALL BE INSTALLED BY THE CONTRACTOR PRIOR TO CONTINUING WITH THE WORK.
10.

PERIODIC CLEANING AND INSPECTION OF TEMPORARY SOIL EROSION AND WATER POLLUTION CONTROL DEVICES WILL BE NECESSARY. AFTER ANY STORM EVENT MAINTENANCE SHALL BE REQUIRED.
11.

IN THE EVENT DEWATERING OPERATIONS BECOME NECESSARY, A SETTLING BASIN WILL BE REQUIRED UNLESS THE PUMP DISCHARGE IS AS CLEAR AND FREE OF SEDIMENT AS THE FLOWING STREAM. PRIOR TO USE, THE SETTLING BASIN LOCATION AND DESIGN SHALL BE APPROVED BY THE ENGINEER.
12.

THE COST OF INSTALLING, CLEANING AND REMOVING TEMPORARY SOIL EROSION AND WATER POLLUTION CONTROL DEVICES SHALL NOT BE PAID FOR SEPARATELY. THEY SHALL BE INCLUDED AS SPECIFIED IN THE BIDDING DOCUMENTS.

DEMOLITION NOTES:

1.

THE CONTRACTOR SHALL ABANDON AND/OR REMOVE EXISTING UTILITIES, STRUCTURES, PAVEMENT, SIDEWALK, CURB AND APPURTENANCES AS SHOWN ON THE PLANS AND/OR AS DIRECTED.
2.

ALL MATERIALS SHALL BE DISPOSED OF OFF-SITE IN ACCORDANCE WITH ALL CURRENT REGULATIONS AND REQUIREMENTS.
3.

PROTECT PROJECT BENCHMARKS.
4.

CONTRACTOR TO COORDINATE WITH OWNER FOR WORK ADJACENT TO BUILDING ENTRANCES/EXITS. ENTRANCE/EXIT DOORS TO ALL BUILDINGS TO REMAIN FULLY FUNCTIONAL AND UNOBSTRUCTED AS REQUIRED BY CODE TO INSURE PROPER INGRESS AND EGRESS IS MAINTAINED AT ALL TIMES.
5.

CONTRACTOR TO PROVIDE TEMPORARY WALKWAYS TO MAINTAIN INGRESS AND EGRESS TO ALL BUILDINGS AS NECESSARY AND TO BE COORDINATED WITH OWNER'S REPRESENTATIVE. WALKWAYS WITHIN 10' OF CONSTRUCTION, DEMOLITION ACTIVITIES, OR OPEN EXCAVATION SHALL HAVE PHYSICAL BARRIERS TO PROTECT PEDESTRIANS.
6.

PROTECT ALL SURFACE AND SUBSURFACE UTILITIES TO REMAIN DURING DEMOLITION WORK.
7.

THE CONTRACTOR SHALL DETERMINE EXACT LOCATION AND ELEVATION OF UNDERGROUND UTILITIES BEFORE COMMENCING CONSTRUCTION. CONTRACTOR SHALL MAKE EXPLORATION EXCAVATIONS TO LOCATE EXISTING UNDERGROUND FACILITIES SUFFICIENTLY AHEAD OF CONSTRUCTION TO PERMIT REVISIONS AS REQUIRED.
8.

WHERE ASPHALT PAVEMENT IS TO BE REMOVED ADJACENT TO CURB OR SIDEWALK THAT IS TO REMAIN, THE CONTRACTOR SHALL MAKE A FULL DEPTH SAW CUT IN THE ASPHALT PAVEMENT ALONG THE FACE OF THE CURB TO PROTECT THE CURB AND SIDEWALK.
9.

ALL NEW AND RESTORED LAWN AREAS SHALL RECIEVE 4" OF APPROVED TOP SOIL AND BE SEEDED.


TA NUMBER: 06/20/2025
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DESIGNED BY: J.L. MORRIS


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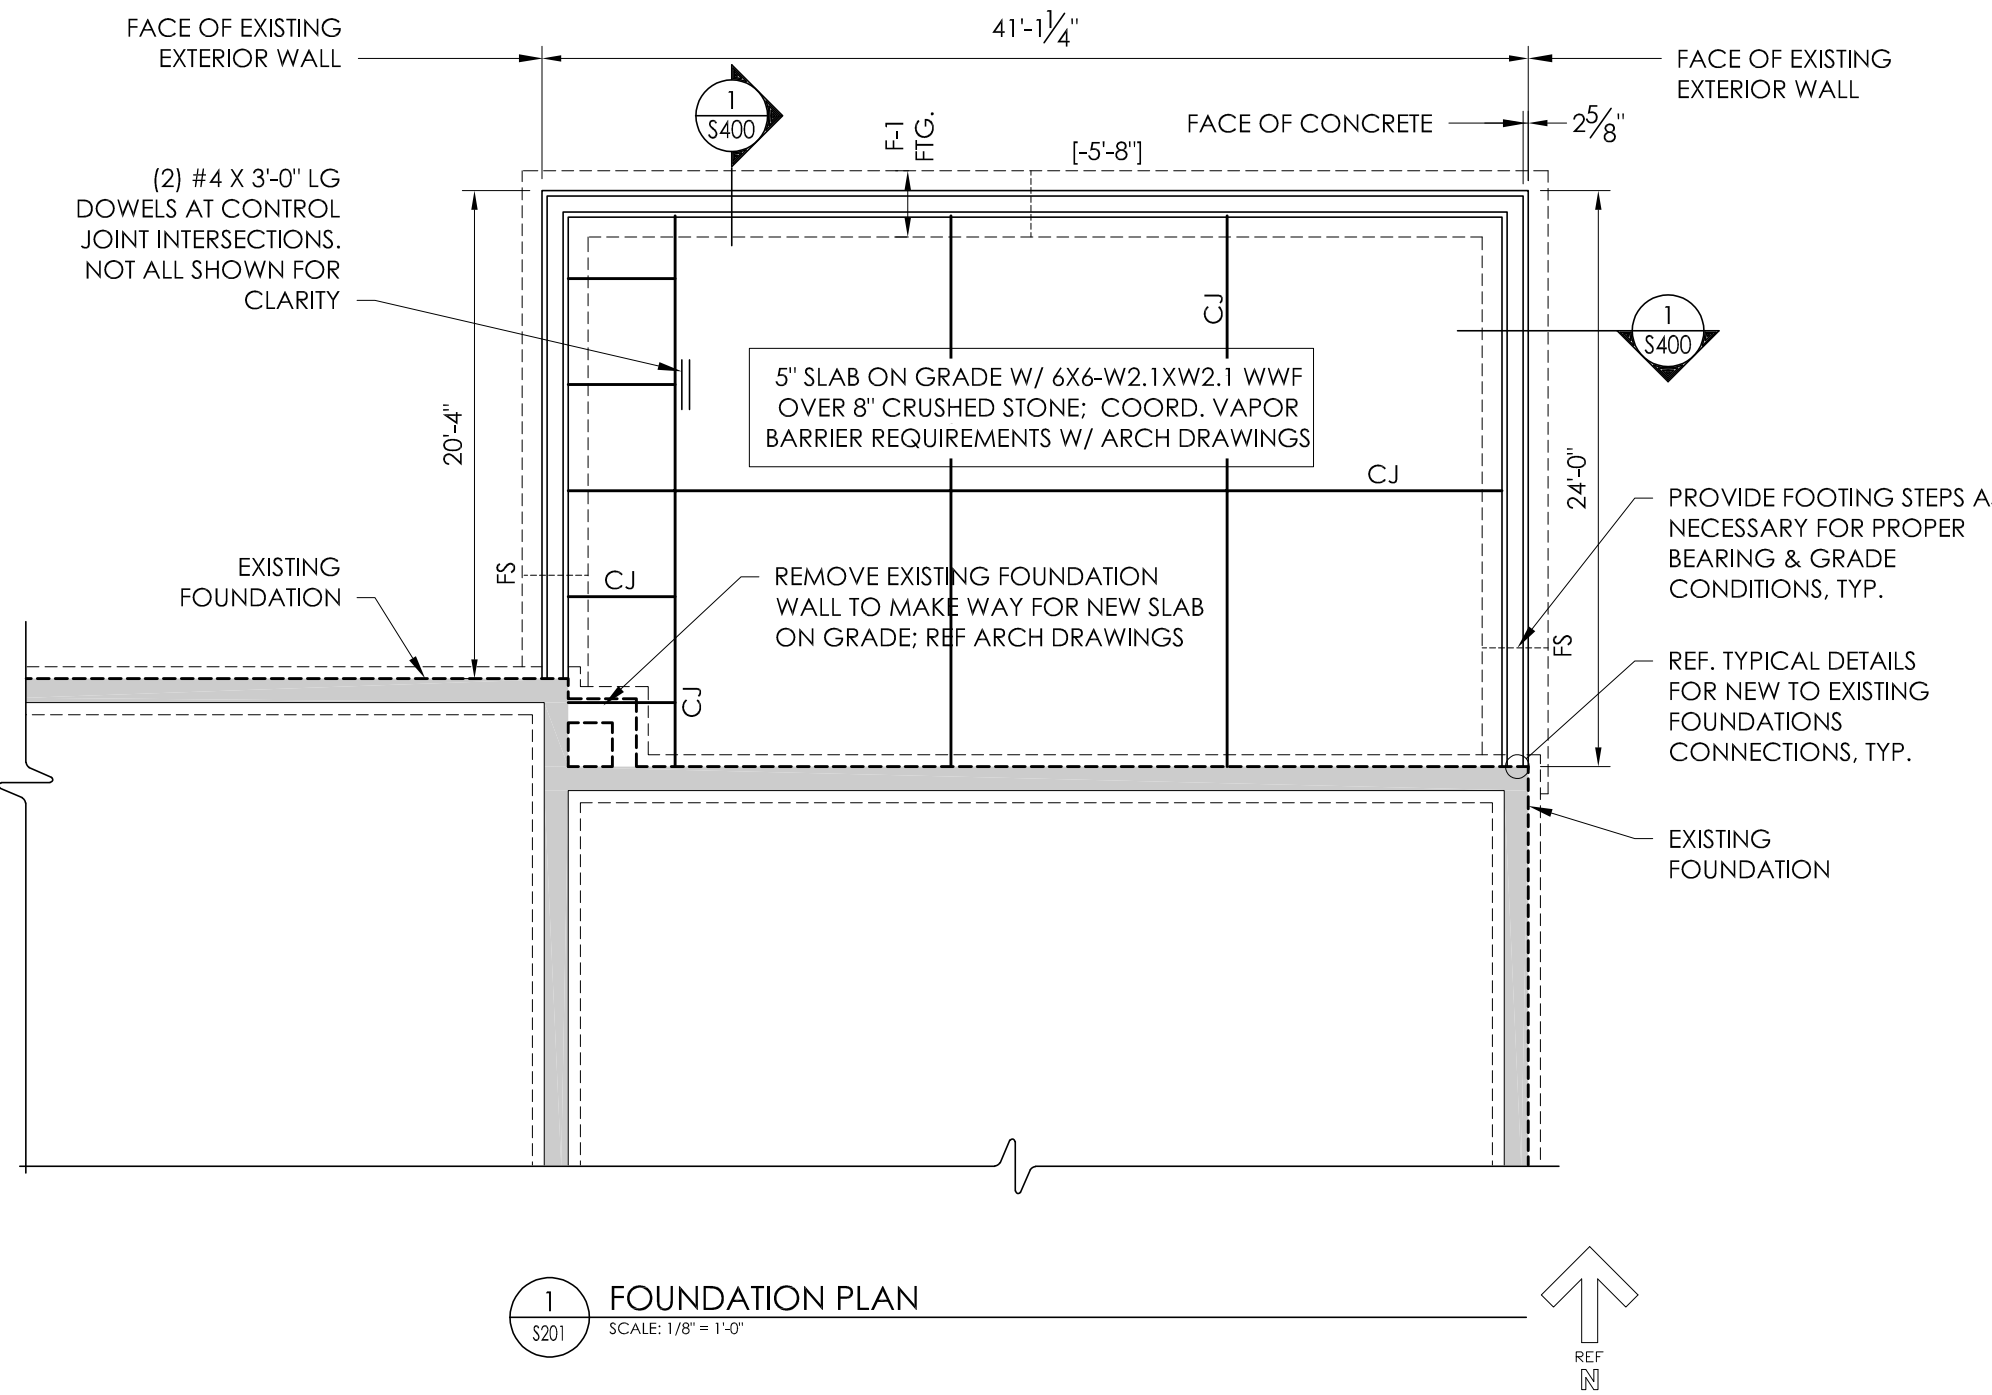
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DATE	DESCRIPTION	BY	SYM.



TITLE OF PROJECT ADDITIONS TO MAINTENANCE SECTION	CONTRACT NUMBER: TAS 25-9A
LOCATION OF PROJECT MANCHESTER MP 340.15	DATE: 07/30/2025
TITLE OF DRAWING MISCELLANEOUS DETAILS	DRAWING NUMBER: C300

TITLE OF PROJECT ADDITIONS TO MAINTENANCE SECTION	CONTRACT NUMBER: TAS 25-9A
LOCATION OF PROJECT MANCHESTER MP 340.15	DATE: 07/30/2025
TITLE OF DRAWING MISCELLANEOUS DETAILS	DRAWING NUMBER: C302
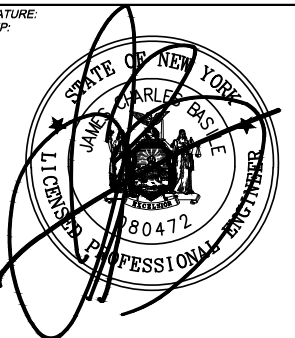
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DESIGNED BY:
J.L. MORRIS
BUREAU DIRECTOR:



FOUNDATION AND SLAB PLAN NOTES


1. DATUM 0'-0" = 559.36' = FINISHED FLOOR ELEVATION.
2. FOUNDATION DESIGN(S) IS BASED ON THE GEOTECH REPORT BY EMPIRE GEO TECHNICAL ENGINEERING SERVICES, DATED SEPTEMBER 2019. THE CONTRACTOR SHALL OBTAIN A COPY OF THE REPORT AND REVIEW THE RECOMMENDATIONS AND REQUIREMENTS INCLUDED THEREIN PRIOR TO START OF CONSTRUCTION.
3. DESIGN ALLOWABLE SOIL BEARING CAPACITY IS 2,000 PSF (NATURAL SOILS OR FILL).
4. TOP OF EXTERIOR FOOTING SHALL BEAR AT A MINIMUM OF 4'-0" BELOW FINISHED GRADE UNLESS NOTED OTHERWISE.
5. TOP OF INTERIOR FOOTINGS SHALL BE AT [-8"] BELOW FINISHED FLOOR UNLESS NOTED OTHERWISE. TOP OF PIERS/FOOTINGS OF COLUMNS/WALLS SUPPORTING A ROOF DRAIN LEADER SHALL BE RECESSED FROM FINISHED FLOOR BY A MINIMUM OF 12-INCHES. FOR CONTINUOUS WALL FOOTINGS, THE ABOVE CITED RECESS SHALL BE MINIMUM 2'-0" WIDE. MAINTAIN REQUIRED FOOTING THICKNESS AT ALL TIMES. CONTRACTOR TO COORDINATE DRAIN LOCATIONS AND ELEVATIONS WITH FOUNDATION ELEMENTS AND NOTIFY ARCHITECT AND ENGINEER IF ANY CONFLICTS EXIST.
6. [XX'-XX"] DENOTES TOP OF PROPOSED FOOTING AS REFERENCED FROM FINISHED FLOOR SLAB.
7. (XX'-XX") DENOTES TOP OF EXISTING FOOTING AS REFERENCED FROM FINISHED FLOOR ELEVATION. WHERE NEW FOOTING ABUTS EXISTING, MATCH BEARING ELEVATION OF EXISTING.
8. NO PIPES OR CONDUIT SHALL BE PLACED IN THE FOOTINGS. REFER TO PLUMBING AND ELECTRICAL DRAWINGS, AND UTILITY PLANS FOR ALL LOCATIONS AN ELEVATIONS OF PENETRATIONS THROUGH FOUNDATION WALLS. DO NOT EMBED PIPING WITHIN OR PASS PIPING VERTICALLY OR HORIZONTALLY THROUGH FOUNDATIONS WITHOUT REVIEW AND APPROVAL BY THE ENGINEER. STEP TOP OF FOOTINGS DOWN TO ALLOW PIPES OR CONDUIT TO RUN OVER TOP OF FOOTINGS.
9. FOOTINGS SHALL BE CENTERED ABOUT COLUMN LINES AND FOUNDATION WALLS UNLESS NOTED OTHERWISE.
10. CONCRETE SLAB-ON-GRADE SHALL BE 5" THICK, NORMAL WEIGHT CONCRETE WITH REINFORCING OVER A VAPOR BARRIER AND 8" COMPACTED CRUSHED STONE, UNLESS NOTED OTHERWISE.
11. REFER TO ARCHITECTURAL DRAWINGS FOR FLOOR FINISHES, FLOOR DRAINS, SLOPES, DEPRESSED/RAISED SLAB AREAS, AND WATERPROOFING.
12. REFER TO S800 SERIES DRAWINGS FOR ALL DESIGN LOADS AND OTHER INFORMATION PERTINENT TO THE STRUCTURAL DESIGN.
13. THE FOLLOWING DENOTES SYMBOL REPRESENTATION:
FS = FOOTING STEP, COORDINATE WITH GRADING PLANS
FD = FLOOR DRAIN
CJ = SLAB CONTROL JOINTS
TS = THICKENED SLAB
14. (2) SEPARATE POURS ARE ACCEPTABLE FOR FOX BLOCKS CORE POUR.

CONTINUOUS SPREAD FOOTING SCHEDULE		
MARK	SIZE (THICKNESSxWIDTH)	REINFORCING
F-1	12" x 2'-9"	(3) CONT. LONGITUDINAL #5 BAR #5 TRANSVERSE BARS @ 14" O.C.

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

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TITLE OF PROJECT
ADDITIONS TO MAINTENANCE
SECTION


LOCATION OF PROJECT
MANCHESTER
MP 340.15

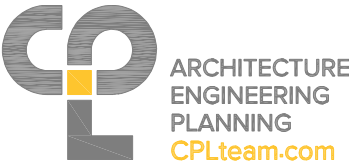TITLE OF DRAWING
FOUNDATION PLAN

CONTRACT NUMBER:
TAS 25-9A




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S200

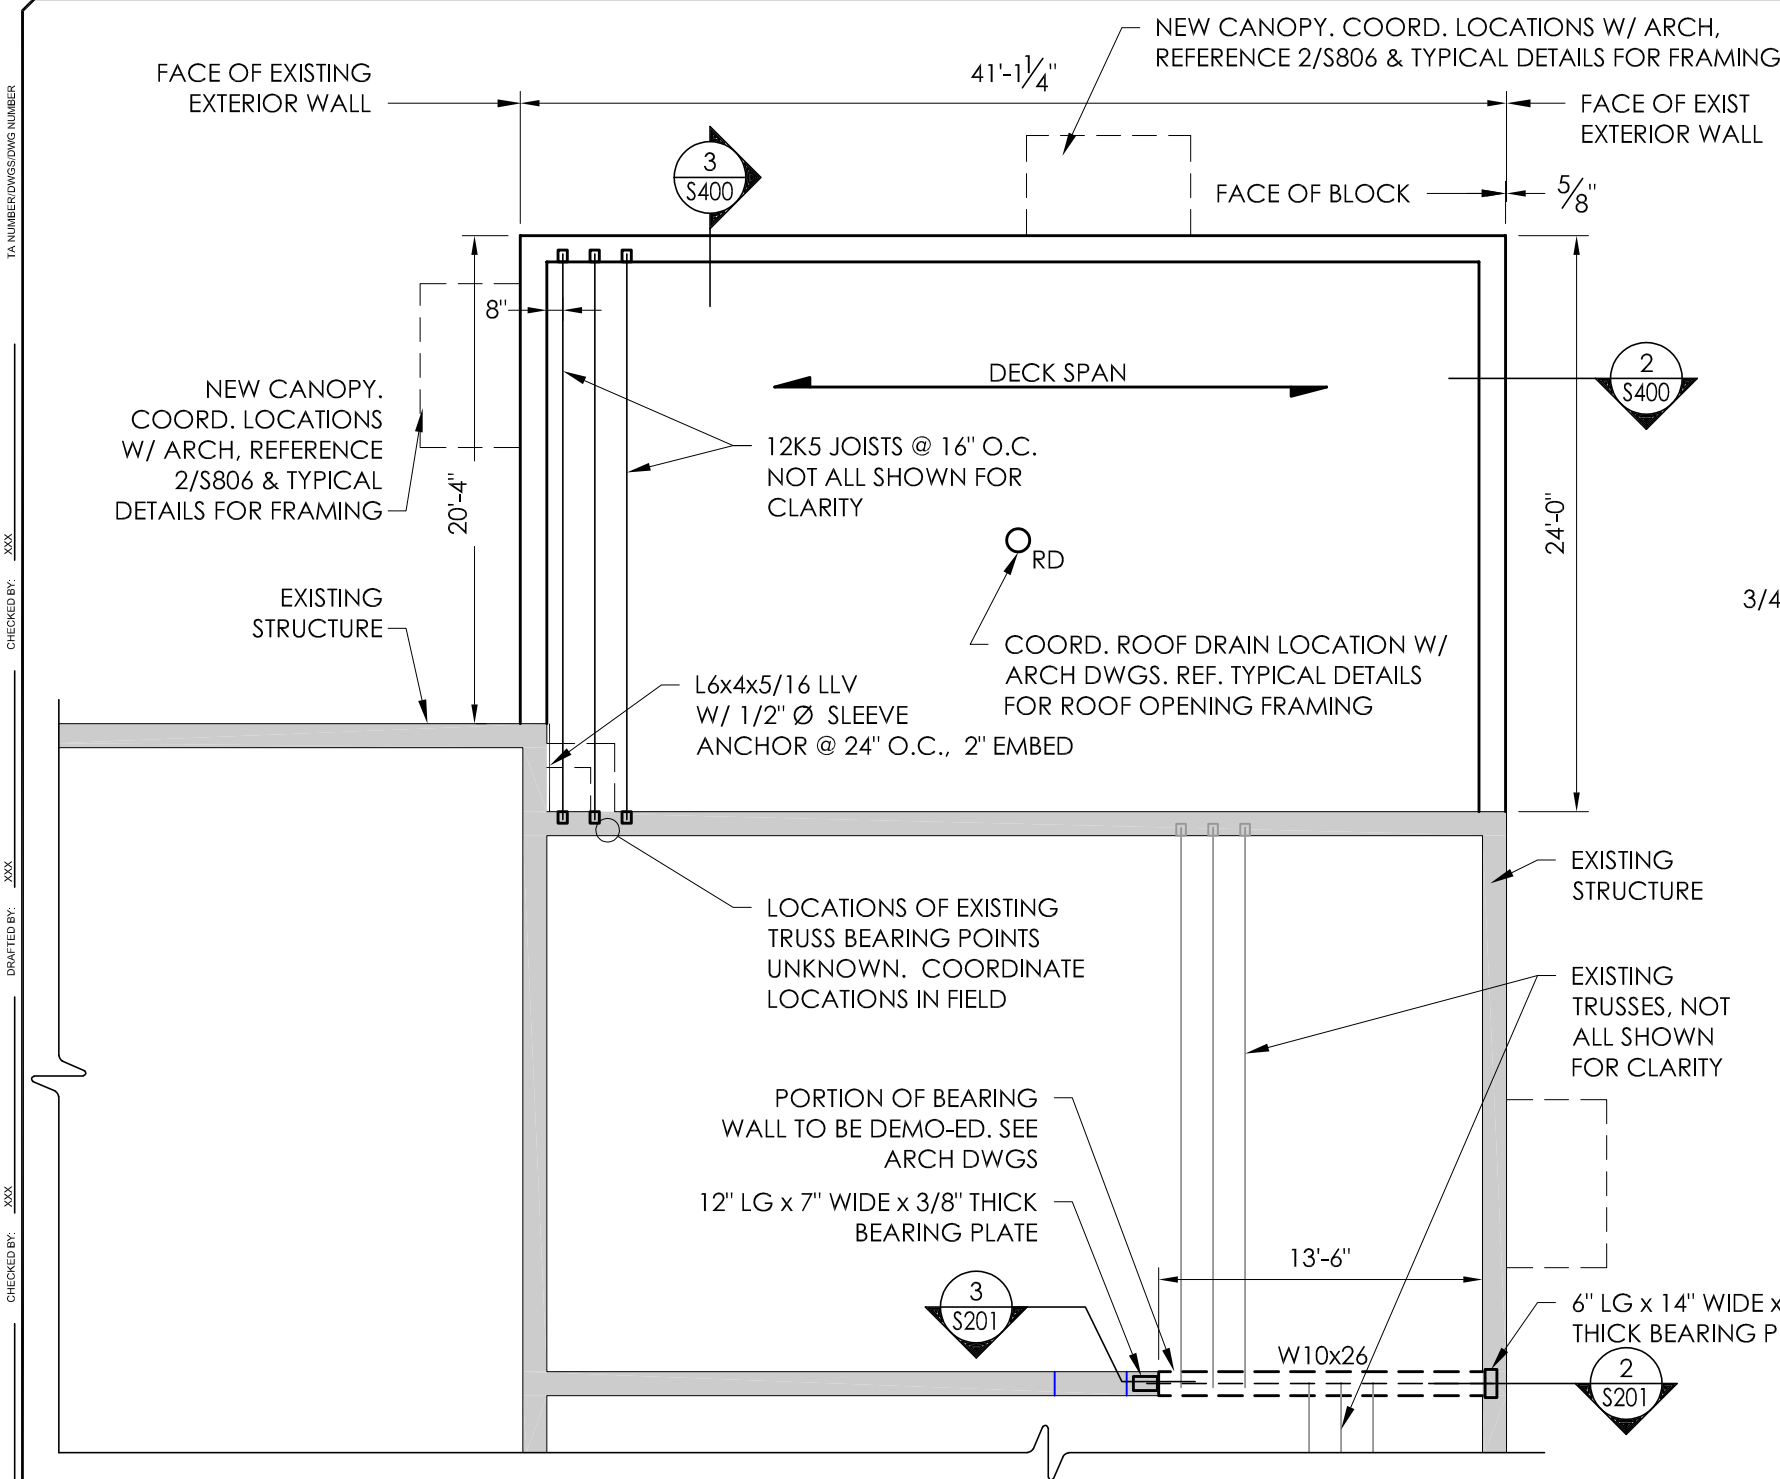


ROOF FRAMING NOTES

1. TOP OF STEEL/BOTTOM OF DECK ELEVATION = EXISTING T.O. STEEL ELEVATION = 10'-0 1/2"±, UNLESS NOTED OTHERWISE BY (+ OR -).
2. METAL ROOF DECK SHALL BE TYPE "B" - 20 GAGE, 1 1/2" WIDE RIB, UNLESS NOTED OTHERWISE.
3. REFER TO ARCHITECTURAL, MECHANICAL, ELECTRICAL, AND PLUMBING DRAWINGS FOR PENETRATIONS NOT SHOWN, AND ALL LOCATIONS SEE TYPICAL DETAILS FOR ADDITIONAL REINFORCEMENT REQUIREMENTS AT OPENINGS. CONTRACTOR TO COORDINATE.
4. PROVIDE JOIST BRIDGING PER THE REQUIREMENTS OF THE STEEL JOIST INSTITUTE. CONTRACTOR TO COORDINATE LOCATIONS OR REQUIRED HORIZONTAL BRIDGING WITH MECHANICAL DRAWINGS.

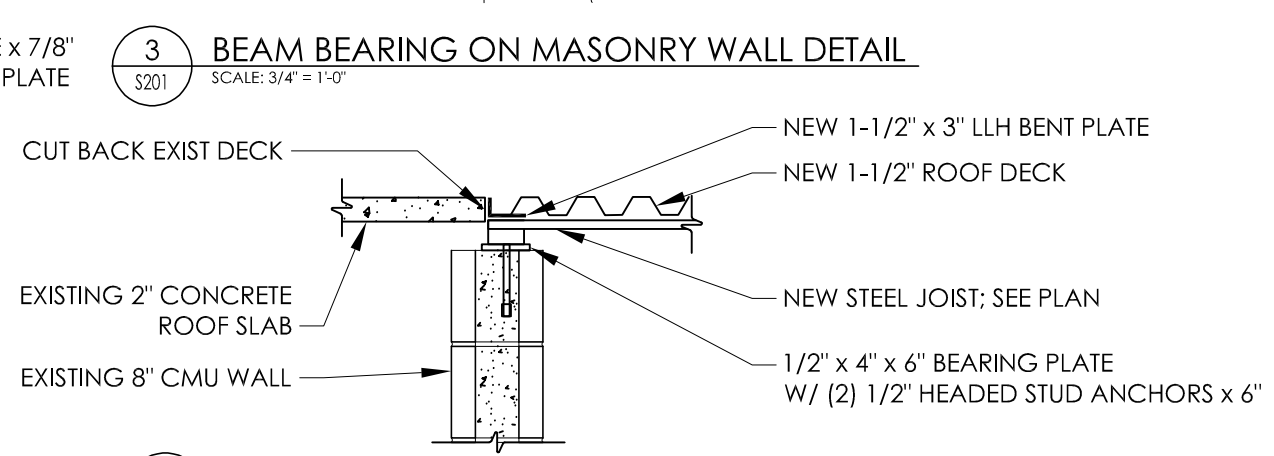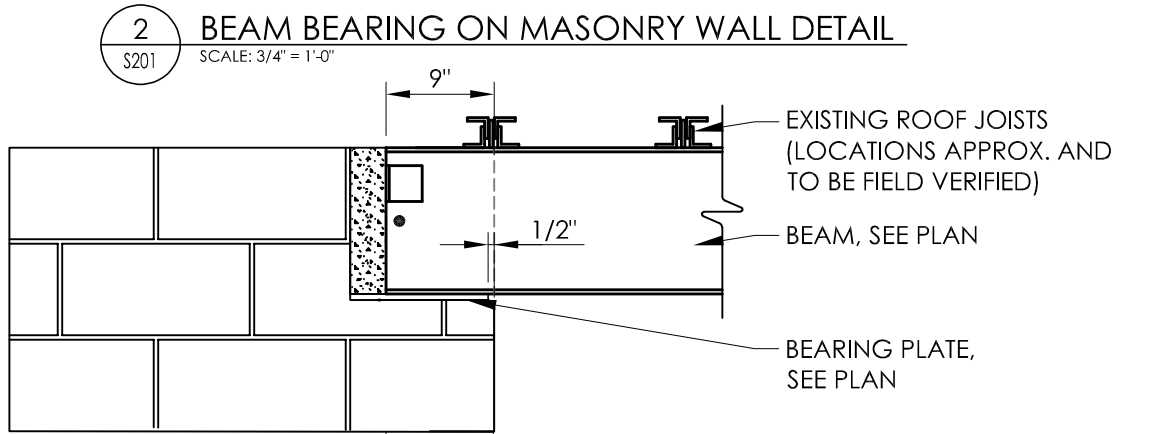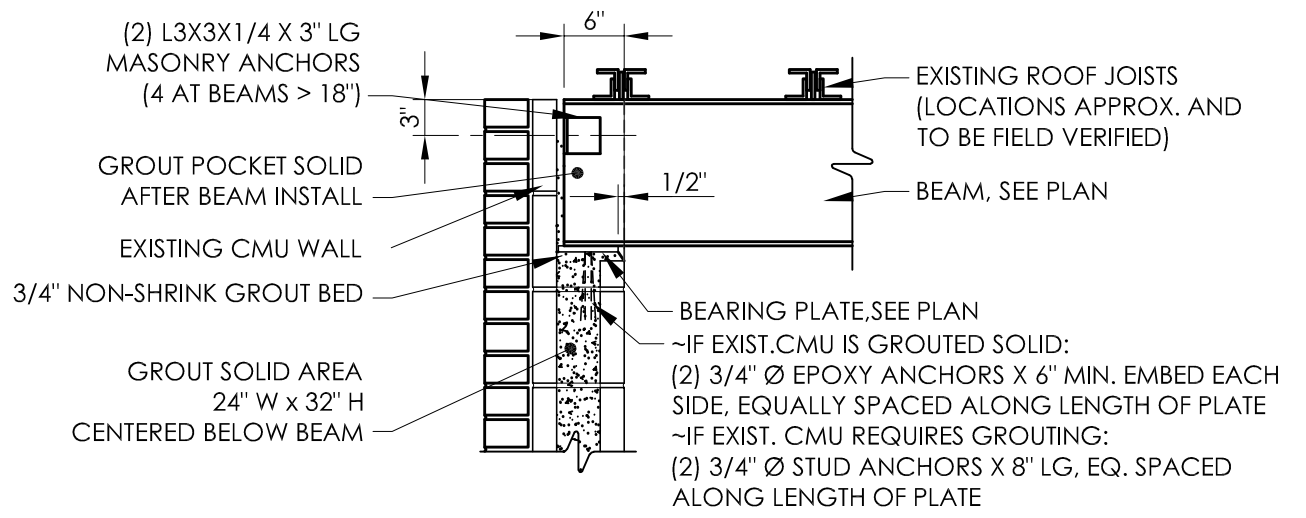


1 ROOF FRAMING PLAN
S201 SCALE: 1/8" = 1'-0"

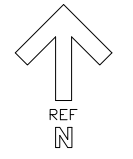

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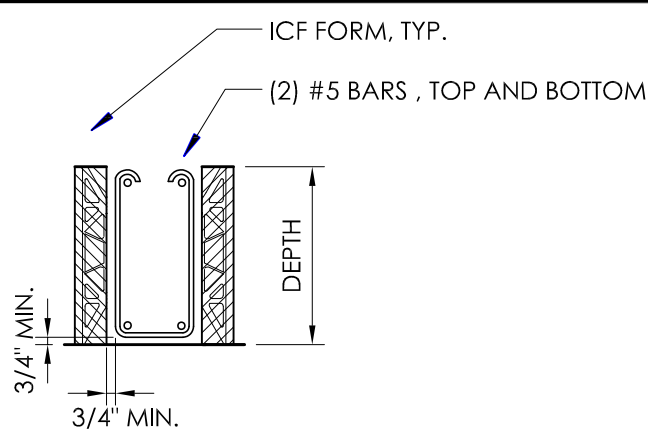
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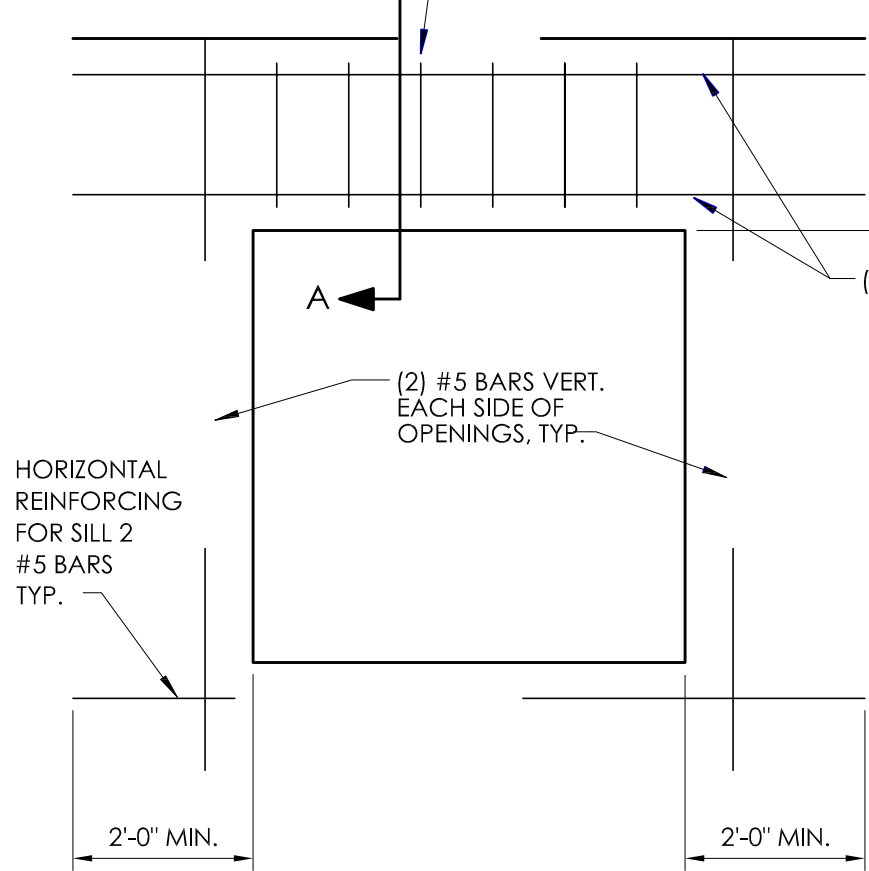


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LOCATION OF PROJECT MANCHESTER MP 340.15	DATE: 07/30/2025
TITLE OF DRAWING ROOF FRAMING PLAN	DRAWING NUMBER: S201

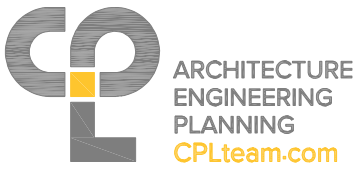
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DESIGNED BY: XXX
BUREAU DIRECTOR: J.L. MORRIS




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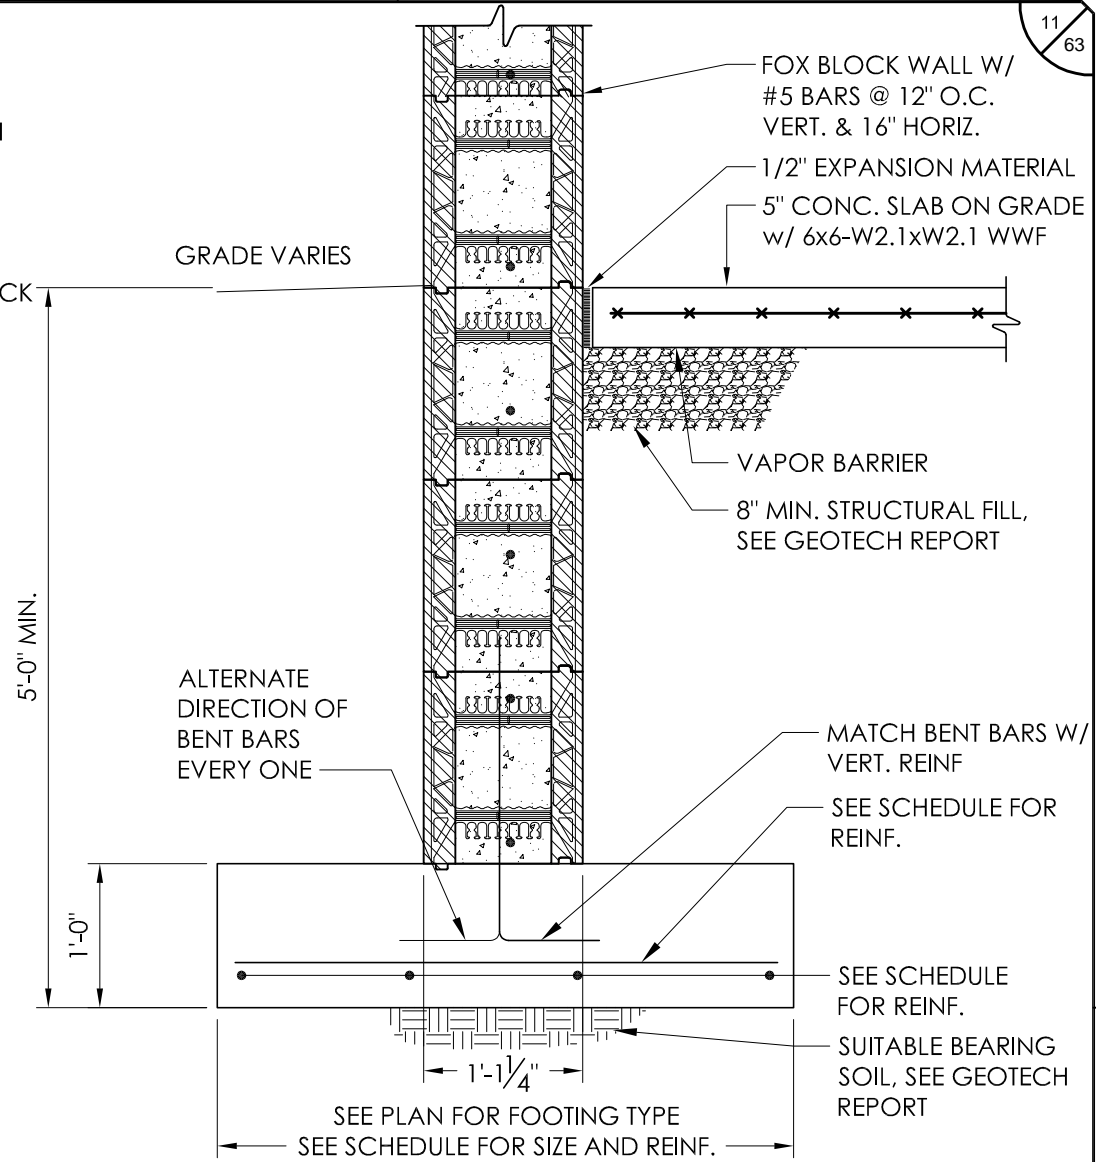
4 TYPICAL OPENING REINFORCING DETAIL
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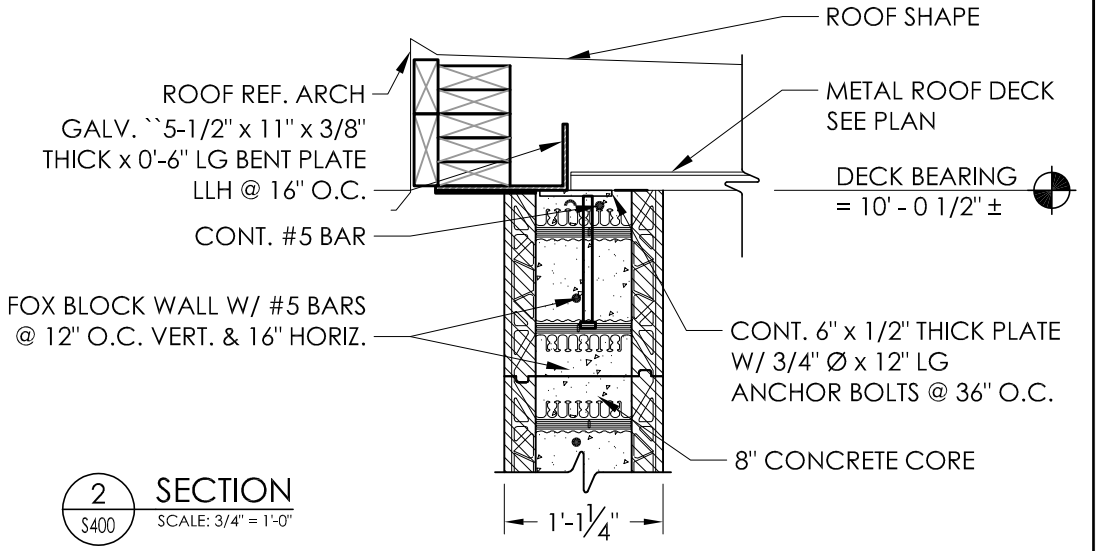
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SCALE: 3/4\"/>



5 SECTION
SCALE: 3/4\"/>

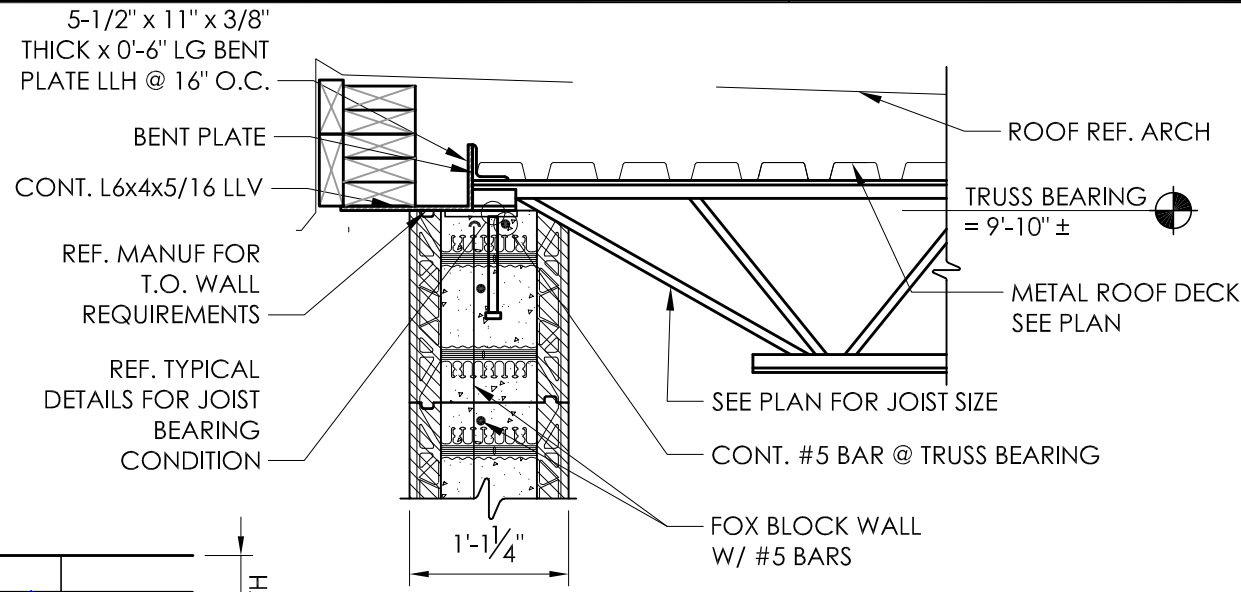

1 SECTION
SCALE: 3/4\"/>

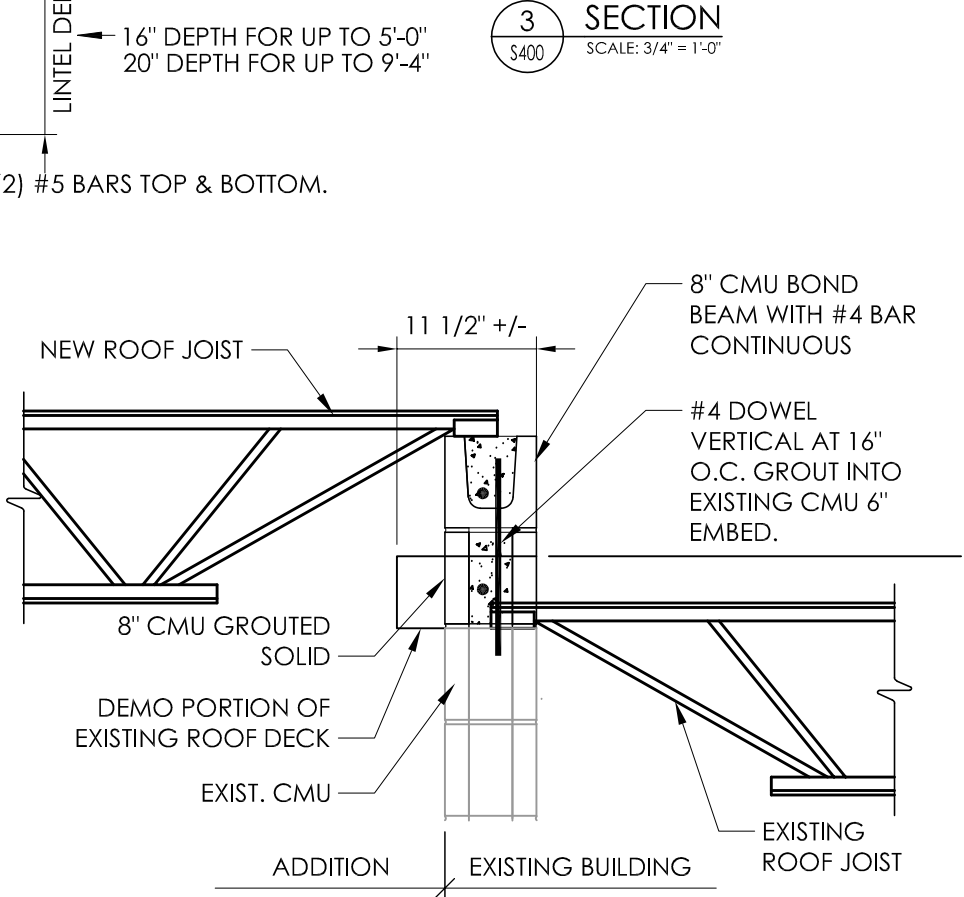

2 SECTION
SCALE: 3/4\"/>

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DATE	DESCRIPTION	BY	SYM.

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Authority

TITLE OF PROJECT ADDITIONS TO MAINTENANCE SECTION	CONTRACT NUMBER: TAS 25-9A
LOCATION OF PROJECT MANCHESTER MP 340.15	DATE: 07/30/2025
TITLE OF DRAWING SECTIONS AND DETAILS	DRAWING NUMBER: S400

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CHECKED BY: XXX
DRAFTED BY: XXX
CHECKED BY: XXX
DESIGNED BY: XXX
BUREAU DIRECTOR: J. L. MORRIS

GENERAL NOTES

- 1. THE STRUCTURE SHOWN ON THESE DRAWING IS SOUND ONLY IN ITS COMPLETED FORM. THE CONTRACTOR SHALL BE RESPONSIBLE FOR PROVIDING THE DESIGN, ADEQUACY, SAFETY AND STABILITY OF TEMPORARY ERECTION BRACING AND SHORING.
- 2. WHERE A DETAIL, TYPICAL DETAIL, SECTION, TYPICAL SECTION OR PLAN NOTE IS SHOWN FOR ONE CONDITION, IT SHALL APPLY FOR ALL SIMILAR OR LIKE CONDITIONS UNLESS NOTED OTHERWISE.
- 3. ALL DESIGN, INCLUDING MATERIAL STRESSES AND METHODS OF CONSTRUCTION SHALL BE IN COMPLIANCE WITH THE 2020 BUILDING CODE OF NEW YORK STATE, OSHA AND GOVERNING AGENCIES HAVING JURISDICTION.
- 4. REFER TO THE "SPECIAL INSPECTIONS" SECTION OF THE SPECIFICATIONS FOR PROJECT REQUIREMENTS AND PERTINENT INFORMATION.
- 5. THE CONTRACTOR SHALL FIELD VERIFY ALL DIMENSIONS, ELEVATIONS AND SITE CONDITIONS SHOWN ON THE DRAWINGS AND IMMEDIATELY NOTIFY THE OWNER'S REPRESENTATIVE OF ANY DISCREPANCIES PRIOR TO ORDERING OR FABRICATING MATERIALS OR OTHERWISE PROCEEDING WITH THE WORK.
- 6. THE CONTRACTOR SHALL BE RESPONSIBLE FOR MEANS, METHODS, TECHNIQUES, SEQUENCES, AND PROCEDURES IN ORDER TO COMPLY WITH THE CONSTRUCTION DOCUMENTS. THE CONTRACTOR SHALL PROVIDE ALL LABOR, MATERIAL, EQUIPMENT AND SERVICES REQUIRED TO EXECUTE AND COMPLETE ALL ITEMS OF WORK AS SHOWN OR INDICATED ON THE DRAWINGS AND AS SPECIFIED HEREIN, INCLUDING INCIDENTAL ITEMS TO EFFECT A FINISHED AND COMPLETE JOB, EVEN THOUGH SUCH ITEMS ARE NOT SHOWN OR PARTICULARLY MENTIONED.
- 7. THE ENGINEER IS NOT RESPONSIBLE FOR THE DESIGN OF STEEL STAIRS, PRECAST CONCRETE, HANDRAILS, CURTAIN WALL/WINDOW SYSTEMS, COLD-FORMED METAL FRAMING, OR OTHER SYSTEMS NOT SHOWN ON THE STRUCTURAL DRAWINGS. SUCH SYSTEMS SHALL BE DESIGNED, FURNISHED, AND INSTALLED AS REQUIRED BY OTHER PORTIONS OF THE CONTRACT DOCUMENTS.
- 8. THE GENERAL CONTRACTOR SHALL USE CONSTRUCTION METHODS THAT ARE IN STRICT ACCORDANCE WITH MANUFACTURER'S SPECIFICATIONS.
- 9. CONTRACTOR SHALL BE COMPLETELY RESPONSIBLE FOR ADEQUATELY SHORING EXISTING CONSTRUCTION WHILE PERFORMING NEW WORK.
- 10. DIMENSIONS ARE NOT TO BE DERIVED BY SCALING THESE DRAWINGS. IF THERE ARE ANY QUESTIONS REGARDING DIMENSIONS, CONTACT THE ARCHITECT/ENGINEER FOR INFORMATION PRIOR TO SUBMITTING SHOP DRAWINGS.
- 11. THE CONTRACTOR SHALL COORDINATE ALL STRUCTURAL WORK WITH THE ARCHITECTURAL AND MECHANICAL DRAWINGS, SPECIFICATIONS, AND WITH THE WORK OF ALL OTHER TRADES.
- 12. THE CONTRACTOR SHALL COORDINATE ALL SIZES AND LOCATIONS OF FLOOR, ROOF AND WALL PENETRATIONS WITH MECHANICAL, PLUMBING AND ARCHITECTURAL DRAWINGS. ALL PENETRATIONS NOT SHOWN ON STRUCTURAL DRAWINGS MUST BE APPROVED BY THE ENGINEER UNLESS NOTED OTHERWISE.

- 13. THE CONTRACTOR SHALL RESTORE TO ITS ORIGINAL CONDITION ALL SITE APPURTENANCES DAMAGED UNDER THIS CONTRACT AT NO ADDITIONAL COST TO THE OWNER.
- 14. INFORMATION IN THESE STRUCTURAL NOTES IS A SELECTED SUMMARY OF REQUIREMENTS. REFER TO SPECIFICATIONS FOR AMPLIFICATIONS OF REQUIREMENTS.
- 15. WHERE MEMBER LOCATIONS ARE NOT SPECIFICALLY DIMENSIONED, MEMBERS ARE EITHER LOCATED ON COLUMN LINES OR ARE EQUALLY SPACED BETWEEN LOCATED MEMBERS.
- 16. THESE DRAWINGS DO NOT INCLUDE NECESSARY COMPONENTS FOR CONSTRUCTION SAFETY. CONTRACTOR SHALL BE SOLEY RESPONSIBLE FOR CONSTRUCTION SAFETY.

NON-COMPOSITE FLOOR AND ROOF DECK NOTES


- 1. ALL METAL DECK SHALL BE MANUFACTURED AND ERECTED IN ACCORDANCE WITH THE LATEST EDITION OF THE "DESIGN MANUAL FOR COMPOSITE DECKS, FORM DECKS AND ROOF DECKS" BY THE STEEL DECK INSTITUTE (SDI).
- 2. REFER TO PLANS FOR NON-COMPOSITE DECK TYPES AND LOCATIONS.
- 3. METAL DECK SHALL BE 1 1/2 INCH x 20 GAUGE, WIDE RIB TYPE B, CLASS I, FACTORY MUTUAL APPROVED., UNLESS NOTED OTHERWISE.
- 4. DECKING SHALL SPAN A MINIMUM OF THREE SPANS.
- 5. DECK SHALL BE WELDED TO SUPPORTING FRAME WORK. PROVIDE WELDING WASHERS WHERE NECESSARY. ANCHORING AT ROOF DECK SHALL RESIST AN UPLIFT OF 20 PSF.
- 6. DO NOT SUSPEND MECHANICAL, ELECTRICAL OR PLUMBING ITEMS FROM ROOF DECK. REFER TO THE MECHANICAL, ELECTRICAL, AND PLUMBING DRAWINGS AND SPECIFICATIONS FOR HANGERS AND SUPPLEMENTAL FRAMING REQUIRED.
- 7. UNLESS NOTED OTHERWISE, ALL DECKING SHALL BE GALVANIZED.
- 8. SEE TYPICAL DETAILS AND PROJECT SPECIFICATIONS FOR ATTACHMENT REQUIREMENTS AND FOR WELD PATTERN.
- 9. CONTRACTOR SHALL SUBMIT SHOP DRAWINGS FOR REVIEW.


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- 1. REFERENCE MANUFACTURER FOR ALL RECOMMENDATIONS, SPECIFICATIONS, REINFORCEMENT AND ANY/ALL OTHER REQUIREMENTS.

EXISTING CONSTRUCTION NOTES

- 1. BEFORE PROCEEDING WITH ANY WORK WITHIN THE EXISTING FACILITY, THE CONTRACTOR SHALL VERIFY ALL DIMENSIONS AND CONDITIONS OF THE EXISTING BUILDING AT THE JOB SITE AND REPORT ANY DISCREPANCIES FROM ASSUMED CONDITIONS SHOWN ON THE DRAWINGS TO THE ARCHITECT AND ENGINEER PRIOR TO THE FABRICATION AND ERECTION OF ANY MEMBERS.
- 2. THE CONTRACTOR SHALL FIELD VERIFY THE DIMENSIONS, ELEVATIONS, ETC. NECESSARY FOR THE PROPER CONSTRUCTION AND ALIGNMENT OF THE NEW WORK TO THE EXISTING WORK.
- 3. WORK SHOWN ON THE DRAWINGS IS NEW, UNLESS NOTED AS EXISTING.
- 4. EXISTING CONSTRUCTION SHOWN ON THE DRAWINGS WAS OBTAINED FROM DRAWINGS PREPARED BY THE FIRM OF EGGERS AND HIGGINS, ARCHITECTS, DATED OCTOBER 1954 AND LIMITED SITE OBSERVATION. THESE DRAWINGS OF EXISTING CONSTRUCTION ARE AVAILABLE FOR CONTRACTOR USE. HOWEVER, THE AVAILABLE DRAWINGS OF EXISTING CONSTRUCTION MAY NOT NECESSARILY BE COMPLETE. THE CONTRACTOR SHALL FIELD VERIFY ALL PERTINENT INFORMATION.
- 5. IF ANY ARCHITECTURAL, STRUCTURAL, OR MECHANICAL MEMBERS OR COMPONENTS NOT DESIGNATED FOR REMOVAL INTERFERE WITH THE NEW WORK, THE ARCHITECT SHALL BE NOTIFIED IMMEDIATELY AND APPROVAL MUST BE OBTAINED PRIOR TO REMOVAL OF THOSE MEMBERS.
- 6. THE CONTRACTOR SHALL SAFELY SHORE EXISTING CONSTRUCTION TO ALLOW THE INSTALLATION OF NEW WORK. ALL SHORING METHODS AND SEQUENCING OF DEMOLITION SHALL BE THE RESPONSIBILITY OF THE CONTRACTOR AND HIS ENGINEER.
- 7. THE CONTRACTOR SHALL SUBMIT A DETAILED PLAN FOR SHORING, BRACING AND PROTECTION OF THE EXISTING CONSTRUCTION. THE PLAN SHALL INCLUDE CONSTRUCTION SEQUENCE, BEAR THE SEAL OF A PROFESSIONAL ENGINEER REGISTERED IN THE STATE OF NEW YORK, AND BE SUBMITTED TO THE ENGINEER OF RECORD FOR REVIEW PRIOR TO THE BEGINNING OF WORK.
- 8. THE CONTRACTOR SHALL VERIFY THE LOCATION OF EXISTING UTILITIES PRIOR TO THE START OF CONSTRUCTION AND TAKE CARE TO PROTECT EXISTING UTILITIES THAT ARE TO REMAIN IN SERVICE.
- 9. THE CONTRACTOR SHALL REPAIR ALL DAMAGE CAUSED DURING CONSTRUCTION WITH SIMILAR MATERIALS AND WORKMANSHIP TO RESTORE CONDITIONS TO LEVELS ACCEPTABLE TO THE ARCHITECT.
- 10. THE CONTRACTOR SHALL ENSURE THAT ALL CONSTRUCTION METHODS USED WILL NOT CAUSE DAMAGE TO THE ADJACENT BUILDINGS AND PROPERTY. THIS SHALL INCLUDE ALL FOUNDATION INSTALLATION.

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TITLE OF PROJECT ADDITIONS TO MAINTENANCE SECTION	CONTRACT NUMBER: TAS 25-9A
LOCATION OF PROJECT MANCHESTER MP 340.15	DATE: 07/30/2025
TITLE OF DRAWING STRUCTURAL NOTES	DRAWING NUMBER: S800

TA NUMBERDWSG.DWG NUMBER

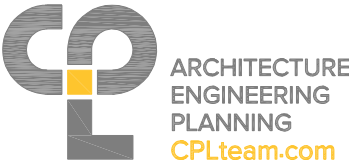CHECKED BY: XXX

DRAFTED BY: XXX

CHECKED BY: XXX

DESIGNED BY: XXX

BUREAU DIRECTOR: J.L. MORRIS

EXCAVATION & BACKFILL NOTES

1. THE SITE SHALL BE PREPARED IN ACCORDANCE WITH SPECIFICATIONS AND THE CIVIL DRAWINGS. THE STRUCTURAL DESIGN IS BASED ON RECOMMENDATIONS CONTAINED IN THE GEOTECHNICAL REPORT PREPARED BY EMPIRE GEO SERVICES, DATED SEPTEMBER 2019. A QUALIFIED GEOTECHNICAL ENGINEER SHALL VERIFY ALL ASSUMPTIONS AND REPORT TO THE ARCHITECT/ENGINEER ANY VARIATIONS.

2. EXCAVATIONS TO BE SHEETED AND BRACED, OR LAID BACK TO PREVENT SLOUGHING IN OF THE EXCAVATED AREAS PER OSHA REGULATIONS.

3. ALL EXCAVATIONS AND GRADES PREPARED FOR BEARING SHALL BE INSPECTED BY A QUALIFIED GEOTECHNICAL ENGINEER TO VERIFY THE DESIGN ASSUMPTIONS AND REPORT NONCONFORMING CONDITIONS.

4. THE CONTRACTOR SHALL DETERMINE THE EXTENT OF CONSTRUCTION DEWATERING REQUIRED FOR THE EXCAVATION. THE CONTRACTOR SHALL SUBMIT TO THE GEOTECHNICAL ENGINEER FOR REVIEW THE PROPOSED PLAN FOR DEWATERING, PRIOR TO EXCAVATION.

5. PLACE ALL FOOTINGS ON FIRM, DRY, LEVEL, ACCEPTABLE BEARING SOIL.

6. FROST DEPTH FOR THIS PROJECT IS 4'-0" BELOW GRADE. FINISH GRADE SHALL BE MAINTAINED A MINIMUM OF 4'-0" ABOVE TOP OF FOUNDATIONS UNLESS NOTED OTHERWISE.

7. TOP OF FOOTING ELEVATIONS PROVIDED ON CONSTRUCTION DRAWINGS ARE FOR PURPOSES OF DESIGN. NOTIFY THE ENGINEER IF TOP OF FOOTING ELEVATIONS NEED TO BE ADJUSTED BASED ON CONTRACTOR'S FIELD COORDINATION OR GEOTECHNICAL ENGINEER'S RECOMMENDATIONS.

8. REMOVE AND DISPOSE OF LEGALLY FROM SITE; UNACCEPTABLE BEARING SOIL, EXCESS EXCAVATED MATERIAL, ASPHALT MATERIAL (SEE SITE PLANS).

9. WHERE FILL IS REQUIRED UNDER BEARING CONDITIONS, IT SHALL BE SELECTED AND PLACED IN ACCORDANCE WITH INSTRUCTIONS OF A QUALIFIED GEOTECHNICAL ENGINEER TO MAINTAIN DESIGN BEARING PRESSURE.

10. THE DESIGN OF WALLS RETAINING EARTH DOES NOT INCLUDE HYDROSTATIC PRESSURE LOADS UNLESS NOTED OTHERWISE, AND ASSUMES A DRAINAGE SYSTEM IS IN PLACE WHERE REQUIRED.

11. BACKFILL WITHIN BUILDING - TO WITHIN 6 INCHES OF UNDERSIDE OF FLOOR SLAB SHALL BE "SUBBASE COURSE" (NYS DOT 304.12 - TYPE 2) CONSISTING OF HARD DURABLE PEBBLES, ROCK FRAGMENTS AND SOIL BINDER. IT SHALL BE FREE OF CLAY, ORGANIC MATTER, AND OTHER DELETERIOUS MATERIAL. GRADATION: 2 INCHES MAXIMUM SIZE, 25-60% PASSING THE 1/4" SIEVE, 5-40% PASSING NO. 40 SIEVE, AND NOT MORE THAN 10% PASSING NO. 200 SIEVE.

12. UNDER SLABS ON GRADE - POROUS 6 INCH LIFT OF WASHED "CRUSHED STONES" CONSISTING OF: 50/50 MIX OF #1'S AND #2'S., ASTM #57 STONE.

13. BACKFILL OUTSIDE OF BUILDING - "SELECT GRANULAR FILL" (NYS DOT 203.07) CONSISTING OF SAND, FINE GRAVEL, COARSE SILT, OR SIMILAR NON-COHESIVE HARD DURABLE MATERIALS AND SOIL BINDERS WITHOUT EXCESSIVE CLAY, ORGANIC MATTER, OR FROZEN OR DELETERIOUS MATERIAL. GRADATION: 4 INCHES MAXIMUM SIZE, 0-70% PASSING THE #40 SIEVE AND 0-15% PASSING THE #200 SIEVE.

14. FILL COMPACTION: WITHIN BUILDING - 95% DRY DENSITY MODIFIED PROCTOR OUTSIDE OF BUILDING - 95% DRY DENSITY MODIFIED PROCTOR.

15. FILL PLACEMENT - BACKFILL SHALL NOT BE PLACED AGAINST WALLS UNTIL THE WALLS HAVE ACHIEVED SPECIFIED DESIGN STRENGTH. PLACE FILL SIMULTANEOUSLY ON EACH SIDE OF FOUNDATION WALL IN 6 INCH LIFTS. THE MAXIMUM DIFFERENCE IN ELEVATION ON EITHER SIDE OF WALL SHALL NOT EXCEED 1'-6".

16. STRUCTURAL STEEL FRAMING PROVIDES LATERAL RESTRAINT OF BASEMENT FOUNDATION WALLS. STEEL FRAMING AND DECKING SHALL BE IN PLACE PRIOR TO BACKFILLING. WHERE THIS CANNOT BE ACCOMMODATED THE WALL SHALL BE SHORED CONTINUALLY AND THE ENGINEER NOTIFIED.

CAST-IN-PLACE CONCRETE NOTES

1. ALL CONCRETE WORK, CONSTRUCTION AND REINFORCING DETAILS SHALL CONFORM TO THE 2020 BUILDING CODE OF NEW YORK STATE AND "THE SPECIFICATIONS OF THE AMERICAN CONCRETE INSTITUTE BUILDING CODE REQUIREMENTS" (ACI-318).

2. ALL CONCRETE SHALL ATTAIN A MINIMUM COMPRESSIVE STRENGTH OF 3000 PSI AT 28 DAYS AND CONFORM TO THE REQUIREMENTS OF THE SCHEDULE BELOW, UNLESS NOTED OTHERWISE. SEE SPECIFICATIONS FOR MIX DESIGN REQUIREMENTS.

LOCATION	W/C RATIO	SLUMP (±1")	% AIR (±1%)	MAXIMUM AGGREGATE	MIN. STRENGTH @ 28 DAYS
BURIED FOUNDATIONS	.50	3.5"	N/A	1 1/2"	3,500 PSI
EXPOSED RETAINING & FOUNDATION WALLS	.45	3.5"	5.5	1 1/2"	5,000 PSI
SLAB ON GRADE (INT.)	.45	3.5"	4	3/4"	3,000 PSI
SLAB ON GRADE (EXT.)	.45	3.5"	5.5	3/4"	5,000 PSI

3. CONTRACTOR SHALL SUBMIT MIX DESIGNS PROPORTIONED BY A LICENSED TESTING LABORATORY.

4. PROVIDE MINIMUM OF FOUR (4) CYLINDERS PER EACH FIFTY (50) YARDS OR FRACTION THEREOF POURED IN ONE DAY. BREAK ONE AT 7 DAYS AND TWO AT 28 DAYS.

5. WHERE NEW CONCRETE IS TO BE POURED ONTO EXISTING CONCRETE, BONDING IS REQUIRED AS NOTED IN ACI 301.

6. CONDUITS AND PIPES OF ALUMINUM SHALL NOT BE EMBEDDED IN CONCRETE.

REINFORCING STEEL:

1. ALL REINFORCING STEEL SHALL BE DETAILED, FABRICATED AND PLACED IN ACCORDANCE WITH "ACI MANUAL OF STANDARD PRACTICE FOR DETAILING CONCRETE STRUCTURES" (ACI-315).

2. REINFORCING STEEL SHALL CONFORM TO ASTM A-615 GRADE 60. WELDED WIRE FABRIC SHALL CONFORM TO ASTM A-185.

3. LAP SPLICES AND EMBEDMENT LENGTHS SHALL CONFORM TO ACI 318 -CHAPTER 12.

4. PROVIDE CORNER BARS TO MATCH HORIZONTAL REINFORCING WHERE FOOTINGS, WALLS OR BEAMS MEET AT CORNERS OR INTERSECT. THIS ALSO INCLUDES INTERSECTIONS OF CONCRETE WITH MASONRY WORK.

5. PROVIDE SHOP DRAWINGS FOR REINFORCING INCLUDING ALL NECESSARY ACCESSORIES TO HOLD REINFORCING SECURELY IN PLACE.

6. CLEAR COVER CONCRETE PROTECTION FOR REINFORCING STEEL SHALL BE:

6.1. 3" - CONCRETE CAST AGAINST EARTH.

6.2. 2" - FORMED SURFACES IN CONTACT WITH SOIL OR EXPOSED TO WEATHER.

6.3. 1" - FORMED SURFACES NOT IN CONTACT WITH SOIL OR EXPOSED TO WEATHER. 3/4" - SUPPORTED FLOOR SLABS.

FOUNDATIONS:

7. ALL FOUNDATIONS ARE TO BEAR ON APPROVED BEARING MATERIAL. (SEE GEOTECHNICAL EVALUATION BY EMPIRE GEOTECHNICAL ENGINEERING SERVICES, DATED SEPTEMBER 2019).

8. ALL FOUNDATION EXCAVATIONS ARE SUBJECT TO APPROVAL BY THE OWNER'S REPRESENTATIVE BEFORE ANY CONCRETE IS PLACED.

9. ALL FORMS AND REINFORCING STEEL IN PLACE SHALL BE APPROVED BY THE OWNER'S REPRESENTATIVE BEFORE ANY CONCRETE IS PLACED.

10. NO FOUNDATION SHALL BE PLACED IN WATER OR ON FROZEN GROUND.

11. IN GENERAL, EXTERIOR CONSTRUCTION SHALL BE CARRIED DOWN A MINIMUM OF 4'-0" BELOW FINISHED EXTERIOR GRADE.

12. CENTERLINE OF FOOTINGS, WALLS, GRADE BEAMS, COLUMNS, AND BEAMS SHALL COINCIDE, UNLESS OTHERWISE NOTED.

13. REFER TO ARCHITECTURAL DRAWINGS FOR FOUNDATION DRAINAGE.

14. ALL EXTERIOR CONCRETE USED ABOVE GRADE SHALL HAVE AN AIR ENTRAINING AGENT.

15. RUB ALL SIGHT EXPOSED CONCRETE AFTER FORMS HAVE BEEN REMOVED.

16. ALL EXPOSED CONCRETE PIER CORNERS SHALL BE CHAMFERED 3/4".

17. ALL GROUT FOR BASE PLATES SHALL BE NON-SHRINK WITH A MINIMUM COMPRESSIVE STRENGTH OF 5000 PSI AT 28 DAYS.

18. ANCHOR BOLTS - ASTM F1554, FY=36 KSI, 1" DIAMETER UNLESS OTHER WISE NOTED.

19. ISOLATION JOINT - ASPHALT IMPREGNATED FILLER STRIP CONFORMING TO ASTM D-944.

20. ALL STEEL COLUMNS BELOW GRADE SHALL BE TWICE COATED WITH A BITUMINOUS COATING.

21. CONTRACTOR SHALL VERIFY ALL DIMENSIONS ON THE JOB BEFORE COMMENCING WORK. REFER TO ARCHITECTURAL DRAWINGS FOR ANY DIMENSIONS AND DETAILS NOT SHOWN. REFER TO ARCHITECTURAL, MECHANICAL, AND ELECTRICAL DRAWINGS FOR LOCATION AND DIMENSIONS OF ANY OPENING, SLEEVES, INSERTS, SLAB DEPRESSIONS, ETC.

22. EPOXY ANCHORS SHALL BE HIT HY-200 INJECTION ADHESIVE ANCHORS AS MANUFACTURED BY HILTI, INC., TULSA OK (800-879-8000).

SLABS ON GRADE:

1. ALL SLABS ON GRADE SHALL BE PLACED OVER A STEGO 15 MIL VAPOR BARRIER. TAPE ALL SEAMS AND PROVIDE FLASHING/BOOTS AROUND PIPE PENETRATIONS.

2. UNDER SLABS ON GRADE: POROUS 6 INCH LIFT OF CRUSHED STONE MATERIAL CONSISTING OF 50/50 MIX OF #1'S AND #2'S., ASTM #57 STONE.

3. SLAB ON GRADE REINFORCEMENT SHALL BE 6X6-W2.1X2.1WWF, UNLESS NOTED OTHERWISE.

4. WET CURE FOR 7 DAYS BEFORE APPLYING ANY WHEELED TRAFFIC OR MASONRY PARTITIONS.

5. CONTRACTION JOINTS: JOINTS SHALL BE SPACED NO FARTHER THAN 15'-0" O.C. JOINTS SHALL TYPICALLY RUN BETWEEN COLUMNS AND TERMINATE AT A COLUMN ISOLATION POUR. THE LENGTH OF ANY INDIVIDUAL JOINTED AREA SHALL NOT EXCEED 1.5 TIMES ITS WIDTH.

6. CONSTRUCTION/COLD JOINTS: TERMINATE DAY'S CONCRETE WORK AT A CONTROL JOINT LOCATION. PROVIDE A KEYWAY OR DOWELS FOR CONTINUATION OF WORK WITH NEXT POUR. CONTINUE 50% OF SLAB REINFORCEMENT THROUGH CONSTRUCTION AND CONTRACTION JOINTS.

7. CONCRETE SURFACE SHALL BE HARD STEEL TROWEL FINISH.

8. FOR FLOOR FINISH, FLOOR DRAINS, SLAB DEPRESSIONS, AND WATERPROOFING DETAILS SEE ARCHITECTURAL DRAWINGS.


9. PROVIDE ONE #4 BAR, 4 FEET LONG, DIAGONAL AT CORNERS AND OPENINGS IN SLABS-ON-GRADE.

ALTERED ON:

07/30/2025

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


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REVISIONS

DATE	DESCRIPTION	BY	SYM.



Thruway
Authority

TITLE OF PROJECT
ADDITIONS TO MAINTENANCE
SECTION

LOCATION OF PROJECT
MANCHESTER
MP 340.15

TITLE OF DRAWING
STRUCTURAL NOTES

CONTRACT NUMBER:
TAS 25-9A

DATE:
07/30/2025

DRAWING NUMBER:
S801

DESIGN CRITERIA NOTES

T.A. NUMBER/DWG NUMBER
XXX
CHECKED BY: XXX
DRAFTED BY: XXX
CHECKED BY: XXX
DESIGNED BY: XXX
BUREAU DIRECTOR: J.L. MORRIS


1. GENERAL BUILDING CODE
THESE CONSTRUCTION DOCUMENTS ARE BASED ON THE REQUIREMENTS OF THE 2020 BUILDING CODE OF NEW YORK STATE.
2. RISK CATEGORY OF BUILDING AND OTHER STRUCTURES
THE BUILDING HAS BEEN ASSIGNED A RISK CATEGORY IN ACCORDANCE WITH PREVIOUSLY MENTIONED BUILDING CODE WITH THE FOLLOWING CRITERIA:
A. RISK CATEGORY: II, ALL BUILDINGS AND OTHER STRUCTURES EXCEPT THOSE LISTED IN RISK CATEGORIES I, III, IV.
3. DEAD AND LIVE LOADS
A. THE DEAD LOADS ARE THE SELF WEIGHT OF MATERIALS OF CONSTRUCTION INCORPORATED INTO AND ON THE BUILDING.
B. THE UNIFORMLY DISTRIBUTED AND/OR CONCENTRATED LIVE LOADS USED IN THE DESIGN OF THE BUILDING ARE BASED ON THE FOLLOWING INTENDED USE OR OCCUPANCIES:
a. OFFICE: 50 PSF
b. ROOFS: 20 PSF / 300 LB ON MAINTENANCE SURFACE
4. ROOF SNOW LOAD DATA
SNOW LOADS ARE BASED ON CHAPTER 7 OF THE AMERICAN SOCIETY OF CIVIL ENGINEERS, MINIMUM DESIGN LOADS FOR BUILDINGS AND OTHER STRUCTURES, ASCE 7 AND THE FOLLOWING CRITERIA:
A. GROUND SNOW LOAD (Pg): 60 PSF
B. FLAT-ROOF SNOW LOAD (Pf): 42 PSF
C. SNOW EXPOSURE FACTOR (Ce): 1.0
D. SNOW LOAD IMPORTANCE FACTOR (Is): 1.0
E. THERMAL FACTOR (Ct): 1.0
F. SLOPE FACTOR (Cs):
G. SNOW DRIFT SURCHARGE LOADS (Pd): N/A
H. WIDTH OF SNOW DRIFTS (W): N/A
5. WIND DESIGN DATA
WIND PRESSURES ARE BASED ON CHAPTER 26 OF THE AMERICAN SOCIETY OF CIVIL ENGINEERS, MINIMUM DESIGN LOADS FOR BUILDINGS AND OTHER STRUCTURES, ASCE 7 AND THE FOLLOWING CRITERIA:
A. ULTIMATE DESIGN WIND SPEED (Vult): 110 MPH (3 SECOND GUST)
B. NOMINAL DESIGN WIND SPEED (Vasd): 85 MPH
C. RISK CATEGORY: II
D. WIND EXPOSURE CATEGORY: B
E. INTERNAL PRESSURE COEFFICIENT (GCPI): +0.18/-0.18
F. COMPONENTS AND CLADDING: SEE DIAGRAM


6. SEISMIC DESIGN DATA
THE STRUCTURE AND COMPONENTS OF THE BUILDING HAVE BEEN DESIGNED IN ACCORDANCE WITH THE PREVIOUSLY MENTIONED BUILDING CODE WITH THE FOLLOWING CRITERIA:
A. RISK CATEGORY: II
B. SEISMIC IMPORTANCE FACTOR, Ie: 1.0
C. 0.2 SEC. MAPPED SPECTRAL ACCELERATION (Ss): 0.163G
D. 1 SEC. MAPPED SPECTRAL ACCELERATION (S1): 0.055G
E. SITE CLASS: C
F. 0.2 SEC SPECTRAL RESPONSE COEFF. (SDS): 0.142G
G. 1 SEC SPECTRAL RESPONSE COEFF. (SD1): 0.055G
H. SEISMIC DESIGN CATEGORY: A
I. BASIC SEISMIC-FORCE RESISTING SYSTEM: ORDINARY REINFORCED CONCRETE SHEAR WALLS
J. DESIGN SEISMIC BASE SHEAR (KIPS): 5
K. ANALYTICAL PROCEDURE: EQUIVALENT LATERAL FORCE PROCEDURE (ELFP)
7. SEISMIC DEMANDS ON NONSTRUCTURAL COMPONENTS
SEISMIC DEMAND ON NONSTRUCTURAL COMPONENTS AND CONNECTIONS OF THOSE COMPONENTS TO THE PRIMARY STRUCTURE SHALL BE DESIGNED IN ACCORDANCE WITH THE PREVIOUSLY MENTIONED BUILDING CODE, THE GENERAL SEISMIC CRITERIA LISTED ABOVE, AND THE REQUIREMENTS OF ASCE-7, CHAPTER 13 AS APPROPRIATE.
8. ROOF RAIN LOAD DATA
TIE DESIGN RAINFALL BASED ON THE 100 YEAR HOURLY RAINFALL RATE OR DETERMINED BY LOCAL WEATHER USED IN THE DESIGN OF THE BUILDING IS BASED ON THE FOLLOWING:
A. RAIN INTENSITY: 2.25 INCH
9. GEOTECHNICAL INFORMATION
THE STRUCTURE HAS BEEN DESIGNED BASED ON INFORMATION PROVIDED IN THE GEOTECHNICAL ENGINEERING REPORT BY EMPIRE GEO TECHNICAL ENGINEERING SERVICES (DATED: SEPTEMBER 2019) AND THE FOLLOWING CRITERIA:
A. ALLOWABLE BEARING: 2,000 PSF
10. FLOOD DESIGN CRITERIA
THE BUILDING IS NOT LOCATED IN WHOLE OR IN PART WITHIN A FLOOD HAZARD AREA AS ESTABLISHED PER THE PREVIOUSLY MENTIONED BUILDING CODE.
11. HANDRAILS AND GUARDS
THE HANDRAIL ASSEMBLIES AND GUARDS SHALL BE DESIGNED FOR 50 PLF OR A CONCENTRATED LOAD OF 200 POUNDS AT ANY POINT APPLIED IN ANY DIRECTION AT THE TOP AND TO TRANSFER THIS LOAD THROUGH THE SUPPORTS TO THE STRUCTURE. THESE LOADS NEED NOT BE ASSUMED TO ACT CONCURRENTLY.

12. INTERIOR WALLS AND PARTITIONS
INTERIOR WALLS AND PARTITIONS THAT EXCEED 6 FEET IN HEIGHT SHALL HAVE ADEQUATE STRENGTH TO RESIST LOADS THEY ARE SUBJECT TO, BUT NOT LESS THAN A HORIZONTAL UNIFORM LOAD OF 5 PSF.
13. FUTURE EXPANSION
NO PROVISIONS HAVE BEEN MADE IN THE STRUCTURAL DESIGN FOR FUTURE HORIZONTAL OR VERTICAL BUILDING EXPANSIONS.
14. RESTRAINED CONSTRUCTION CLASSIFICATION
IN ACCORDANCE WITH ASTM E 119, ALL FLOOR CONSTRUCTION IS CLASSIFIED AS RESTRAINED CONSTRUCTION.
15. ROOF TOP EQUIPMENT ANCHORAGE
ALL ROOF TOP EQUIPMENT CURBS, MECHANICAL EQUIPMENT, TIE DOWNS, AND CONNECTIONS OF ALL EQUIPMENT TO BUILDING STRUCTURE FOR WIND AND SEISMIC LOADING ARE TO BE DESIGNED BY A REGISTERED PROFESSIONAL ENGINEER RETAINED BY THE EQUIPMENT SUPPLIER.

OPEN WEB STEEL JOIST NOTES



1. ALL STEEL OPEN WEB JOISTS SHALL BE DESIGNED, FABRICATED, AND ERECTED IN ACCORDANCE WITH THE "STANDARD SPECIFICATIONS" OF THE STEEL JOIST INSTITUTE (SJI).
2. DESIGN AND INSTALLATION OF BRIDGING SHALL CONFORM TO THE "STANDARD SPECIFICATIONS" OF THE STEEL JOIST INSTITUTE.
3. ALL JOISTS SHALL BE CONNECTED TO SUPPORTING STEEL BY (2) 1/4" FILLET WELDS x 3" LONG, OR TWO 3/4" ANCHOR BOLTS.
4. WHERE HVAC DUCTWORK INTERSECTS DIAGONAL BRIDGING LINES, PROVIDE HORIZONTAL BRIDGING AT TOP AND BOTTOM CHORDS AS FOLLOWS:
A. INSTALL DIAGONAL BRIDGING AS TYPICAL DURING INSTALLATION.
B. REMOVE DIAGONALS AFTER INSTALLATION AND INSTALL HORIZONTAL BRIDGING.
C. HORIZONTAL REPLACEMENT BRIDGING SHALL BE DESIGNED AND SUPPLIED BY JOIST MANUFACTURER.
D. REFER TO MECHANICAL DRAWINGS FOR LOCATION AND EXTENT OF OPENINGS.
E. AT NO TIME SHALL THIS BE DONE IN TWO CONSECUTIVE BAYS WITHOUT ENGINEER APPROVAL.
5. PROVIDE MINIMUM CAMBER TO JOISTS IN ACCORDANCE WITH THE STEEL JOIST INSTITUTE.
6. PROVIDE BOTTOM CHORD EXTENSIONS TO BOTTOM OF EXTERIOR BEAMS.
7. CONTRACTOR SHALL PROVIDE ANY AND ALL EXTRA STEEL TO FRAME AROUND ANY MECHANICAL ROOF PENETRATIONS. PROVIDE A MINIMUM OF TWO EXTRA JOISTS, SAME SIZES AS SHOWN ON DRAWINGS, FOR EACH AC UNIT LOCATION. SUBMIT PROPOSAL TO ENGINEER FOR REVIEW.
8. CONTRACTOR SHALL SUBMIT SHOP DRAWINGS FOR REVIEW.
9. JOISTS SHALL BE DESIGNED TO SUPPORT A SINGLE CONCENTRATED LOAD OF 300 LBS APPLIED AT ANY BOTTOM CHORD PANEL POINT.
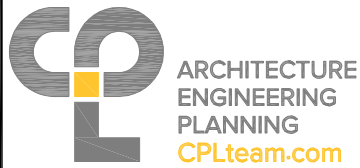
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REVISIONS			
DATE	DESCRIPTION	BY	SYM.


 	TITLE OF PROJECT ADDITIONS TO MAINTENANCE SECTION	CONTRACT NUMBER: TAS 25-9A
	LOCATION OF PROJECT MANCHESTER MP 340.15	DATE: 07/30/2025
	TITLE OF DRAWING STRUCTURAL NOTES	DRAWING NUMBER: S802

TA NUMBER/DWGSDWG NUMBER
CHECKED BY: XXX
DRAFTED BY: XXX
CHECKED BY: XXX
DESIGNED BY: J.L. MORRIS
BUREAU DIRECTOR: J.L. MORRIS

COMPONENTS AND CLADDING DESIGN PRESSURES				
ZONE	EFFECTIVE WIND AREA			
	10 SQ. FT.	20 SQ. FT.	50 SQ. FT.	100 SQ. FT.
1	16.0 / -28.45 PSF	16.0 / -26.6 PSF	16.0 / -24.1 PSF	16.0 / -22.2 PSF
1'	16.0 / -16.318 PSF	16.0 / -16.3 PSF	16.0 / -16.3 PSF	16.0 / -16.3 PSF
2	16.0 / -37.474 PSF	16.0 / -35.1 PSF	16.0 / -31.9 PSF	16.0 / -29.5 PSF
3	16.0 / 51.086 PSF	16.0 / -46.4 PSF	16.0 / -39.9 PSF	16.0 / -35.1 PSF
4	17.876 / -19.352 PSF	17.0 / -18.5 PSF	16.0 / -17.5 PSF	16.0 / -16.7 PSF
5	17.876 / -23.862 PSF	17.0 / -22.5 PSF	16.0 / -20.2 PSF	16.0 / -18.5 PSF
OVERHANG 1 & 1'	-25.748 PSF	-25.3 PSF	-24.7 PSF	-24.2 PSF
OVERHANG 2	-34.8 PSF	-31.6 PSF	-27.3 PSF	-24.1 PSF
OVERHANG 3	-48.4 PSF	-42.8 PSF	-35.4 PSF	-29.7 PSF

SCHEDULE NOTES:

- ALL DESIGN WIND PRESSURE VALUES ARE TAKEN FROM ASCE 7, CHAPTER 30.
- ALL WIND PRESSURES ARE TO BE CONSIDERED AS ULTIMATE VALUES.
- PRESSURES SHOWN ARE APPLIED NORMAL TO THE SURFACE. PLUS AND MINUS SIGNS SIGNIFY PRESSURES ACTING TOWARD AND AWAY FROM THE SURFACE, RESPECTIVELY.
- DISTANCE 'a' SHALL BE 3'-0" FOR ALL INSTANCES SHOWN IN DIAGRAMS.
- HEIGHT 'h' SHALL BE 12'-0" FOR ALL INSTANCES SHOWN IN DIAGRAMS.
- FOR JOISTS ONLY: ROOF DEAD LOAD "D" = 15 PSF.
- SEE 'DESIGN CRITERIA NOTES' ON DRAWING S802 FOR OTHER PERTINENT INFORMATION.

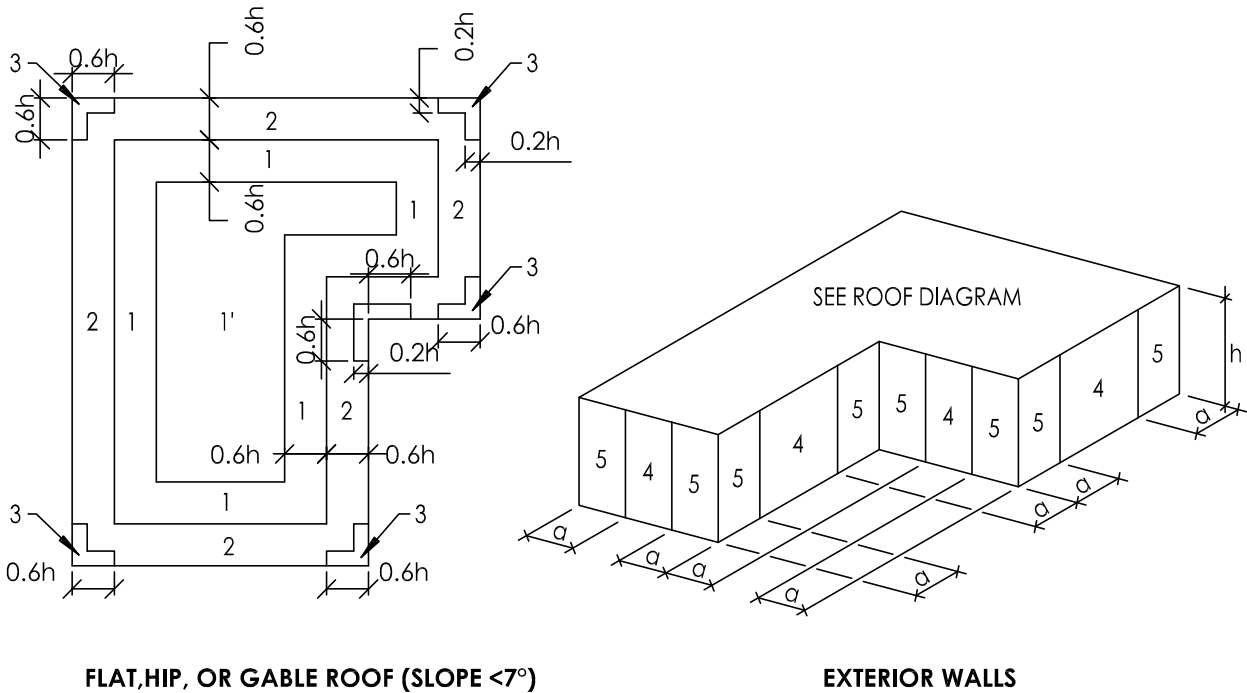


COMPONENT AND CLADDING PRESSURE ZONE DIAGRAMS
(FOR USE WITH SCHEDULE ABOVE)

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AFFIXED ON:
07/30/2025

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STAMP:

EXP. 12/31/2027

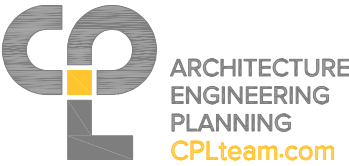


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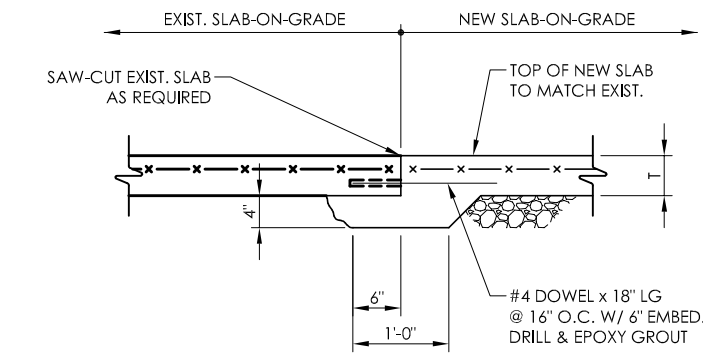
TITLE OF PROJECT ADDITIONS TO MAINTENANCE SECTION	CONTRACT NUMBER: TAS 25-9A
LOCATION OF PROJECT MANCHESTER MP 340.15	DATE: 07/30/2025
TITLE OF DRAWING COMPONENTS AND CLADDING	DRAWING NUMBER: S803

TA NUMBER/DWG NUMBER
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CHECKED BY: XXX
DRAFTED BY: XXX
CHECKED BY: XXX
DESIGNED BY: XXX
BUREAU DIRECTOR: J. L. MORRIS




DETAIL NOTES:
1. SEE PLANS FOR EXISTING AND PROPOSED WALL THICKNESS AND REINFORCING.
2. DETAIL SHALL BE USED UNLESS NOTED OTHERWISE ON DRAWINGS.


1
S804
NEW/EXISTING FOUNDATION WALL CONNECTION DETAIL
SCALE: 1/2" = 1'-0"

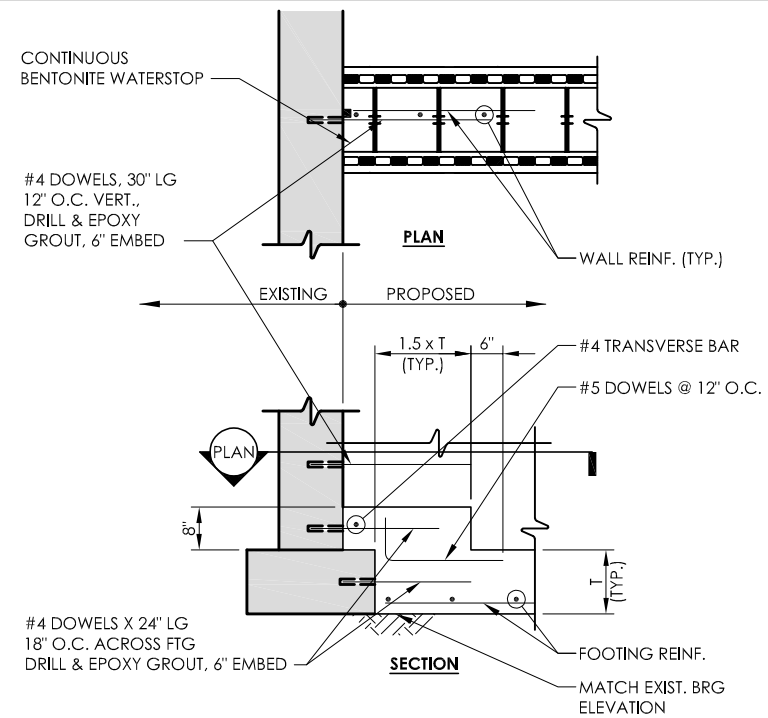

5
S804
NEW TO EXISTING SLAB-ON-GRADE CONNECTION DETAIL
SCALE: 1/2" = 1'-0"

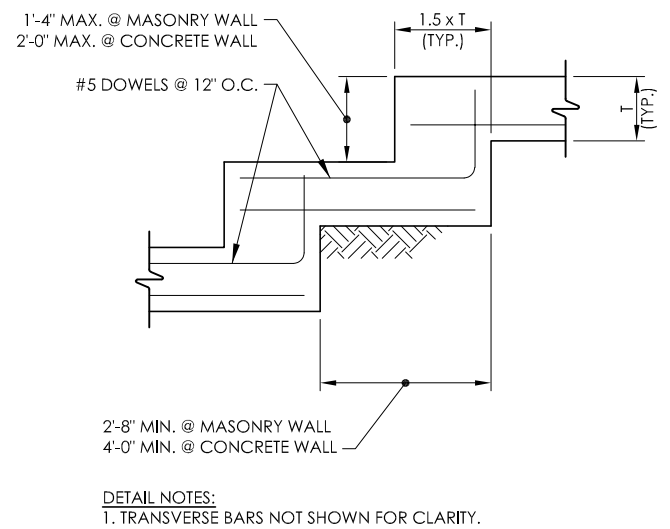


2
S804
STEPPED WALL FOOTING DETAIL
SCALE: 1/2" = 1'-0"

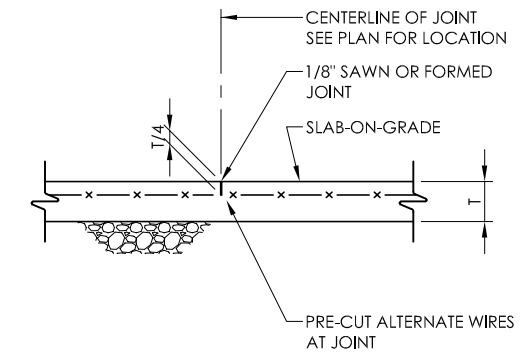


DETAIL NOTES:
1. REFER TO SPECIFICATIONS FOR PROPER JOINT CONSTRUCTION AND TIMING OF PLACEMENT.

6
S804
SLAB-ON-GRADE CONTROL JOINT DETAIL
SCALE: 1/2" = 1'-0"

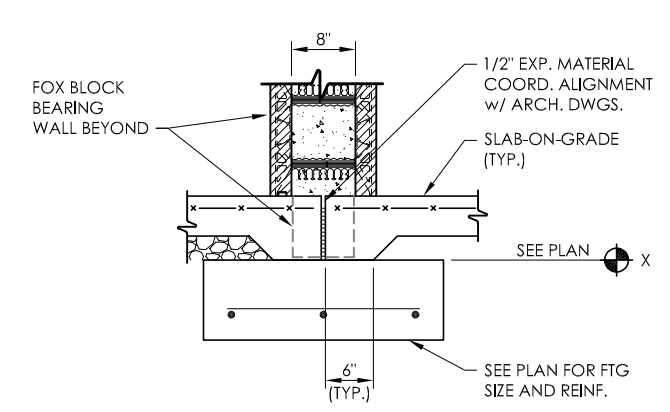


3
S804
INTERIOR THRESHOLD AT MASONRY OPENING DETAIL
SCALE: 1/2" = 1'-0"

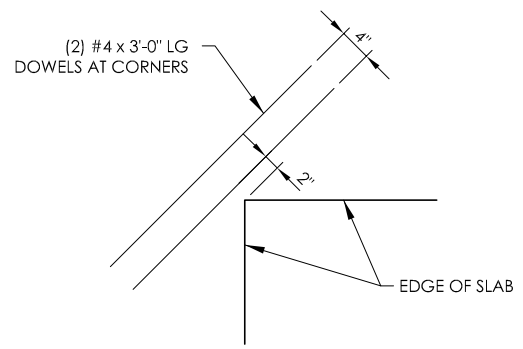


DETAIL NOTES:
1. THIS DETAIL SHALL ALSO OCCUR AT DOOR OPENINGS.
2. DOWELS SHALL BE LOCATED IN THE TOP OF THE SLAB, WHILE MAINTAINING PROPER COVER.

7
S804
SLAB-ON-GRADE REINFORCING AT RE-ENTRANT CORNERS DETAIL
SCALE: 1/2" = 1'-0"

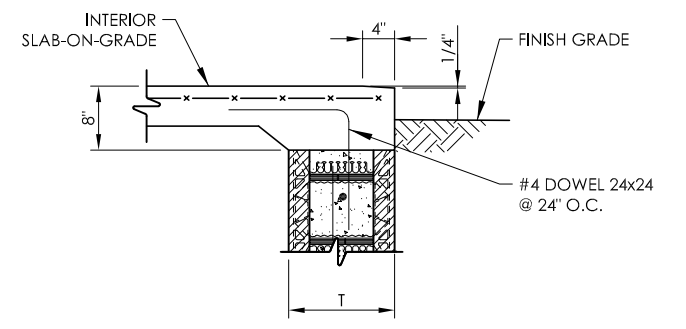

DETAIL NOTES:
1. COORDINATE LOCATION OF FRONT SLOPE WITH ARCHITECTURAL DRAWINGS.
2. REFER TO PLANS AND SECTIONS FOR FURTHER INFORMATION.

4
S804
EXTERIOR THRESHOLD DETAIL
SCALE: 1/2" = 1'-0"

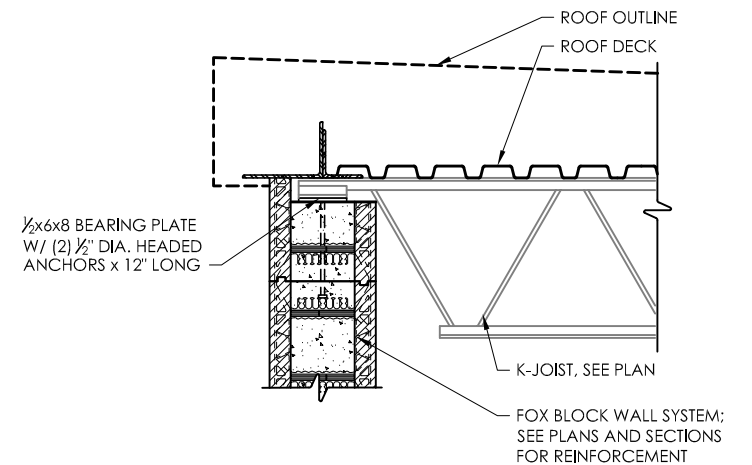

DETAIL NOTES:
1. COORDINATE JOIST CONNECTION METHOD WITH MANUFACTURER'S REQUIREMENTS.

8
S804
K-JOIST BEARING ON WALL DETAIL
SCALE: 1/2" = 1'-0"

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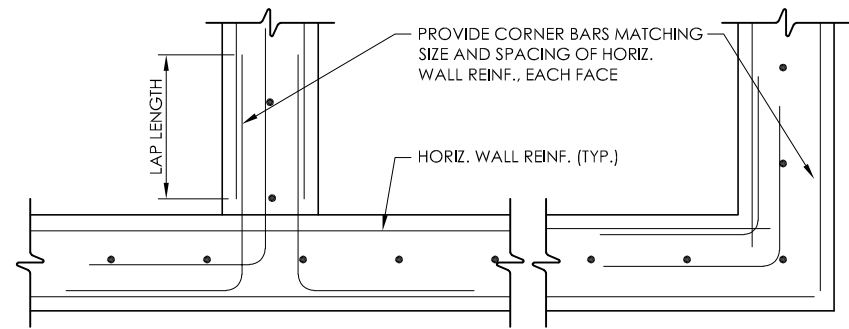
IT IS A VIOLATION OF LAW FOR ANY PERSON, UNLESS THEY ARE ACTING UNDER THE DIRECTION OF A LICENSED PROFESSIONAL ENGINEER, ARCHITECT, LANDSCAPE ARCHITECT, OR LAND SURVEYOR, TO ALTER AN ITEM IN ANY WAY. IF AN ITEM BEARING THE STAMP OF A LICENSED PROFESSIONAL IS ALTERED, THE ALTERING ENGINEER, ARCHITECT, LANDSCAPE ARCHITECT, OR LAND SURVEYOR SHALL STAMP THE DOCUMENT AND INCLUDE THE NOTATION "ALTERED BY" FOLLOWED BY THEIR SIGNATURE, THE DATE OF SUCH ALTERATION, AND A SPECIFIC DESCRIPTION OF THE ALTERATION.

REVISIONS			
DATE	DESCRIPTION	BY	SYM.



TITLE OF PROJECT ADDITIONS TO MAINTENANCE SECTION	CONTRACT NUMBER: TAS 25-9A
LOCATION OF PROJECT MANCHESTER MP 340.15	DATE: 07/30/2025
TITLE OF DRAWING TYPICAL DETAILS	DRAWING NUMBER: S804


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DESIGNED BY:
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BUREAU DIRECTOR: J. L. MORRIS



INTERSECTION CORNER


- DETAIL NOTES:
1. VERTICAL WALL REINFORCING NOT SHOW FOR CLARITY.
 2. SEE 'CONCRETE REINFORCING SPLICE AND EMBEDMENT' SCHEDULE FOR REQUIRED LAP LENGTHS.
 3. COORDINATE W/ FOX BLOCK MANUF. FOR ANY ADDITIONAL REQUIREMENTS.

1 CONCRETE WALL INTERSECTION AND CORNER DETAIL
SCALE: 1/2" = 1'-0"

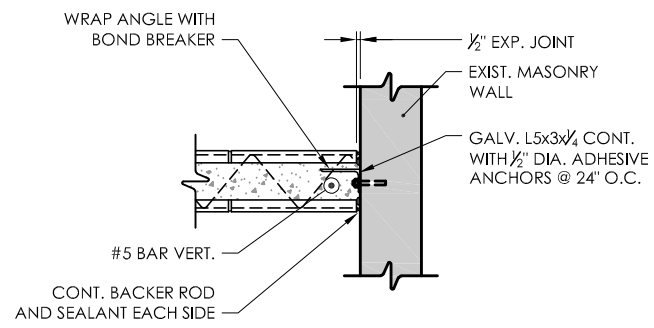


- DETAIL NOTES:
1. REFER TO PLANS AND DETAILS FOR REINFORCING AND PROJECT SPECIFICATIONS AND MANUFACTURER REQUIREMENTS FOR FURTHER FOX BLOCKWALL INFORMATION.

2 NEW / EXISTING MASONRY WALL CONNECTION DETAIL
SCALE: 1/2" = 1'-0"

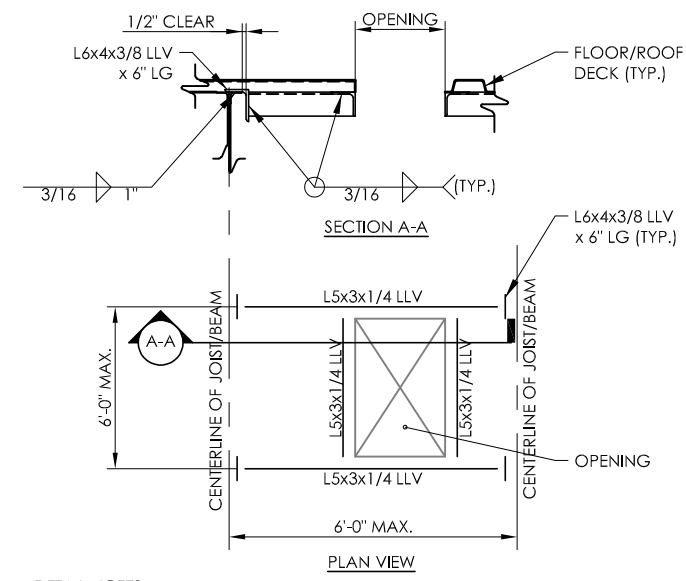


- DETAIL NOTES:
1. THE ABOVE STEEL SIZES SHALL BE USED UNLESS NOTED OTHERWISE ON THE PLANS.
 2. CONTRACTOR TO COORDINATE EQUIPMENT AND OPENING SUPPORTS WITH MECHANICAL CONTRACTOR AND FINAL APPROVED EQUIPMENT SUBMITTAL.

4 ROOF OR FLOOR OPENING SUPPORT DETAIL
SCALE: N.T.S.

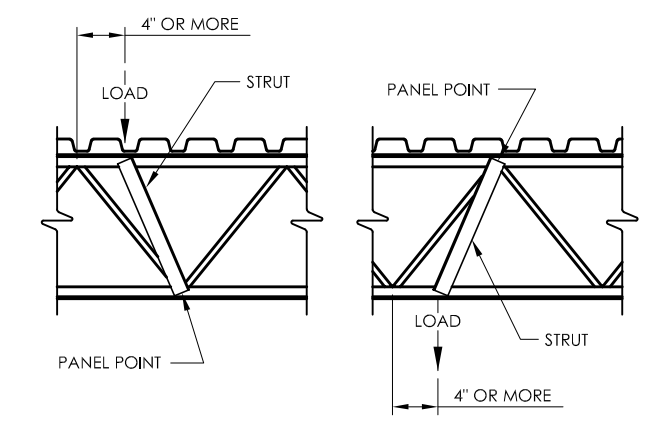

- DETAIL NOTES:
1. WHEN A CONCENTRATED LOAD EQUAL TO OR GREATER THAN 200 LBS. OCCURS 4" OR MORE FROM A PANEL POINT, A FIELD WELDED STRUT COMPOSED OF (2) L2x2x3/16 SHALL BE ADDED FROM THE POINT OF THE CONCENTRATED LOAD TO THE PANEL POINT ON THE OPPOSITE CHORD.

3 TYP. CONCENTRATED LOAD ON JOIST DETAIL
SCALE: 1/2" = 1'-0"

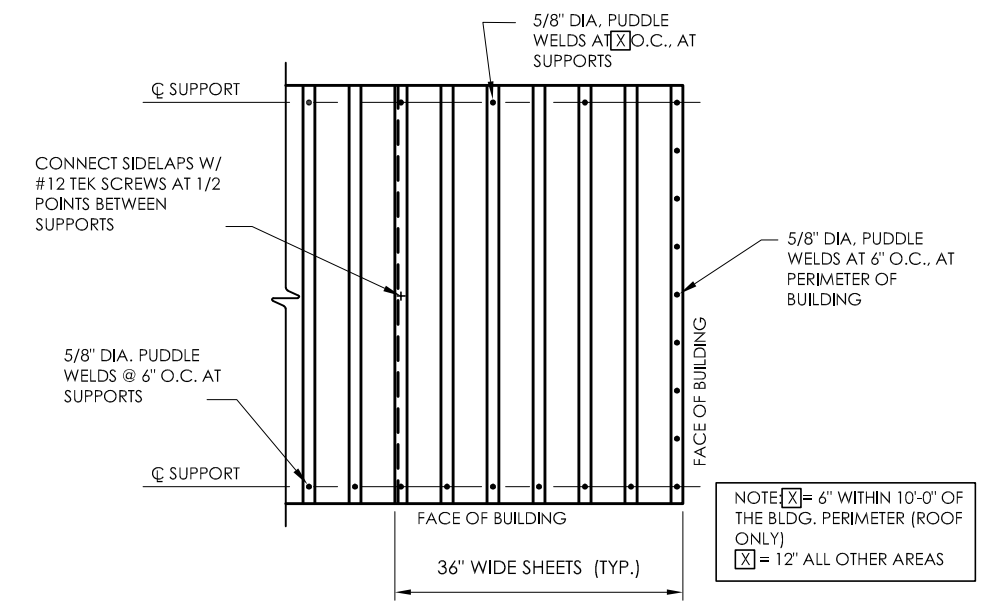

NOTE: [X] = 6" WITHIN 10'-0" OF THE BLDG. PERIMETER (ROOF ONLY)
[X] = 12" ALL OTHER AREAS

5 TYP. DECK ATTACHMENT DETAIL
SCALE: N.T.S.


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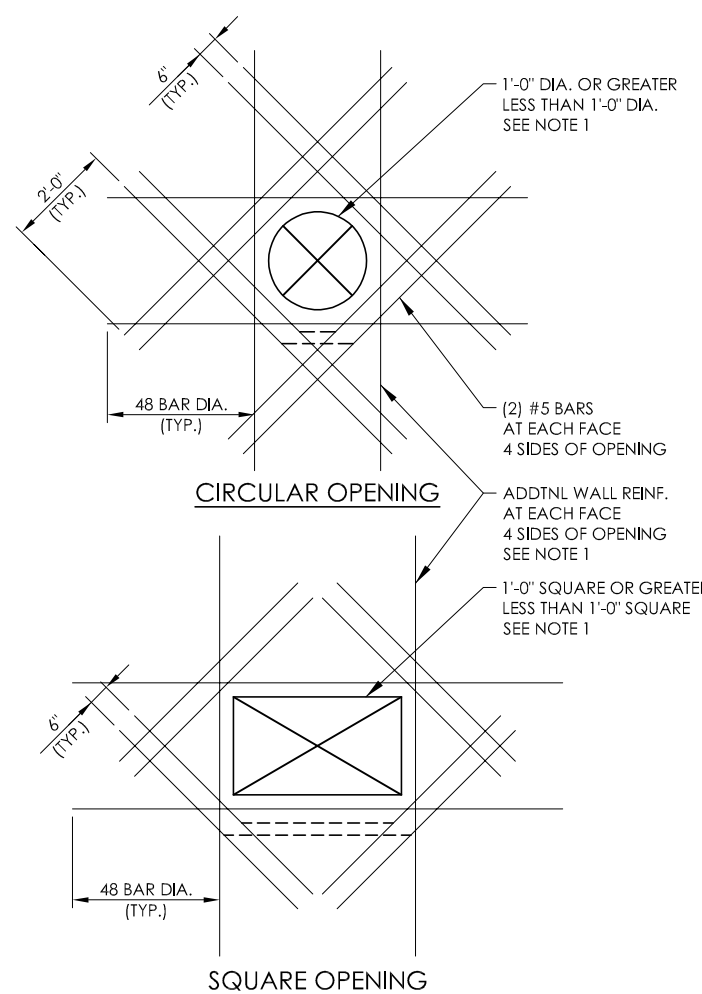
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LOCATION OF PROJECT MANCHESTER MP 340.15	DATE: 07/30/2025
TITLE OF DRAWING TYPICAL DETAILS	DRAWING NUMBER: S805


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CHECKED BY:
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DESIGNED BY:
J.L. MORRIS
BUREAU DIRECTOR:



DETAIL NOTES:
1. FOR OPENINGS WITH SIDES OR DIAMETERS LESS THAN 1'-0" THE WALL REINFORCING SHALL BE ADJUSTED TO CLEAR THE OPENING.
2. REFER TO "FOUNDATION WALL PIPE PENETRATION DETAIL" FOR FURTHER INFORMATION.



1 ADDITIONAL REINFORCING AT FOUNDATION WALL PENETRATION DETAIL

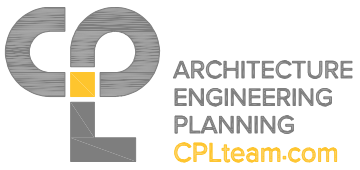SCALE: N.T.S.

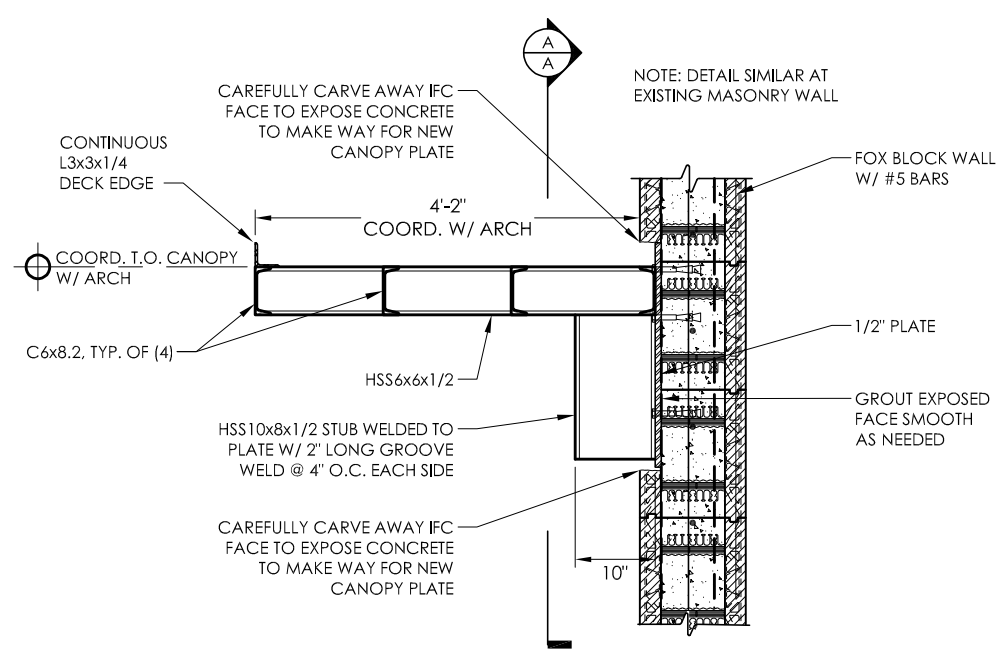

2 TYPICAL CANOPY DETAIL AND SECTION

SCALE: 1/2" = 1'-0" NOTE: DETAIL SIMILAR AT EXISTING MASONRY WALL

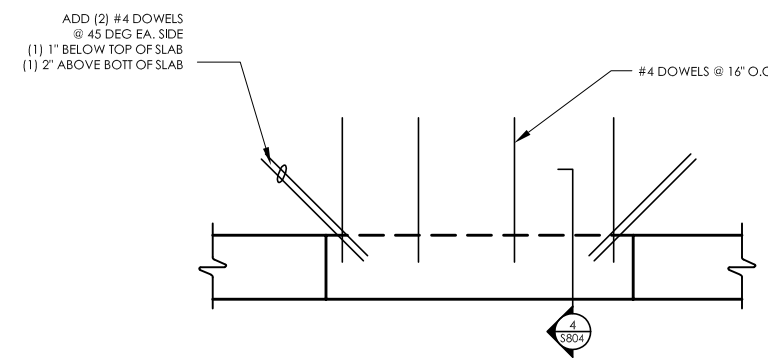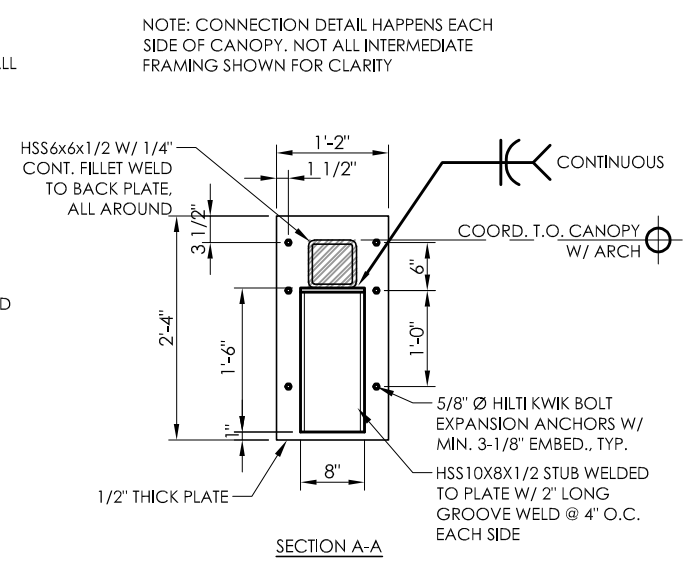

3 SLAB AT DOOR OPENING - JOINT AT SLAB EDGE

SCALE: 1/2" = 1'-0"

MASONRY REINFORCING LAP/EMBEDMENT SCHEDULE						
BAR SIZE, SI (METRIC)	4" CMU	6" CMU	8" CMU		12" CMU	
	1 BAR/CELL	1 BAR/CELL	1 BAR/CELL	2 BAR/CELL	1 BAR/CELL	2 BAR/CELL
#3 (#10)	19"	16"	16"	17"	16"	17"
#4 (#13)	34"	25"	21"	29"	21"	29"
#5 (#16)	NP	40"	27"	45"	26"	45"
#6 (#19)	NP	NP	51"	54"	40"	54"
#7 (#22)	NP	NP	63"	63"	46"	63"
#8 (#25)	NP	NP	72"	NP	63"	72"
#9 (#29)	NP	NP	NP	NP	81"	81"
#10 (#32)	NP	NP	NP	NP	NP	NP
#11 (#36)	NP	NP	NP	NP	NP	NP

SCHEDULE NOTES:
1. VALUES ARE BASED ON GRADE 60, UNCOATED REINFORCING, AND STANDARD BLOCK (f'm = 1500 PSI)
2. WHEN LAP SPlicing BARS OF DIFFERENT SIZES, LAP LENGTH IS DETERMINED BY THE SMALLER BAR.
3. VALUES ARE TO BE USED UNLESS NOTED OTHERWISE ON THE CONSTRUCTION DOCUMENTS.
4. FOR ALL OTHER CRITERIA, REFER TO PROJECT SPECIFICATIONS.
5. NP DENOTES "NOT PERMITTED"

4 FOX BLOCKS REINFORCEMENT SCHEDULE

SCALE: NTS

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LOCATION OF PROJECT MANCHESTER MP 340.15	DATE: 07/30/2025
TITLE OF DRAWING TYPICAL DETAILS	DRAWING NUMBER: S806

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CHECKED BY: XXX
DRAFTED BY: XXX
CHECKED BY: XXX
DESIGNED BY: J.L. MORRIS
BUREAU DIRECTOR: J.L. MORRIS

GENERAL CONSTRUCTION NOTES:


1. ALL DRAWINGS ARE GRAPHIC REPRESENTATION OF APPROXIMATE LOCATIONS OF EXISTING AND NEW MATERIALS. IT IS THE CONTRACTOR'S RESPONSIBILITY TO FIELD VERIFY ALL DIMENSIONS, QUANTITIES AND CONDITIONS IN FIELD. ANY DISCREPANCY BETWEEN THE CONSTRUCTION DOCUMENTS AND THE ACTUAL CONDITIONS SHALL BE REPORTED TO THE OWNERS REPRESENTATIVE AND ARCHITECT PRIOR TO BID.
2. CONTRACTOR SHALL VISIT THE SITE AND BECOME FAMILIAR WITH CONDITIONS PRIOR TO COMMENCING WORK. ALL DIMENSIONS AND CONDITIONS ARE TO BE VERIFIED ON FIELD. CONTRACTOR SHALL NOTIFY THE OWNERS REPRESENTATIVE OF ANY DISCREPANCIES FROM THE CONTRACT DOCUMENTS. IN CASE OF DISCREPANCIES BETWEEN THE CONTRACT DOCUMENTS AND ACTUAL FIELD CONDITIONS, THEY SHALL BE REPORTED TO OWNERS REPRESENTATIVE IN WRITING. WORK DONE AFTER THE DISCOVERY OF DISCREPANCIES AND PRIOR TO RECEIPT OF WRITING APPROVAL FOR CORRECTION SHALL BE CONSIDERED THE CONTRACTOR'S OVERSIGHT IN VERIFICATION OF EXISTING CONDITIONS.
3. THE CONTRACTOR IS RESPONSIBLE FOR DAMAGE TO ANY EXISTING FINISHES AND EQUIPMENT TO REMAIN. DAMAGE THAT OCCURRED AS A RESULT OF CONSTRUCTION ACTIVITIES SHALL BE REPAIRED TO THE OWNER/ARCHITECT'S SATISFACTION AT NO COST TO THE OWNER.
4. COORDINATE WITH OWNERS REPRESENTATIVE FOR ACCESS TO THE WORK AREA. THE WORK AREA SHALL BE FENCED AND KEPT SEPARATE FROM ADJACENT BUILDINGS ON OWNER'S SITE.
5. THE CONTRACTOR SHALL PERFORM HIS WORK SO THAT A MINIMUM OF DISRUPTION IS CAUSED TO THOSE PORTIONS OF THE STRUCTURE WHERE THERE IS NO NEW WORK TO BE DONE UNDER THIS CONTRACT. THE PROJECT WILL BE SUBJECT TO THE OPERATING HOURS APPROVED BY THE OWNER.
6. BUILDING EXITS SHALL BE KEPT READILY ACCESSIBLE AND UNOBSTRUCTED AT ALL TIMES.
7. ALL CONSTRUCTION DEBRIS AND REFUSE SHALL BE REMOVED FROM THE AREA OF WORK AT THE END OF EACH WORK DAY AND LEGALLY DISPOSED OF OFF THE PROPERTY. NO BURNING OF DEBRIS OR REFUSE ON SITE IS PERMITTED.
8. DO NOT LEAVE STRUCTURE OR PORTION THEREOF OPEN TO WEATHER NOR INADEQUATELY PROTECTED WHEN WORK IS NOT ACTUALLY IN PROGRESS.
9. DO NOT LOAD OR PERMIT ANY PART OF EXISTING BUILDING TO BE LOADED WITH ANY MATERIAL OR EQUIPMENT THAT MAY ENDANGER ITS STRUCTURAL INTEGRITY. MAINTAIN ACCESS TO OTHER BUILDINGS ON THE SITE AND ALL WALKWAYS SHALL BE KEPT CLEAR AND CLEAN AT ALL TIMES. PROVIDE TEMPORARY FENCE DURING CONSTRUCTION.
10. ANY CONSTRUCTION-RELATED SPILLS MUST BE REPORTED IMMEDIATELY TO TPE.
11. NO GAS-POWERED CONSTRUCTION EQUIPMENT SHALL BE USED INSIDE THE BUILDING PERIMETER.


TEMPORARY FACILITIES NOTES:

1. CONTRACTOR SHALL PROVIDE AN OFFICE TRAILER FOR THE NYSTA SITE EMPLOYEES FOR THE DURATION OF CONSTRUCTION. OFFICE TRAILER SHALL BE 60' X 12' AND INCLUDE BATHROOM FACILITY, ELECTRICITY, HEAT AND AIR CONDITIONING, PHONE, FAX, AND INTERNET CONNECTIONS. ACCESS STEPS/STAIRS TO THE TRAILER SHALL BE COMPLIANT WITH THE BUILDING CODE OF NYS. THE OFFICE TRAILER SHALL HAVE (5) WORK STATIONS. ONE STATION SHALL BE IN A PRIVATE ROOM WITH A DOOR. CONTRACTOR WILL BE RESPONSIBLE FOR ALL UTILITY HOOKUPS TO THE TRAILER, INCLUDING SEWER, AND FOR MAINTENANCE OF THEM.
2. CONTRACTOR SHALL PROVIDE BATHROOM AND LOCKER ROOM TRAILER FOR THE NYSTA CREW FOR THE DURATION OF CONSTRUCTION. CONTRACTOR WILL BE RESPONSIBLE FOR ALL UTILITY HOOKUPS TO THE TRAILER, INCLUDING SEWER, AND FOR MAINTENANCE OF THEM.
3. BOTH OFFICE AND BATHROOM TRAILERS MUST BE FULLY OPERATIONAL BEFORE WORK ON THE EXISTING BUILDING BEGINS.
4. MAINTAIN BATHROOM FACILITIES FOR JOB SITE EMPLOYEES.
5. MAINTAIN TRASH RECEPTACLES FOR JOB SITE EMPLOYEES.
6. MAINTAIN AND PROVIDE CONSTANT FLOW OF ALL UTILITIES TO OTHER BUILDINGS IN THE COMPLEX, INCLUDING THE MECHANICS' SHOP AND IMPRESS BUILDING.
7. ESTABLISH PROTECTIVE ZONES, BARRIERS, AND FENCES BETWEEN THE AREAS OF CONSTRUCTION/ CONSTRUCTION HAZARDS AND OTHER NON-AFFECTED AREAS ESSENTIAL FOR MAINTENANCE AND FUNCTIONING OF THE COMPLEX, I.E. THE SHOP AND AREAS OF THE YARD USED FOR STORAGE OR ASSEMBLY.
8. KEEP OPEN ACCESS (FRONT GATE) TO THE SITE AND PROVIDE EMPLOYEE SAFE ACCESS AREA TO ENTER THE COMPLEX.
9. KEEP CONSTRUCTION EQUIPMENT AND MATERIALS WITHIN WORK ZONE OR OFF-SITE UNLESS AGREED OTHERWISE WITH THE SECTION SUPERVISOR.
10. PROVIDE WEEKLY UPDATES ON CONSTRUCTION SCHEDULE TO THE SECTION SUPERVISOR, AND FINISH EXTERIOR WORK BY LABOR DAY WEEKEND, PRIOR TO THE SECTION STARTING SNOW AND ICE READINESS. THE PROJECT COMPLETION DATE IS 01/09/2026.

WINDOW REPLACEMENT NOTES:

1. THESE NOTES APPLY TO REPLACING WINDOWS IN EXISTING OFFICE AND IN EXISTING GARAGE.
2. OFFICE WINDOWS: CAREFULLY REMOVE AND SALVAGE EXISTING INTERIOR WOOD TRIM AS NECESSARY FOR WINDOWS REPLACEMENT. REINSTALL AFTER NEW WINDOWS ARE IN PLACE. PATCH AND REPAIR ALL ITEMS DAMAGED BY DEMOLITION OR NEW INSTALLATION ACTIVITIES.
3. PROVIDE ALL BLOCKING, SHIM, REPLACEMENT COVERS AND TRIM S REQUIRED FOR NEAT INSTALLATION OF NEW WINDOWS IN EXISTING OPENINGS. WHERE EXISTING COVERS OR TRIM ARE TO BE REMOVED PROVIDE NEW ALUMINUM COVERS AND TRIM TO MATCH NEW WINDOWS.
4. CAULK FULL WINDOW OPENINGS PERIMETER INSIDE AND OUTSIDE.
5. CLEAN AND PAINT EXISTING STEEL LINTELS WHETHER LINTELS ARE TO BE EXPOSED OR NOT.
6. AT EXISTING BRICK WALLS TO BE COVERED WITH METAL PANELS PROVIDE NEW METAL PANEL TRIM AROUND WINDOW OPENINGS. PROVIDE SILL TRIM WITH DRIP EDGE PROJECTING BEYOND THE EXTERIOR FACE OF METAL WALL PANELS.
7. AT EXISTING BRICK WALLS TO BE LEFT EXPOSED PROVIDE NEW ALUMINUM SILL FLASHING WITH DRIP EDGE TO PROJECT OVER EXISTING BRICK SILL.
8. CLEAN, REPAIR AND PAINT EXISTING CEMENT/ MASONRY/ STONE INTERIOR SILLS.

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Authority
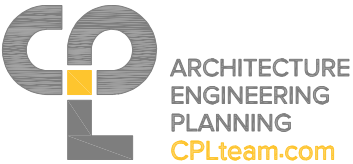
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LOCATION OF PROJECT MANCHESTER MP 340.15	DATE: 07/30/2025
TITLE OF DRAWING ARCHITECTURAL GENERAL NOTES	DRAWING NUMBER: GN-2

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CHECKED BY:
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DESIGNED BY:
J.L. MORRIS
BUREAU DIRECTOR:

GENERAL ASBESTOS ABATEMENT NOTES:

1. ALL DRAWINGS ARE GRAPHIC REPRESENTATIONS OF APPROXIMATE LOCATIONS OF MATERIALS TO BE ABATED. IT IS THE CONTRACTOR'S RESPONSIBILITY TO FIELD VERIFY EXISTING CONDITIONS AND TO REVIEW THE ASBESTOS INSPECTION SURVEYS (SPEC. SECTION 003126) PRIOR TO SUBMITTING A BID. IF THERE ARE ANY DISCREPANCIES WITH WHAT EXISTS TO WHAT IS INDICATED ON THE CONTRACT DOCUMENTS, THE CONTRACTOR SHALL REPORT SUCH SAID DISCREPANCIES TO THE ARCHITECT PRIOR TO SUBMITTING A BID. IT IS THE INTENT OF THIS PROJECT TO COMPLETELY REMOVE ASBESTOS CONTAINING MATERIALS (LOCATIONS AS INDICATED ON THE PLANS) AND TO PROVIDE A CLEAN & A.C.M. FREE WORK AREA POST-ABATEMENT.
2. THE CONTRACT DRAWING AND SPECIFICATIONS HAVE BEEN PREPARED FOR THE PURPOSE OF REPRESENTING THE SCOPE OF WORK AND ARE MEANT AS A GUIDE ONLY, AND DO NOT LIMIT THE ABATEMENT CONTRACTOR'S RESPONSIBILITY TO SEEK AND REMOVE ALL HAZARDOUS MATERIALS SPECIFIED.
3. DEMOLITION A100-SERIES DRAWINGS ARE DIAGRAMMATIC ONLY. THE ABATEMENT CONTRACTOR SHALL VERIFY ALL JOB SITE CONDITIONS, DIMENSIONS AND QUANTITIES.
4. ALL ABATEMENT PROCEDURES TO BE IN ACCORDANCE WITH STANDARDS SET FORTH BY N.Y.S.D.O.L. INDUSTRIAL CODE RULE 56 AND ALL OTHER APPLICABLE REGULATIONS. ANY HAZARDOUS MATERIALS MUST BE STORED ACCORDING TO THOSE RULES AND REGULATIONS.
5. THE CONTRACTOR IS RESPONSIBLE FOR DAMAGE TO ANY EXISTING FINISHES AND EQUIPMENT THAT ARE TO REMAIN. ANY DAMAGE SHALL BE REPAIRED AS DIRECTED BY OWNER AT NO ADDITIONAL COST.
6. THE CONTRACTOR IS RESPONSIBLE FOR NOTIFYING THE OWNER'S REPRESENTATIVE & ARCHITECT IMMEDIATELY IF ANY UNANTICIPATED ASBESTOS CONTAINING MATERIAL IS ENCOUNTERED DURING ABATEMENT.
7. THE CONTRACTOR SHALL NOT DISTURB ANY A.C.M. DURING PRE-ABATEMENT DEMOLITION ACTIVITIES.
8. THE CONTRACTOR SHALL COORDINATE LOCATION OF ASBESTOS DUMPSTER WITH OWNER'S REPRESENTATIVE. DUMPSTER SHALL BE AN ENCLOSED TYPE AND LOCKABLE.
9. THE ABATEMENT CONTRACTOR IS REQUIRED TO PROVIDE A DETAILED ASBESTOS REMOVAL AND DISPOSAL WORK PLAN IN ACCORDANCE WITH THE PROJECT SPECIFICATIONS PRIOR TO MOBILIZATION.

10. THE ABATEMENT CONTRACTOR HAS THE OPTION TO APPLY FOR AND UTILIZE NYSDOL SITE SPECIFIC VARIANCES FOR ALTERNATIVE ABATEMENT METHODS THAT ARE INCLUDED IN THE APPROVED DETAILED ASBESTOS REMOVAL AND DISPOSAL WORK PLAN.
11. PRIOR TO REGULATED ABATEMENT WORK AREA PREPARATION, THE ABATEMENT CONTRACTOR SHALL COORDINATE WITH THE GENERAL/ROOFING CONTRACTOR, THE NEW YORK STATE THRUWAY AUTHORITY (NYSTA) REPRESENTATIVE AND FACILITY PERSONNEL, REGARDING ANY SECURITY AND EGRESS ISSUES THAT MAY APPLY TO THE OVERALL PROTECTION AND SAFETY OF THE BUILDING AND OCCUPANTS.
12. THIS PROJECT WILL BE SUBJECT TO THE OPERATING HOURS OF THE FACILITY OR OTHER OPERATING HOURS AS OTHERWISE APPROVED BY NYSTA.
13. THE NYSTA AND NYSTA REPRESENTATIVES HAVE THE AUTHORITY TO STOP THE WORK AT ANY TIME IF WORK IS NOT CONDUCTED IN ACCORDANCE WITH THE SPECIFICATIONS AND APPLICABLE REGULATIONS. THE STOPPAGE OF WORK SHALL CONTINUE UNTIL CONDITIONS HAVE BEEN CORRECTED TO THE SATISFACTION OF NYSTA AND NYSTA'S REPRESENTATIVES. STANDBY TIME TO RESOLVE PROBLEMS SHALL BE AT THE ABATEMENT CONTRACTOR'S EXPENSE.

ABATEMENT TEMPORARY PROTECTION NOTES:


1. THE ABATEMENT CONTRACTOR IS INSTRUCTED TO UTILIZE THE LEAST DESTRUCTIVE MEANS AND METHODS POSSIBLE TO REMOVE ASBESTOS CONTAINING AND/OR ASBESTOS CONTAMINATED MATERIALS AND RESIDUE SO AS TO LEAVE THE SUBSTRATE WHOLE, STRUCTURALLY SOUND, AND NOT REQUIRING EXCESSIVE PATCHING OR REPLACEMENT PRIOR TO TEMPORARY ROOFING AND/OR NEW ROOF INSTALLATION. EXCESSIVE DAMAGE WILL BE THE RESPONSIBILITY OF THE ABATEMENT CONTRACTOR TO REPAIR, PATCH OR REPLACE ALL INADVERTENT DAMAGE.
2. TEMPORARY PROTECTION OF THE EXPOSED ROOF DECKING AND/OR FLASHING (POST REMOVAL) IS THE RESPONSIBILITY OF THE GENERAL/ ROOFING CONTRACTOR. THE ABATEMENT CONTRACTOR IS THEREFORE INSTRUCTED TO COORDINATE ALL ROOF FLASHING ABATEMENT ACTIVITIES WITH GENERAL/ROOFING CONTRACTOR IN ORDER TO MINIMIZE POTENTIAL EXPOSURE/WATER INFILTRATION.


DEMOLITION GENERAL NOTES:

1. VERIFY SCOPE OF DEMOLITION WORK IN FIELD .
2. PROTECT ADJACENT SURFACES NOT SCHEDULED FOR DEMOLITION AND REPAIR SURFACES DAMAGED AS A RESULT OF DEMOLITION WORK.
3. ALL CONSTRUCTION DEBRIS AND REFUSE SHALL BE REMOVED FROM THE AREA OF WORK AT THE END OF EACH WORK DAY AND LEGALLY DISPOSED OF OFF THE PROPERTY. NO BURNING OF DEBRIS OR REFUSE ON SITE IS PERMITTED.
4. PROTECT EXISTING EXTERIOR WALL MOUNTED LINES, METERS, AND DEVICES THAT ARE TO REMAIN. COORDINATE WITH OWNER FOR TEMPORARY REMOVAL OF EXISTING WALL MOUNTED LINES AND DEVICES. LINES AND DEVICES TO REMAIN SHALL BE TEMPORARILY SUPPORTED UNTIL THE INSTALLATION OF NEW CONSTRUCTION. CONTRACTOR SHALL BE RESPONSIBLE FOR REMOVAL OF EXISTING ABANDONED MATERIALS, EQUIPMENT, ETC. IN THE AREA OF WORK. ALL MATERIAL REMOVED SHALL BE LEGALLY DISPOSED OF.
5. EQUIPMENT AND FURNISHINGS TO BE SALVAGED WILL BE REMOVED BY OWNER PRIOR TO CONSTRUCTION.
6. REFER TO MECHANICAL, ELECTRICAL AND PLUMBING DRAWINGS FOR INFORMATION ON DEMOLITION OF MECHANICAL, ELECTRICAL AND PLUMBING ITEMS.
7. REFER TO CIVIL DEMOLITION PLAN FOR INFORMATION ON DEMOLITION OF SURROUNDING SITE.

ROOF DEMOLITION GENERAL NOTES:

1. CONTRACTOR IS RESPONSIBLE FOR FULL REMOVALS AS PER DRAWINGS AND SPECIFICATIONS
2. CONTRACTOR IS TO DISCONNECT, STORE AND REINSTALL ANY EXISTING BRACKETS, PLATES, CONDUIT, CABLES, EQUIPMENT, LIGHTNING PROTECTION, GROUNDING, LIGHTS, SIGNAGE, ETC. AS REQUIRED TO ACCOMPLISH NEW ROOFING WORK.
3. ALL DIMENSIONS AND QUANTITIES ARE APPROXIMATE. CONTRACTOR SHALL VERIFY ALL DIMENSIONS AND QUANTITIES IN FIELD. IN CASE OF DISCREPANCIES, CONTRACTOR SHALL NOTIFY OWNER'S REPRESENTATIVE IN WRITING IMMEDIATELY, PRIOR TO COMMENCEMENT OF WORK.
4. CONTRACTOR SHALL PROVIDE EXTERIOR STAIR / SCAFFOLDING SYSTEM FOR WORK CREW TO ACCESS ROOFTOP.
5. CONTRACTOR IS REQUIRED TO INSTALL A DEBRIS CHUTE FOR REMOVAL ACTIVITIES AND A HOIST SYSTEM TO TRANSPORT MATERIALS FROM THE GROUND FLOOR TO THE ROOF.
6. CONTRACTOR IS TO REPAIR ALL DEFICIENCIES AT EXISTING ROOF DECK AS EXISTING CONDITIONS REQUIRE, AND AS RECOMMENDED BY ROOFING SYSTEM MANUFACTURER IN ORDER TO RECEIVE THE NEW ROOFING SYSTEM . ROOF DECK SHALL BE ACCEPTED BY ROOFING MANUFACTURER IN WRITING.
7. TEST EXISTING DRAIN PIPING TO THE HOUSE TRAP BEFORE THE START OF DEMOLITION WORK & PROVIDE REPORT. TEST AGAIN AT THE CONCLUSION OF CONSTRUCTION AND REMOVE ANY OBSTRUCTIONS IDENTIFIED DURING EITHER TEST.
8. PROTECT EXISTING DRAINS DURING DEMOLITION & CONSTRUCTION WORK.
9. PROTECT ANY EXISTING LIGHT FIXTURES, CONDUITS, JUNCTION BOXES AND WIRING DURING DEMOLITION AND CONSTRUCTION.
10. PROVIDE TEMPORARY SUPPORT TO ANY EXISTING DUCTS AS FIELD CONDITIONS REQUIRE.
11. RELOCATE ANY EXISTING CONDUITS, JUNCTION BOXES AND WIRING TO ACCEPT NEW INSULATION HEIGHT.
12. PATCH ALL HOLES FROM REMOVAL WORK WITH MATERIAL AND FINISH TO MATCH MATERIAL AND FINISH AT ADJACENT TO PATCHING WORK AREA.

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SIGNATURE: STAMP:	SIGNATURE: STAMP: 

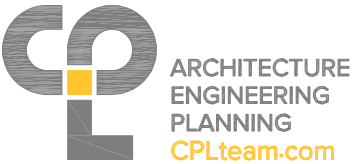

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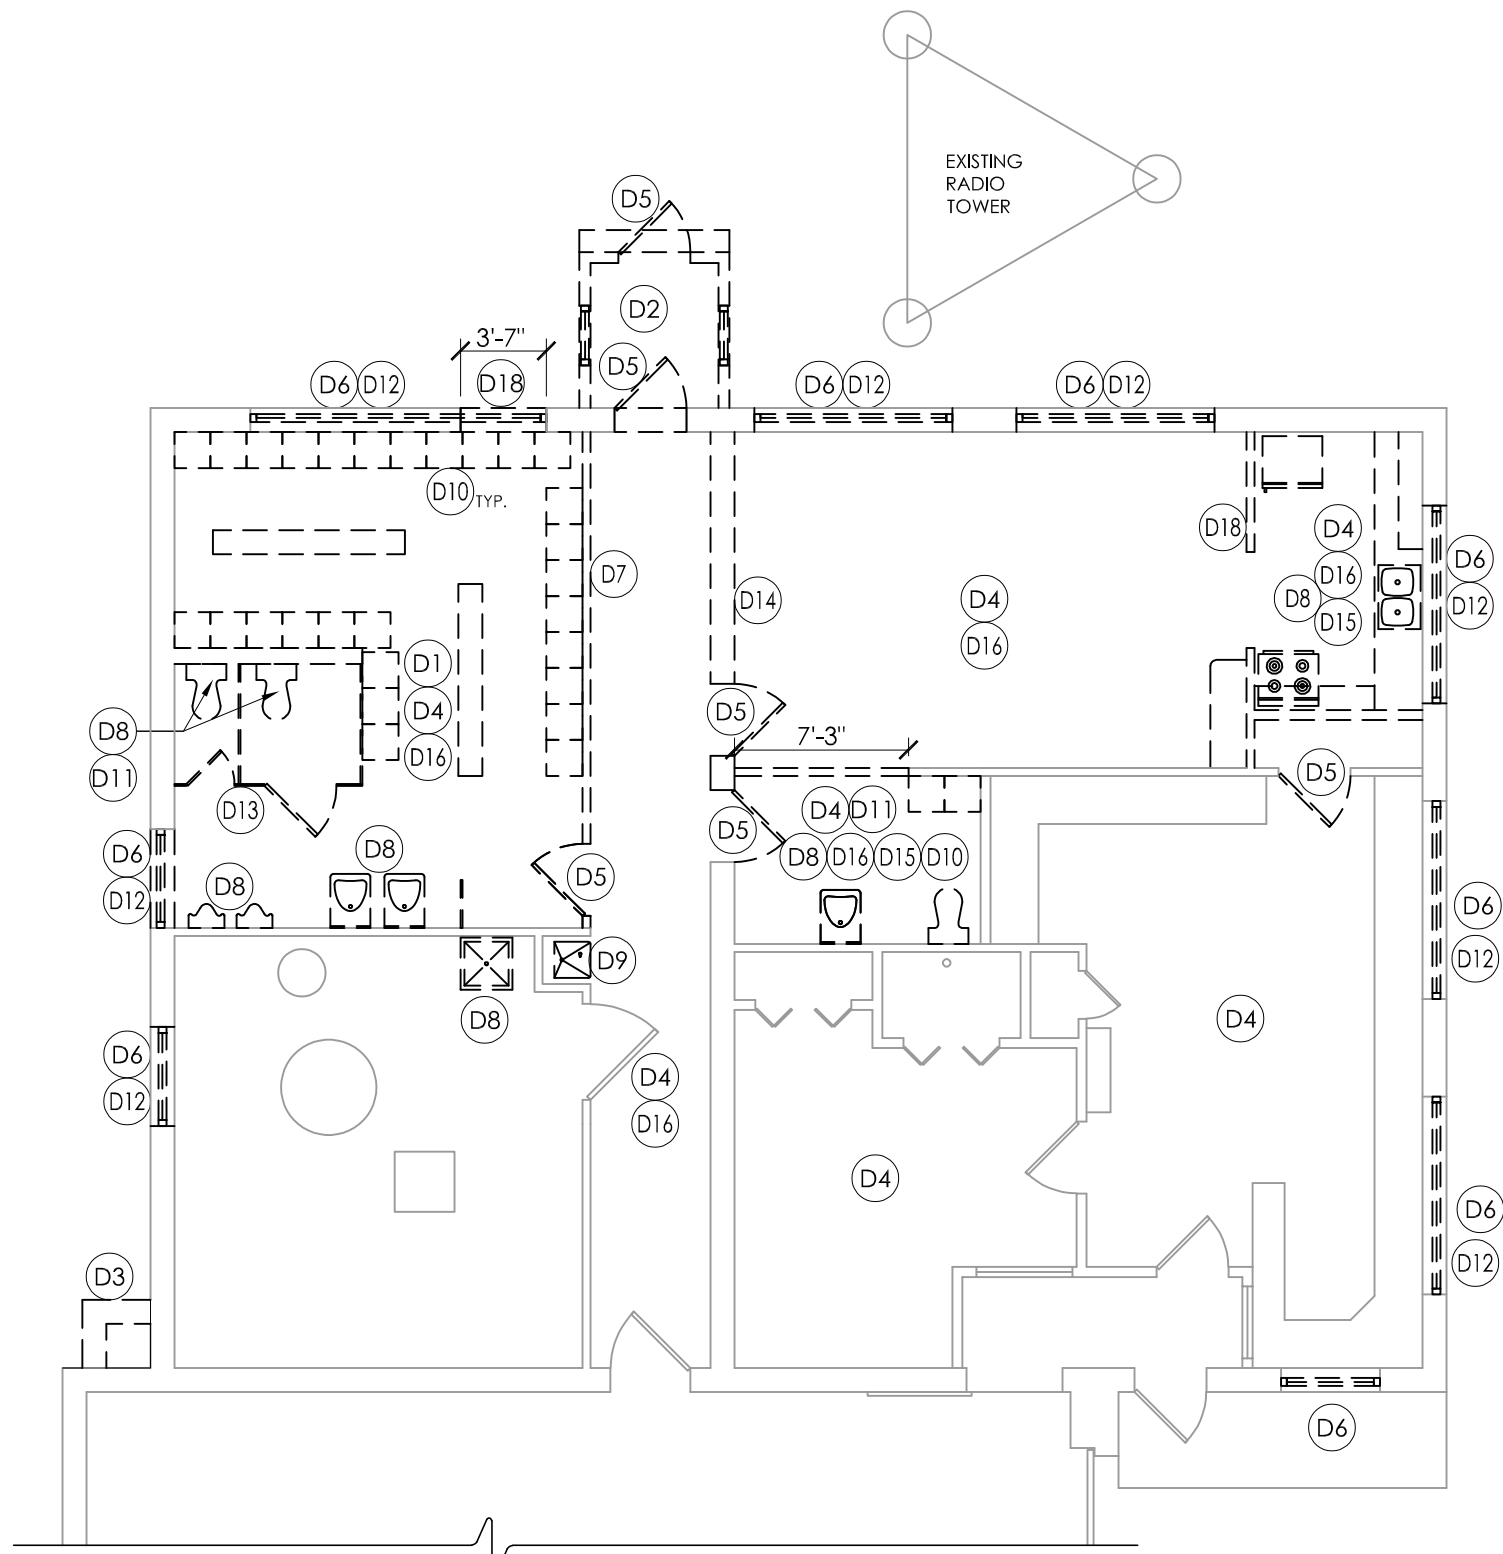
REVISIONS			
DATE	DESCRIPTION	BY	SYM.



TITLE OF PROJECT ADDITIONS TO MAINTENANCE SECTION	CONTRACT NUMBER: TAS 25-9A
LOCATION OF PROJECT MANCHESTER MP 340.15	DATE: 07/30/2025
TITLE OF DRAWING DEMOLITION AND ABATEMENT NOTES	DRAWING NUMBER: GN-3

DEMOLITION KEY NOTES

- D1 REMOVE PORTION OF CONCRETE FLOOR SLAB AS REQUIRED FOR INSTALLATION OF NEW UNDER-SLAB PLUMBING.
- D2 REMOVE ENTRY VESTIBULE ENCLOSURE INCLUDING SLAB
- D3 REMOVE BRICK CHIMNEY IN ITS ENTIRETY INCLUDING FOUNDATION. CLEAN AND PATCH EXPOSED EXISTING BRICK WHERE IT IS NOT SCHEDULED TO BE COVERED BY METAL PANELS.
- D4 REMOVE EXISTING CEILING
- D5 REMOVE DOOR, FRAME AND HARDWARE.
- D6 REMOVE EXTERIOR WINDOW.
- D7 REMOVE MASONRY PARTITION FULL HEIGHT.
- D8 REMOVE PLUMBING FIXTURES AND ASSOCIATED PIPING, REFER TO PLUMBING DEMOLITION.
- D9 REMOVE DRINKING FOUNTAIN
- D10 REMOVE LOCKERS AND LOCKER BASE.
- D11 REMOVE TOILET ROOM ACCESSORIES.
- D12 REMOVE PORTION OF BRICK SILL TO BE FLUSH WITH WALL BELOW.
- D13 REMOVE TOILET PARTITIONS
- D14 REMOVE PORTION OF LOAD BEARING MASONRY WALL. PROVIDE TEMPORARY SUPPORT FOR ROOF CONSTRUCTION.
- D15 REMOVE MILLWORK.
- D16 REMOVE EXISTING FLOORING DOWN TO CONCRETE SLAB BELOW.
- D17 REMOVE EXISTING OH DOOR OPERATOR AND ASSOCIATED ITEMS.
- D18 REMOVE SILL AND WALL BELOW EXTERIOR WINDOW TO SLAB.



REF N 1 **DEMOLITION PLAN**
A101 SCALE: 1/8" = 1'-0"

TA NUMBER/DWG NUMBER: XXX
CHECKED BY: XXX
DRAFTED BY: XXX
CHECKED BY: XXX
DESIGNED BY: J.L. MORRIS
BUREAU DIRECTOR: J.L. MORRIS

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REVISIONS			
DATE	DESCRIPTION	BY	SYM.

TITLE OF PROJECT
ADDITIONS TO MAINTENANCE SECTION

LOCATION OF PROJECT
MANCHESTER
MP 340.15


TITLE OF DRAWING
DEMOLITION FLOOR PLAN

CONTRACT NUMBER:
TAS 25-9A

DATE:
07/30/2025

DRAWING NUMBER:
A101

TA NUMBER/DWGSDWG NUMBER
XXX
CHECKED BY:
XXX
DRAFTED BY:
XXX
CHECKED BY:
XXX
DESIGNED BY:
J.L. MORRIS
BUREAU DIRECTOR:

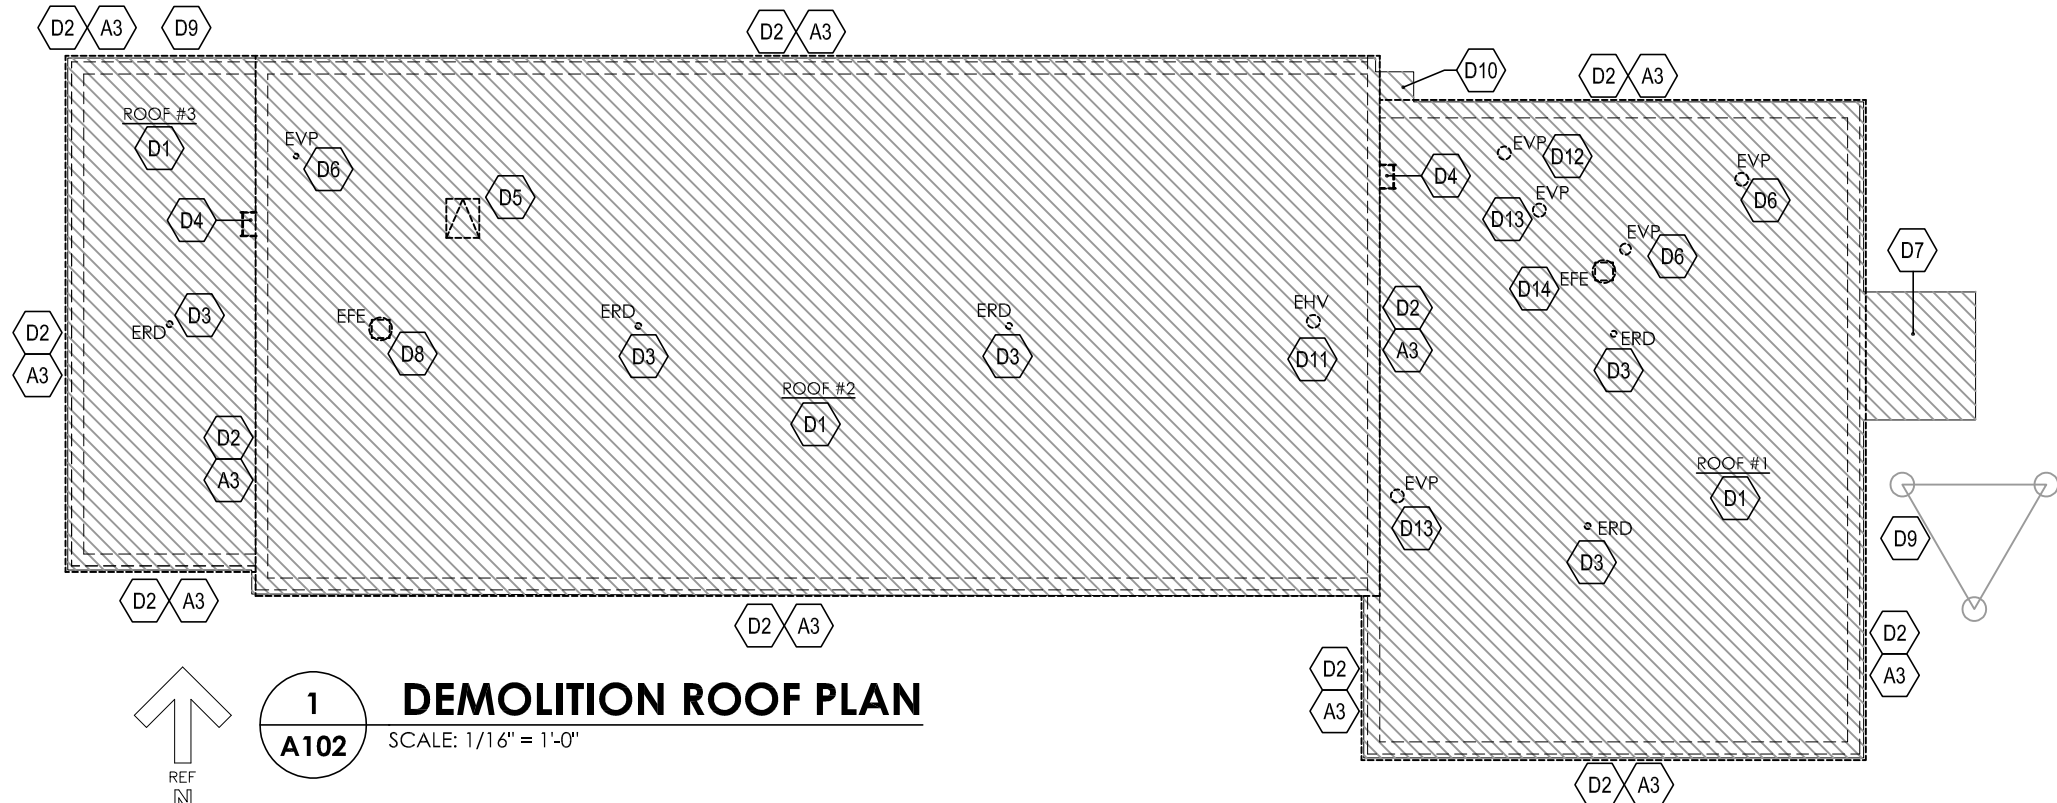

DEMOLITION ROOF PLAN

SCALE: 1/16" = 1'-0"

LEGEND

D1	DEMOLITION KEY NOTE	EFE	EXISTING ROOF FAN LOCATION
	AREA OF REMOVALS	EVP	EXISTING VENT PIPE LOCATION
----	REMOVAL WORK	ERD	EXISTING ROOF DRAIN TO LOCATION
		EHV	EXISTING HOT VENT LOCATION


- D1** ROOFING SYSTEM REMOVAL
REMOVE EXISTING ROOFING SYSTEM, BASE AND CAP FLASHING TO CONCRETE SUBSTRATE. PROVIDE TEMPORARY ROOF PROTECTION AS REQUIRED.
- D2** FASCIA REMOVAL
REMOVE ENTIRE METAL FASCIA ASSEMBLY AND RELATED ACCESSORIES. REFER TO DETAIL 2/A801.
- D3** REMOVAL AT ROOF DRAIN
REMOVE EXISTING STRAINER & CLAMPING RING AT ROOF DRAIN.
- D4** LADDER REMOVAL
REMOVE EXISTING ROOF LADDER AND ANCHORAGE. REFER TO DETAILS 1,3/A804.
- D5** ROOF HATCH REMOVAL
REMOVE EXISTING HATCH IN ITS ENTIRETY, INCLUDING ROOF CURB. REFER DETAIL 2/A802.
- D6** VENT PIPE FLASHING.
REMOVE EXISTING FLASHING AT VENT THROUGH ROOF.
- D7** EXISTING ENTRY VESTIBULE
REMOVE EXISTING METAL ROOF AND STRUCTURE.
- D8** MECHANICAL CURB FLASHING
REMOVE EXISTING FLASHING AT MECHANICAL CURB.
- D9** ADJACENT ITEMS TO REMAIN :
PROTECT EXISTING INSTALLATIONS (ANTENNAS, VENT, CONDUIT AND WALL MOUNTED LIGHT) PROJECTING ABOVE THE ROOF DURING DEMOLITION AND NEW WORK. PROTECT RADIO TOWER STRUCTURE ADJACENT TO BUILDING.
- D10** CHIMNEY CAP :
REMOVE EXISTING METAL CAP - CHIMNEY TO BE REMOVED IN ITS ENTIRETY.
- D11** HOT VENT STACK FLASHING :
REMOVE EXISTING FLASHING AT STACK THROUGH ROOF. EXISTING STACK IS TO REMAIN - PROVIDE TEMPORARY SUPPORT DURING ROOFING WORK.
- D12** LIFT STATION VENT:
EXISTING LIFT STATION PIT VENT TO REMAIN. REMOVE FLASHING.
- D13** VENT TO DEMOLISH:
REMOVE EXISTING VENT THROUGH ROOF, PATCH OPENING IN ROOF DECK.
- D14** EXHAUST FAN TO DEMOLISH:
REMOVE EXISTING EXHAUST FAN, ASSOCIATED CURB AND FLASHING. CLOSE OPENING IN ROOF DECK.
- A3** CAULK ABATEMENT:
REMOVE BY ABATEMENT CAULKING AROUND EDGE OF ROOF PRIOR TO ROOF EDGE REMOVAL

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REVISIONS			
DATE	DESCRIPTION	BY	SYM.



TITLE OF PROJECT ADDITIONS TO MAINTENANCE SECTION	CONTRACT NUMBER: TAS 25-9A
LOCATION OF PROJECT MANCHESTER MP 340.15	DATE: 07/30/2025
TITLE OF DRAWING DEMOLITION ROOF PLAN	DRAWING NUMBER: A102


TA NUMBER/DWG/DWG NUMBER
CHECKED BY: XXX
DRAFTED BY: XXX
CHECKED BY: XXX
DESIGNED BY: J.L. MORRIS
BUREAU DIRECTOR: J.L. MORRIS

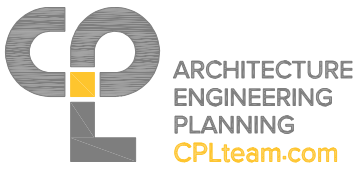NEW CONSTRUCTION KEY NOTES:

- 1 PATCH EXISTING MASONRY WALL SMOOTH AFTER REMOVAL OF ADJACENT / CONNECTING MASONRY WALL - TYPICAL.
- 2 FILL IN EXISTING OPENING WITH METAL STUD AND GYP. BOARD CONSTRUCTION.
- 3 FURNITURE BY OWNER.
- 4 EQUIPMENT BY OWNER.
- 5 PATCH EXISTING CMU WALL INCLUDING ALL PENETRATIONS FROM FORMER PLUMBING AND FASTENERS. SMOOTH PATCHED AREAS AND PAINT WALL FULL HEIGHT - TYP. CORRIDOR 01 AND 01A.
- 6 INSTALL NEW WINDOW IN EXISTING MASONRY OPENING.
- 7 NEW AHU-1 ON CONCRETE PAD. SEE MECHANICAL DRAWINGS.
- 8 FIRE EXTINGUISHER AND CABINET
- 9 STEEL BEAM - SEE DETAIL 2/S201
- 10 FILL IN EXISTING EXTERIOR OPENING WITH CMU TO MATCH EXISTING DEPTH. INSTALL NEW METAL PANELS OVER EXTERIOR OF MASONRY.
- 11 NEW ALUMINUM LADDER FROM GROUND TO ROOF.
- 12 NEW CANOPY OVER EXTERIOR DOOR - REFER TO ROOF PLAN.
- 13 PROVIDE NEW OPERATOR FOR EXISTING OVERHEAD DOOR AND OPENER RAILS. NEW OPENER TO MATCH EXISTING AT EAST BAY: LIFTMASTER T-753-L5 INDUSTRIAL TROLLEY OPENER WITH BREAK, AND T 14' OPENER RAILS.


LEGEND:

- W07 WINDOW TAG - REFER TO A900 FOR WINDOW TYPES.
- S3i PARTITION/ WALL TYPE - REFER TO A401

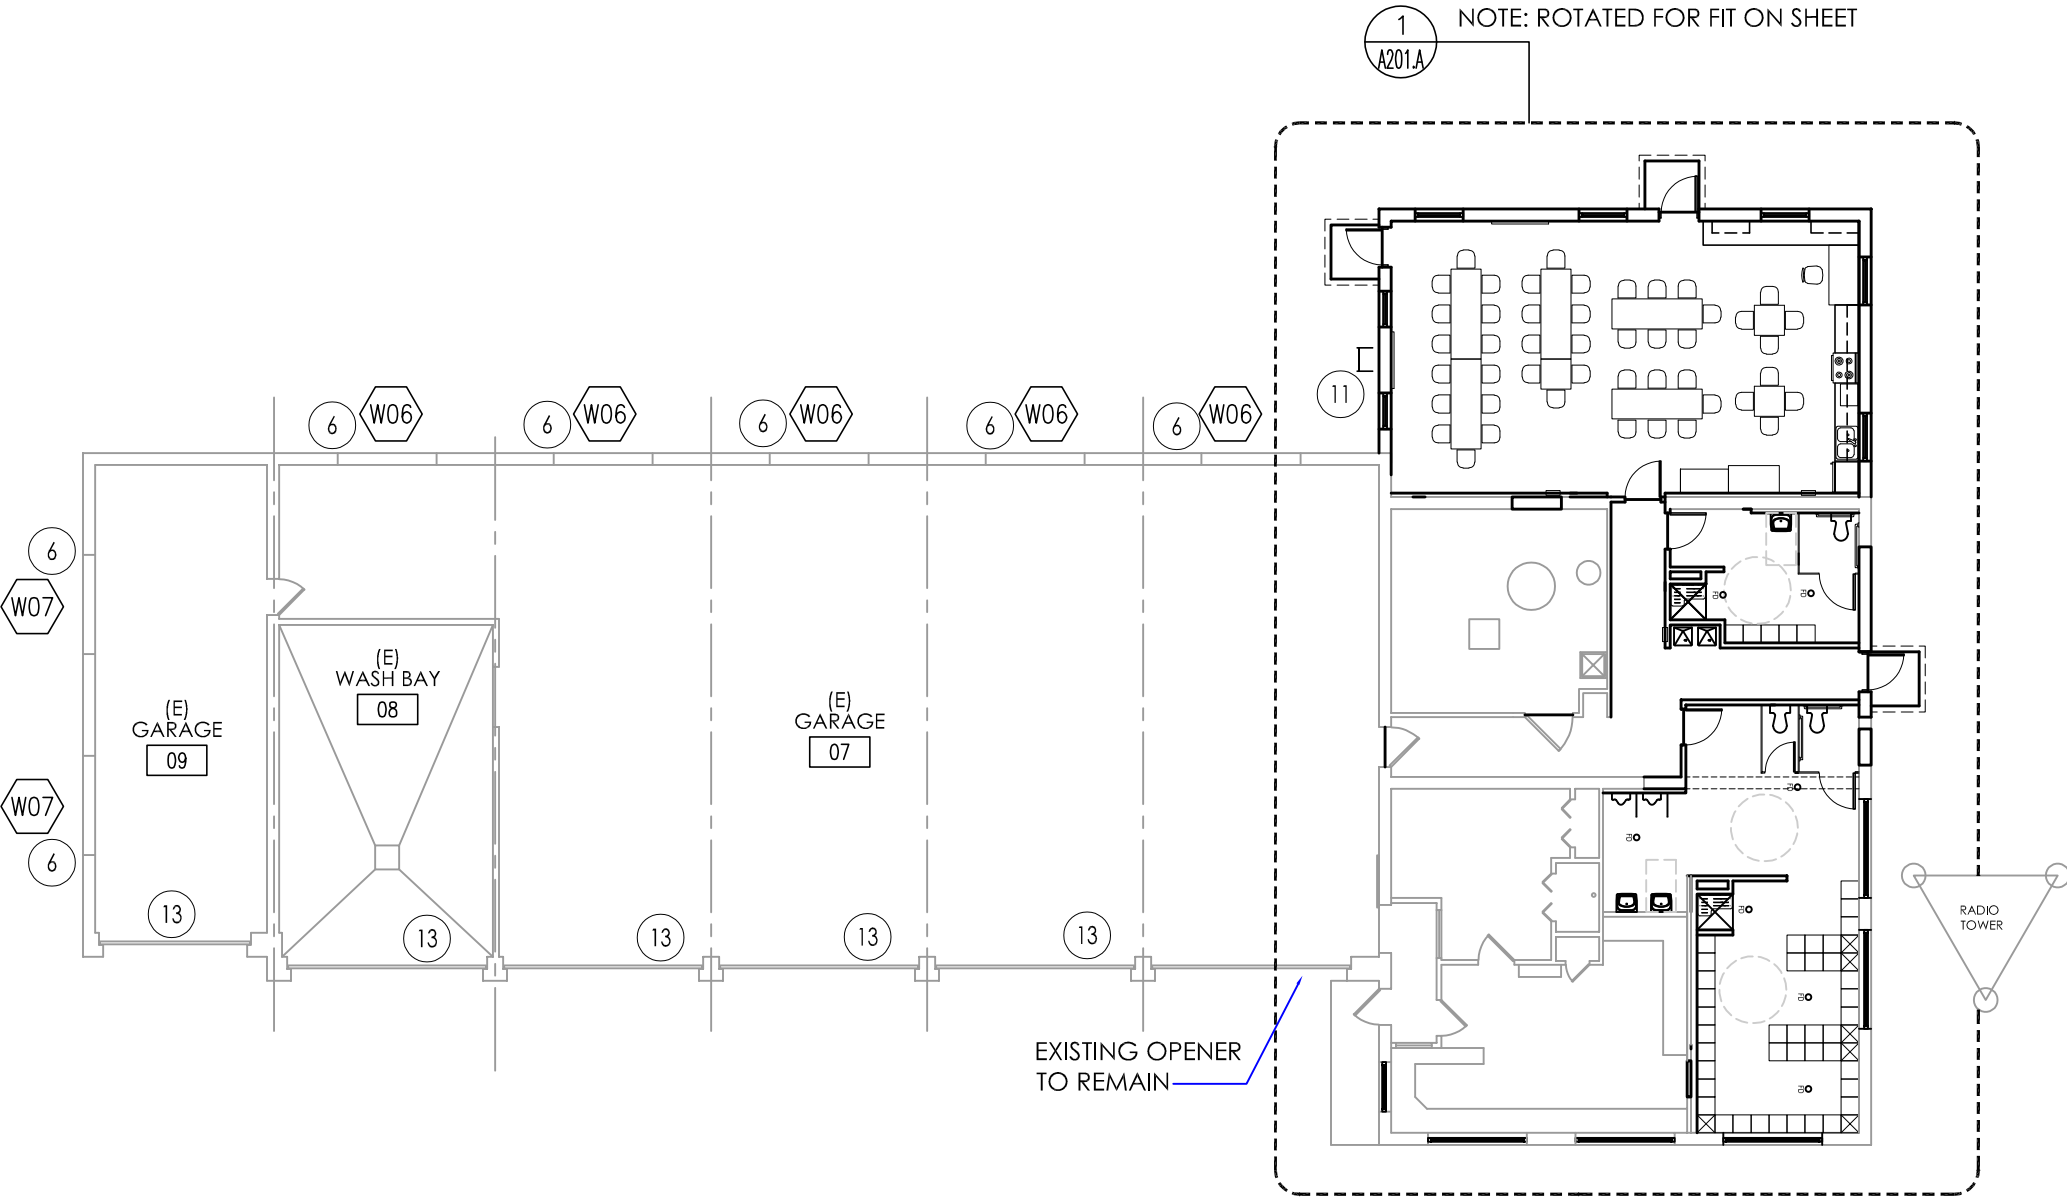

1
A201
↑ REF N
OVERALL FLOOR PLAN
SCALE: 1/16" = 1'-0"

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DATE	DESCRIPTION	BY	SYM.

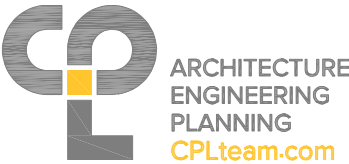

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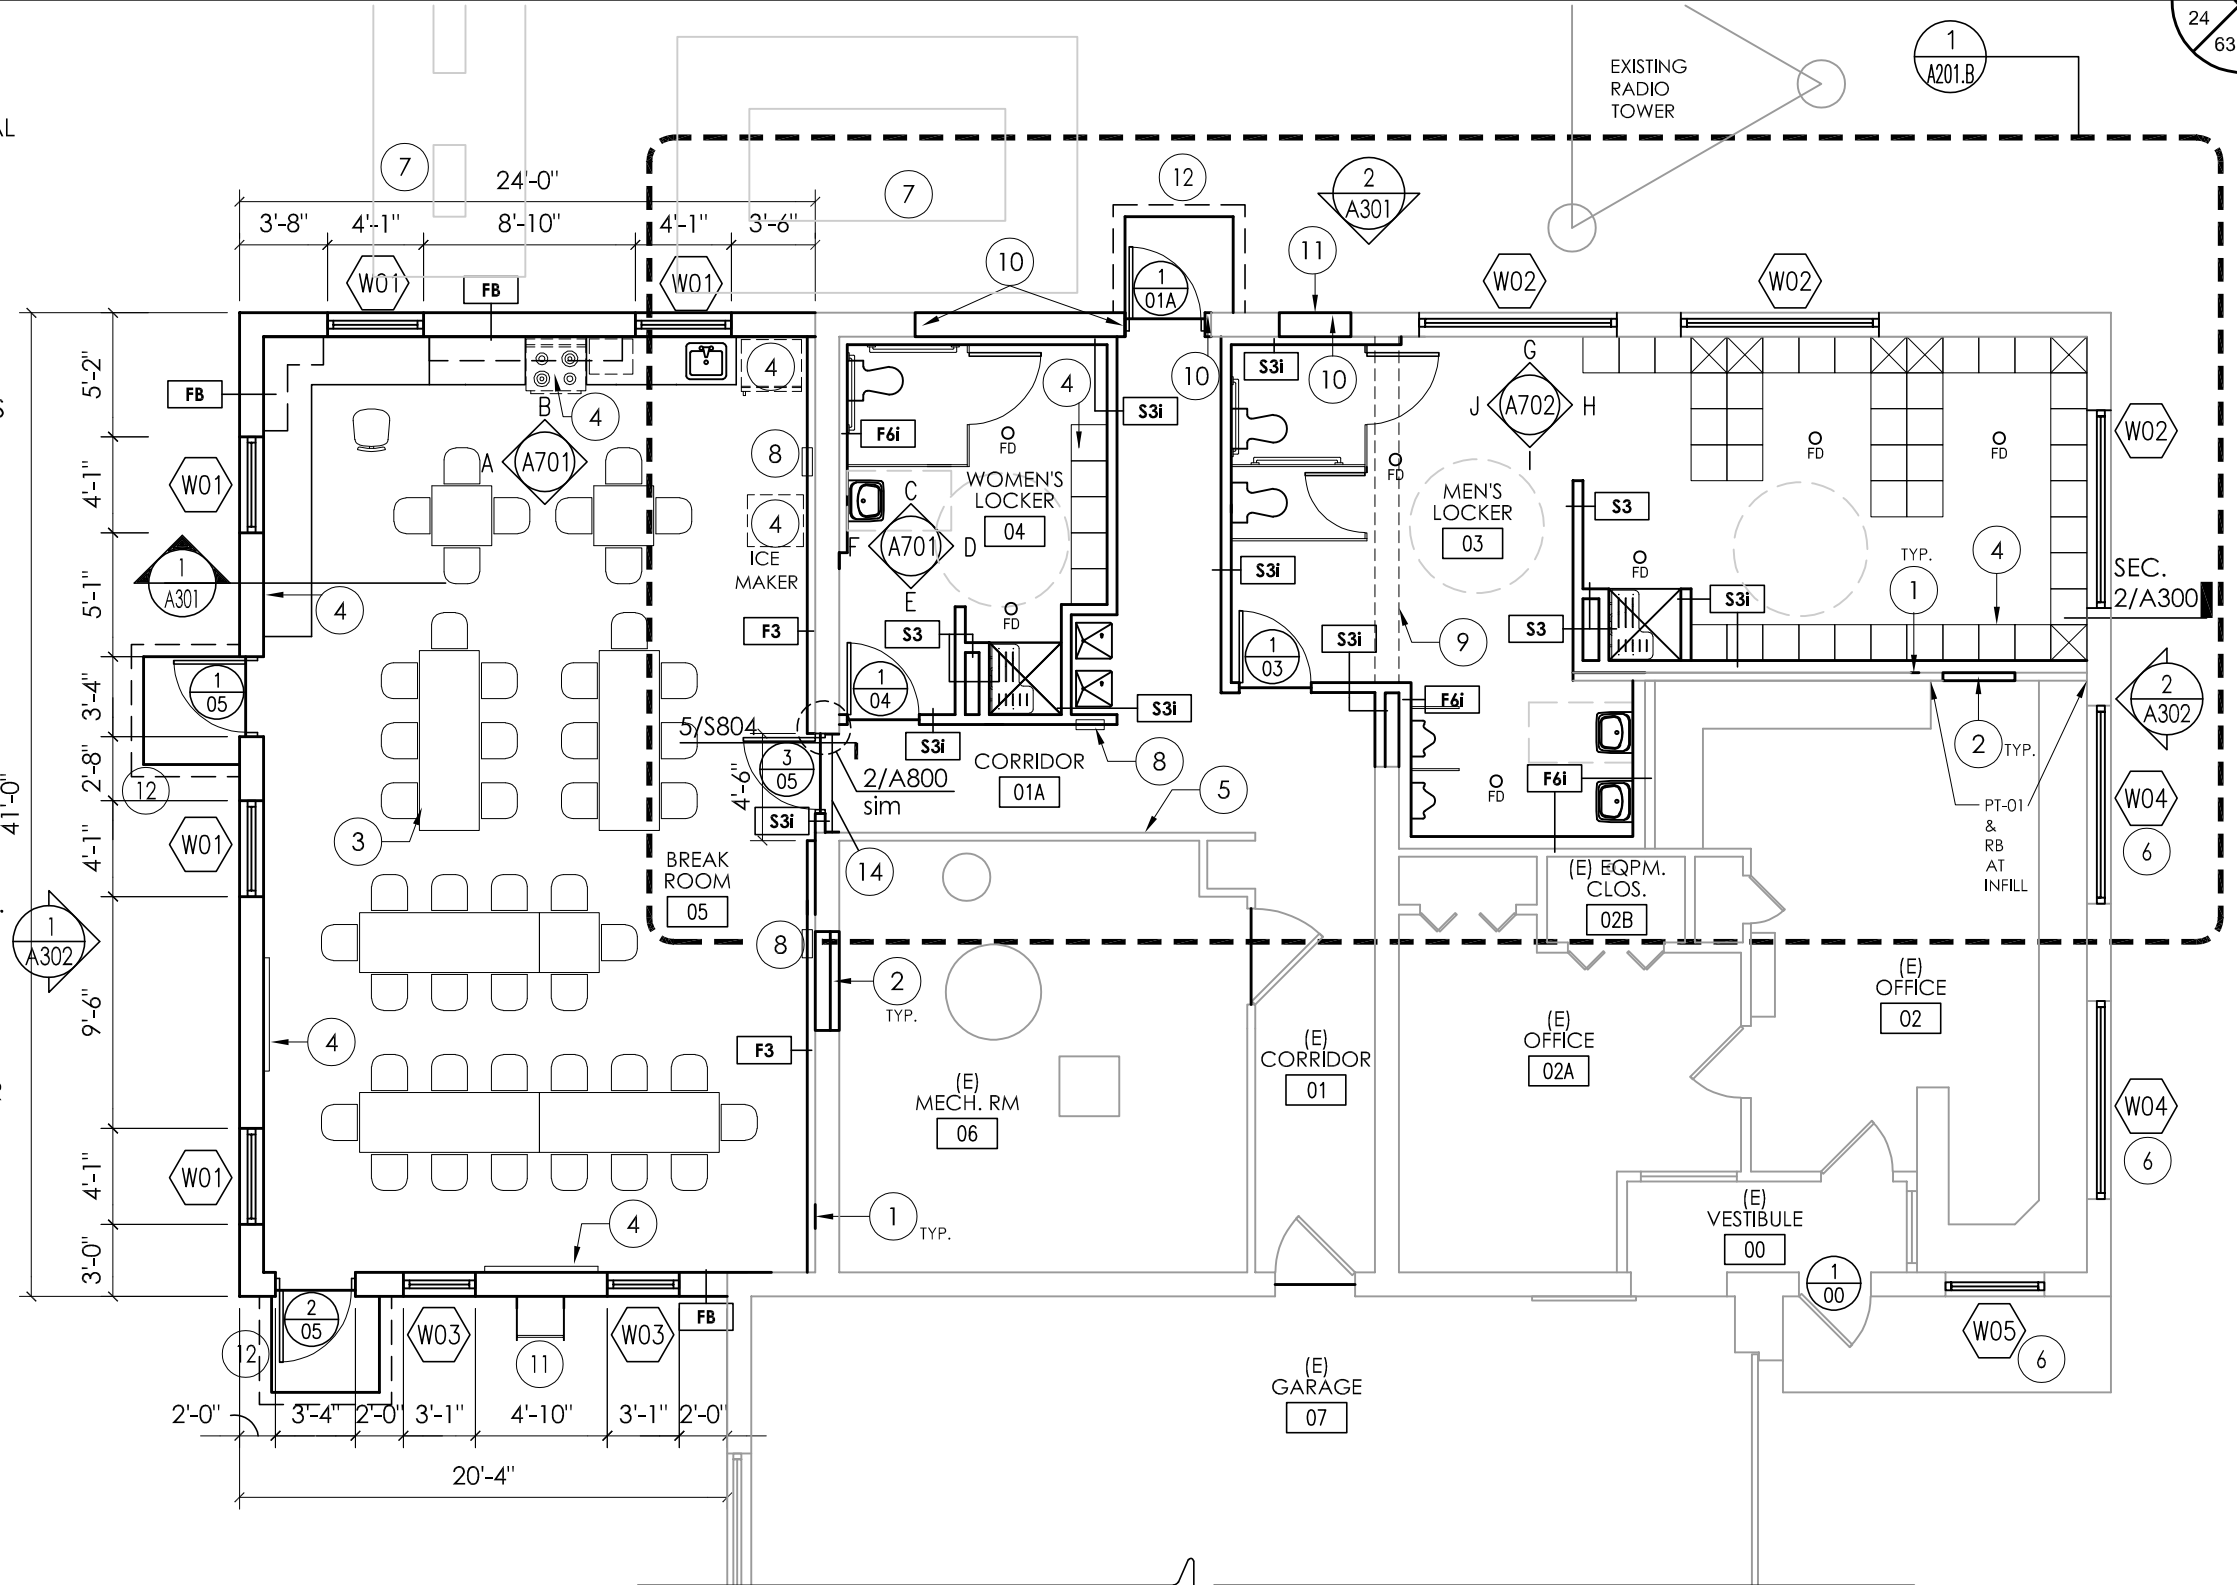
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LOCATION OF PROJECT MANCHESTER MP 340.15	DATE: 07/30/2025
TITLE OF DRAWING OVERALL FLOOR PLAN	DRAWING NUMBER: A201

NEW CONSTRUCTION KEY NOTES:


- 1 PATCH EXISTING MASONRY WALL SMOOTH AFTER REMOVAL OF ADJACENT / CONNECTING MASONRY WALL - TYPICAL.
- 2 FILL IN EXISTING OPENING WITH METAL STUD AND GYP. BOARD CONSTRUCTION.
- 3 FURNITURE BY OWNER.
- 4 EQUIPMENT BY OWNER.
- 5 PATCH EXISTING CMU WALL INCLUDING ALL PENETRATIONS FROM FORMER PLUMBING AND FASTENERS. SMOOTH PATCHED AREAS AND PAINT WALL FULL HEIGHT - TYP. CORRIDOR 01 AND 01A.
- 6 INSTALL NEW WINDOW IN EXISTING MASONRY OPENING.
- 7 NEW HVAC UNITS ON CONCRETE PADS. SEE MECHANICAL DRAWINGS.
- 8 FIRE EXTINGUISHER, CABINET, AND SIGN - REFER TO SPECIFICATION SECTION 104413
- 9 STEEL BEAM - SEE DETAIL 2/S201
- 10 FILL IN EXISTING EXTERIOR OPENING WITH CMU TO MATCH EXISTING DEPTH, 2 1/2" RIGID INSULATION, VAPOR BARRIER, INSTALL NEW METAL PANELS OVER EXTERIOR OF MASONRY.
- 11 NEW ALUMINUM LADDER FROM GROUND TO ROOF.
- 12 NEW CANOPY OVER EXTERIOR DOOR - REFER TO ROOF PLAN.
- 13 PROVIDE NEW OPERATOR FOR EXISTING OVERHEAD DOOR - REFER TO ELECTRICAL DRAWINGS FOR ADDITIONAL REQUIREMENTS.
- 14 ADHERE (1) LAYER OF GYP.BD. AT JAMB OPENING

LEGEND:

- W07 WINDOW TAG - REFER TO A900 FOR WINDOW TYPES.
- S3i PARTITION/ WALL TYPE - REFER TO A401



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1 A201A

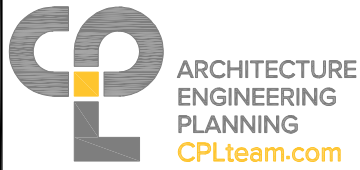← REF

FLOOR PLAN


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REVISIONS			
DATE	DESCRIPTION	BY	SYM.



TITLE OF PROJECT ADDITIONS TO MAINTENANCE SECTION	CONTRACT NUMBER: TAS 25-9A
LOCATION OF PROJECT MANCHESTER MP 340.15	DATE: 07/30/2025
TITLE OF DRAWING ADDITION FLOOR PLAN	DRAWING NUMBER: A201A

EXP. 05/31/2026

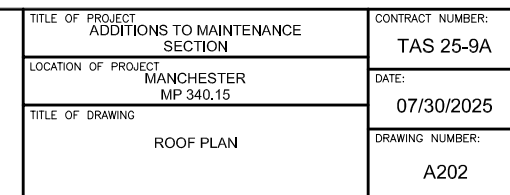


CHECKED BY: XXX

DRAFTED BY: XXX

CHECKED BY: XXX

DESIGNED BY: XXX

BUREAU DIRECTOR: J. L. MORRIS

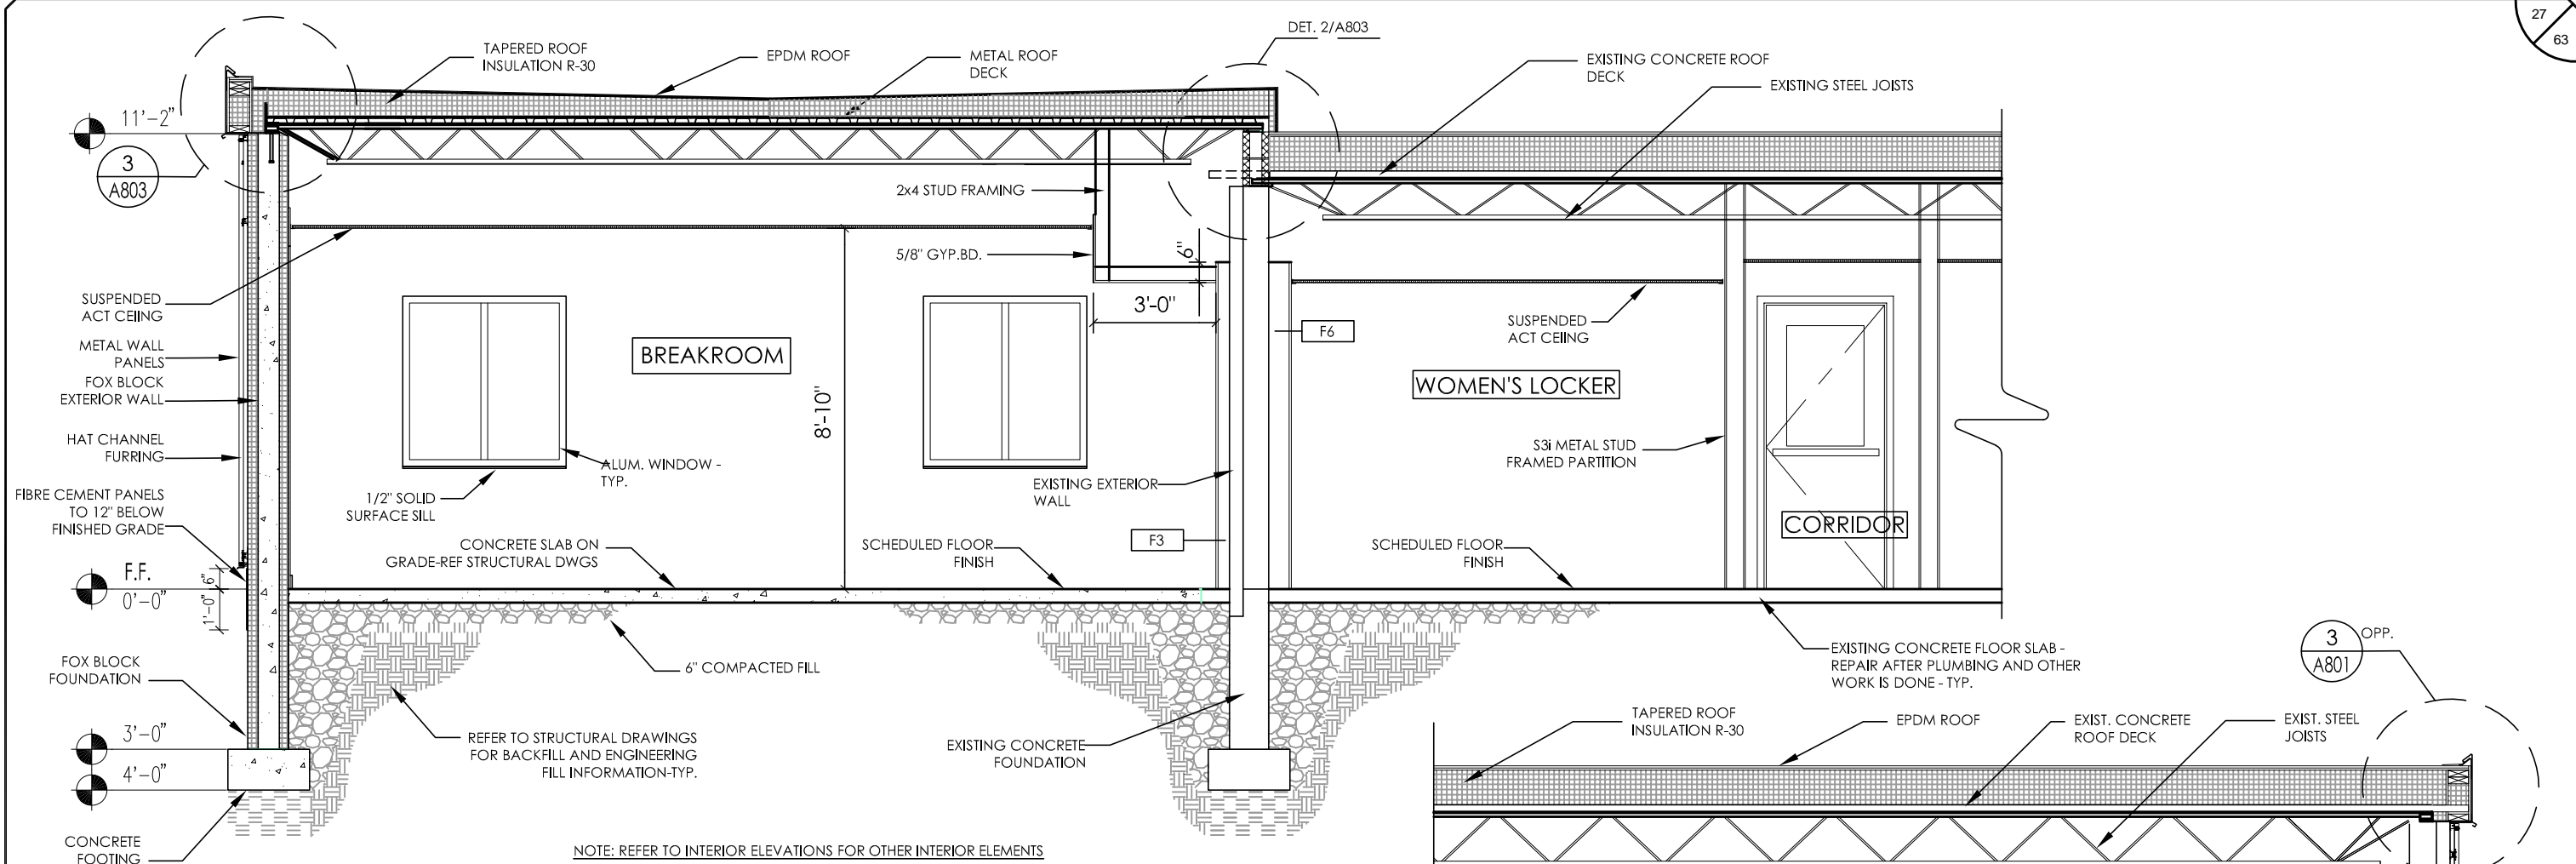


1

A300

BUILDING ADDITION SECTION

SCALE: 1/4" = 1'-0"

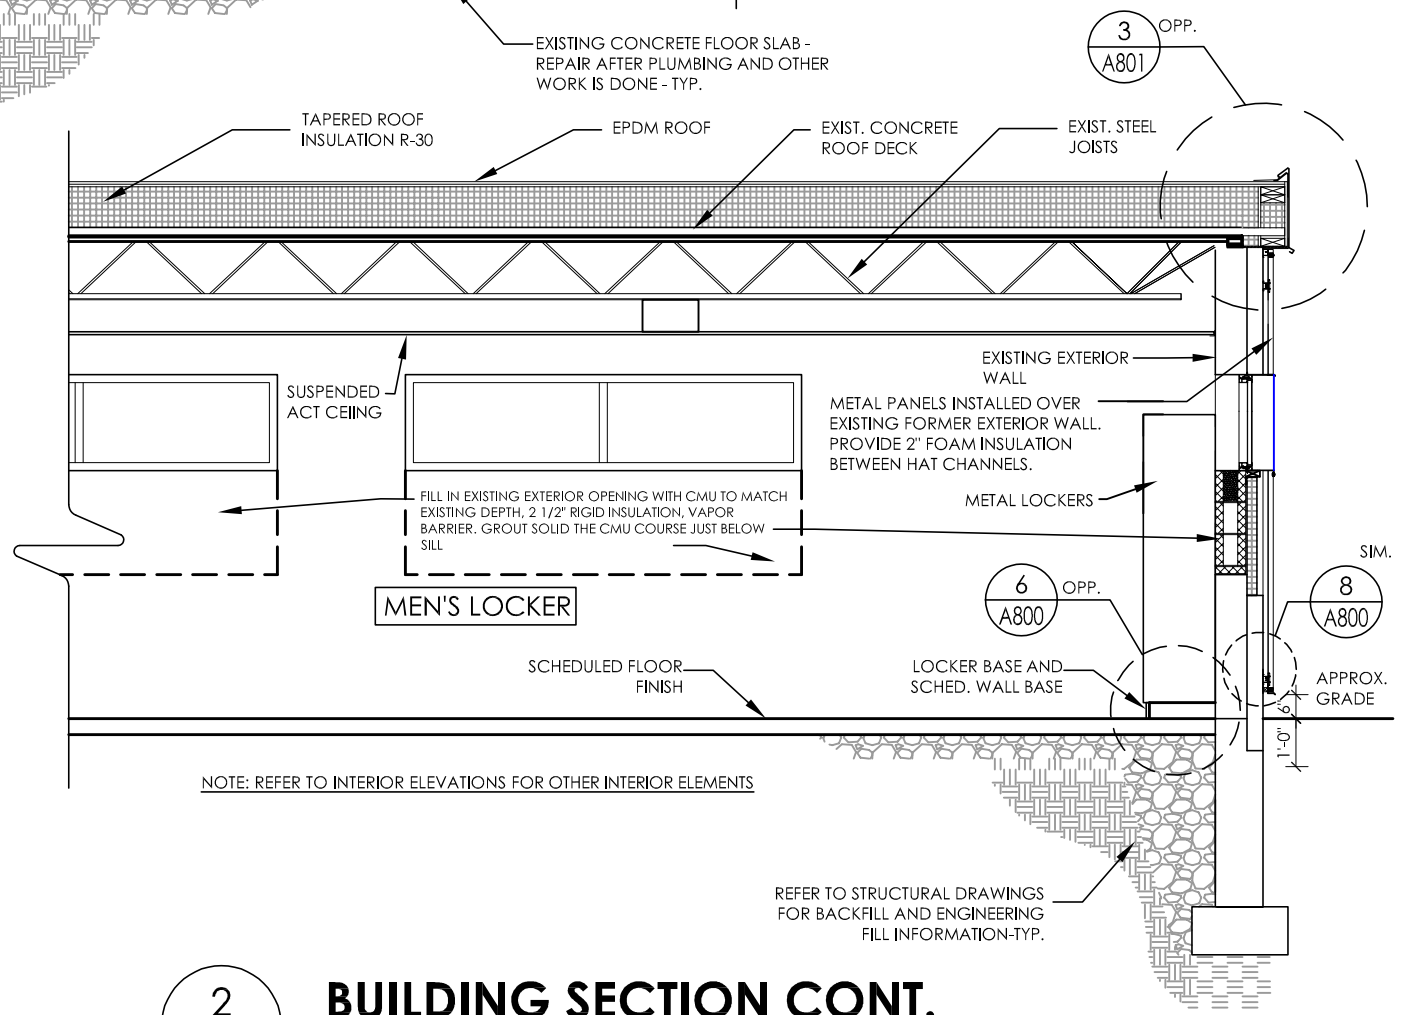

2

A300

BUILDING SECTION CONT.

SCALE: 1/4" = 1'-0"

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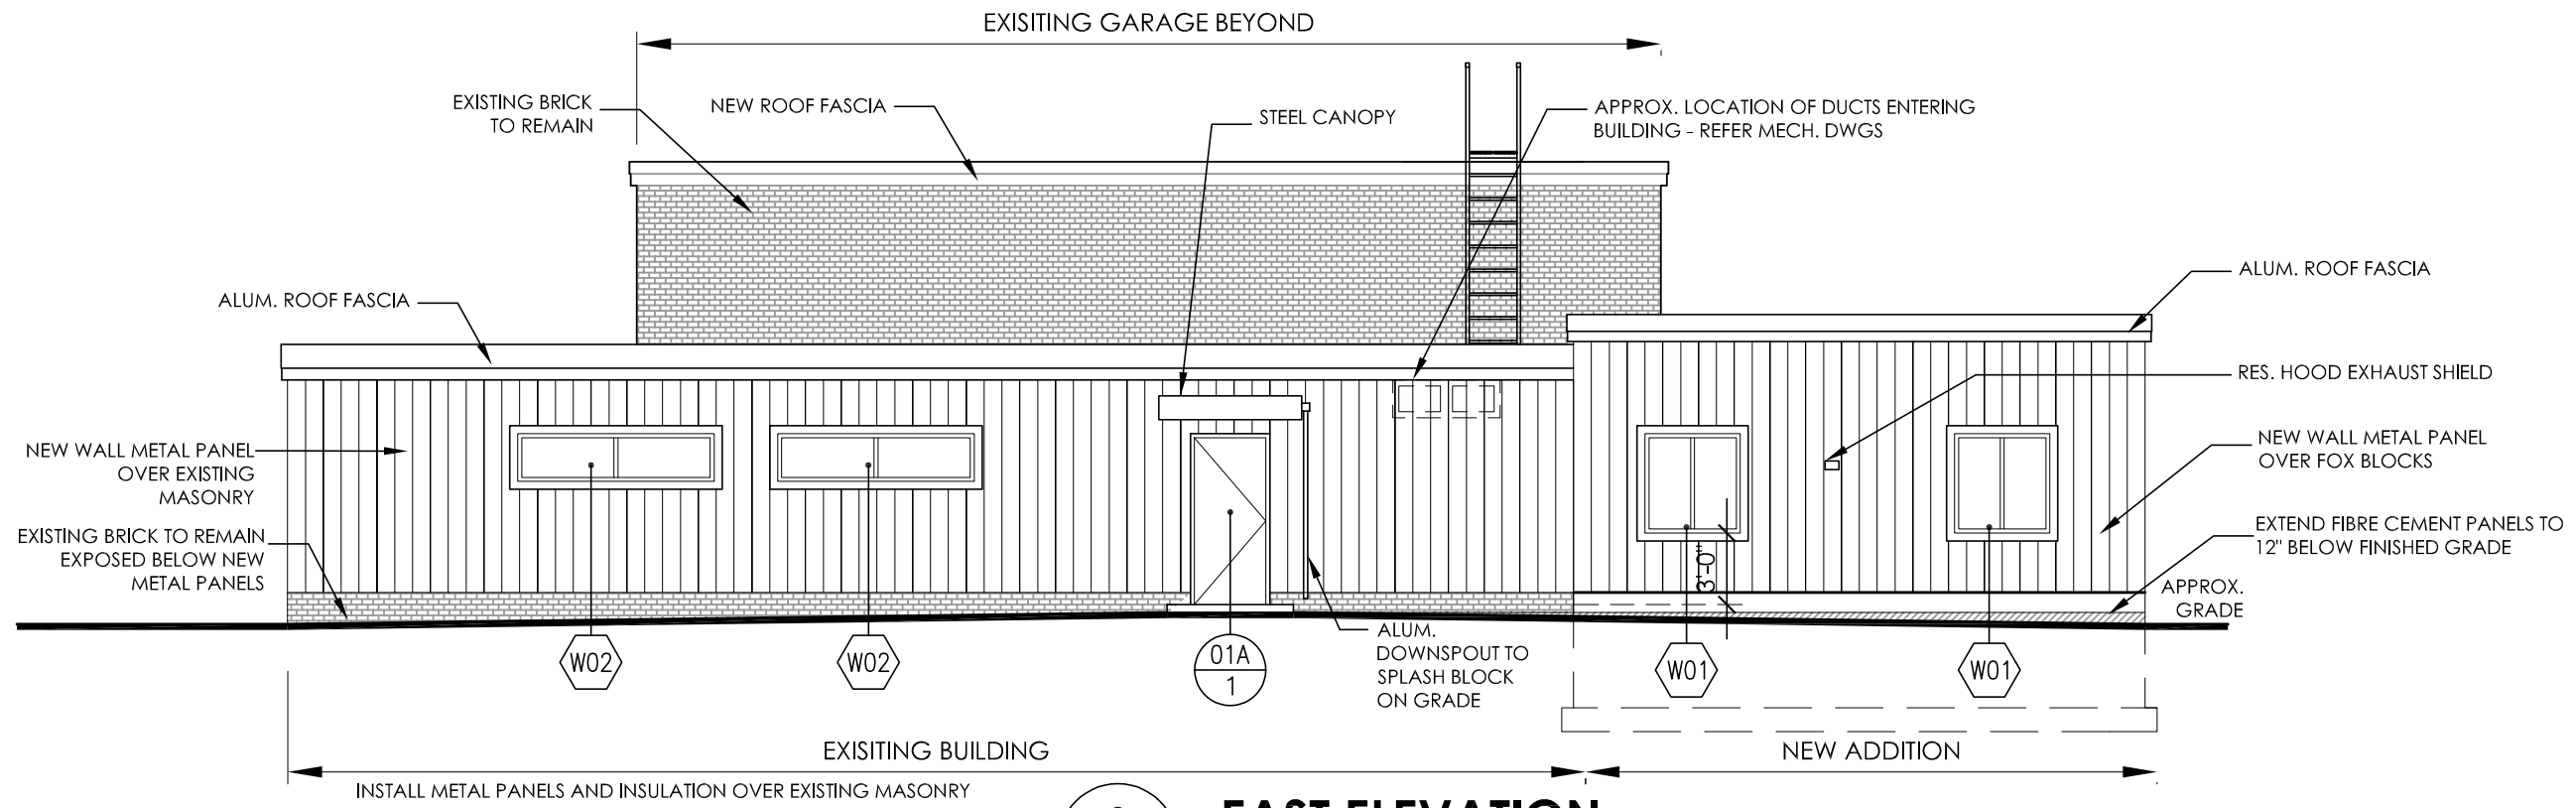
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DATE	DESCRIPTION	BY	SYM.


Thruway Authority

TITLE OF PROJECT ADDITIONS TO MAINTENANCE SECTION	CONTRACT NUMBER: TAS 25-9A
LOCATION OF PROJECT MANCHESTER MP 340.15	DATE: 07/30/2025
TITLE OF DRAWING BUILDING SECTION	DRAWING NUMBER: A300

TA NUMBER/DWG/DWG NUMBER
XXX
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BUREAU DIRECTOR:



2
A301
EAST ELEVATION
SCALE: 1/8" = 1'-0"

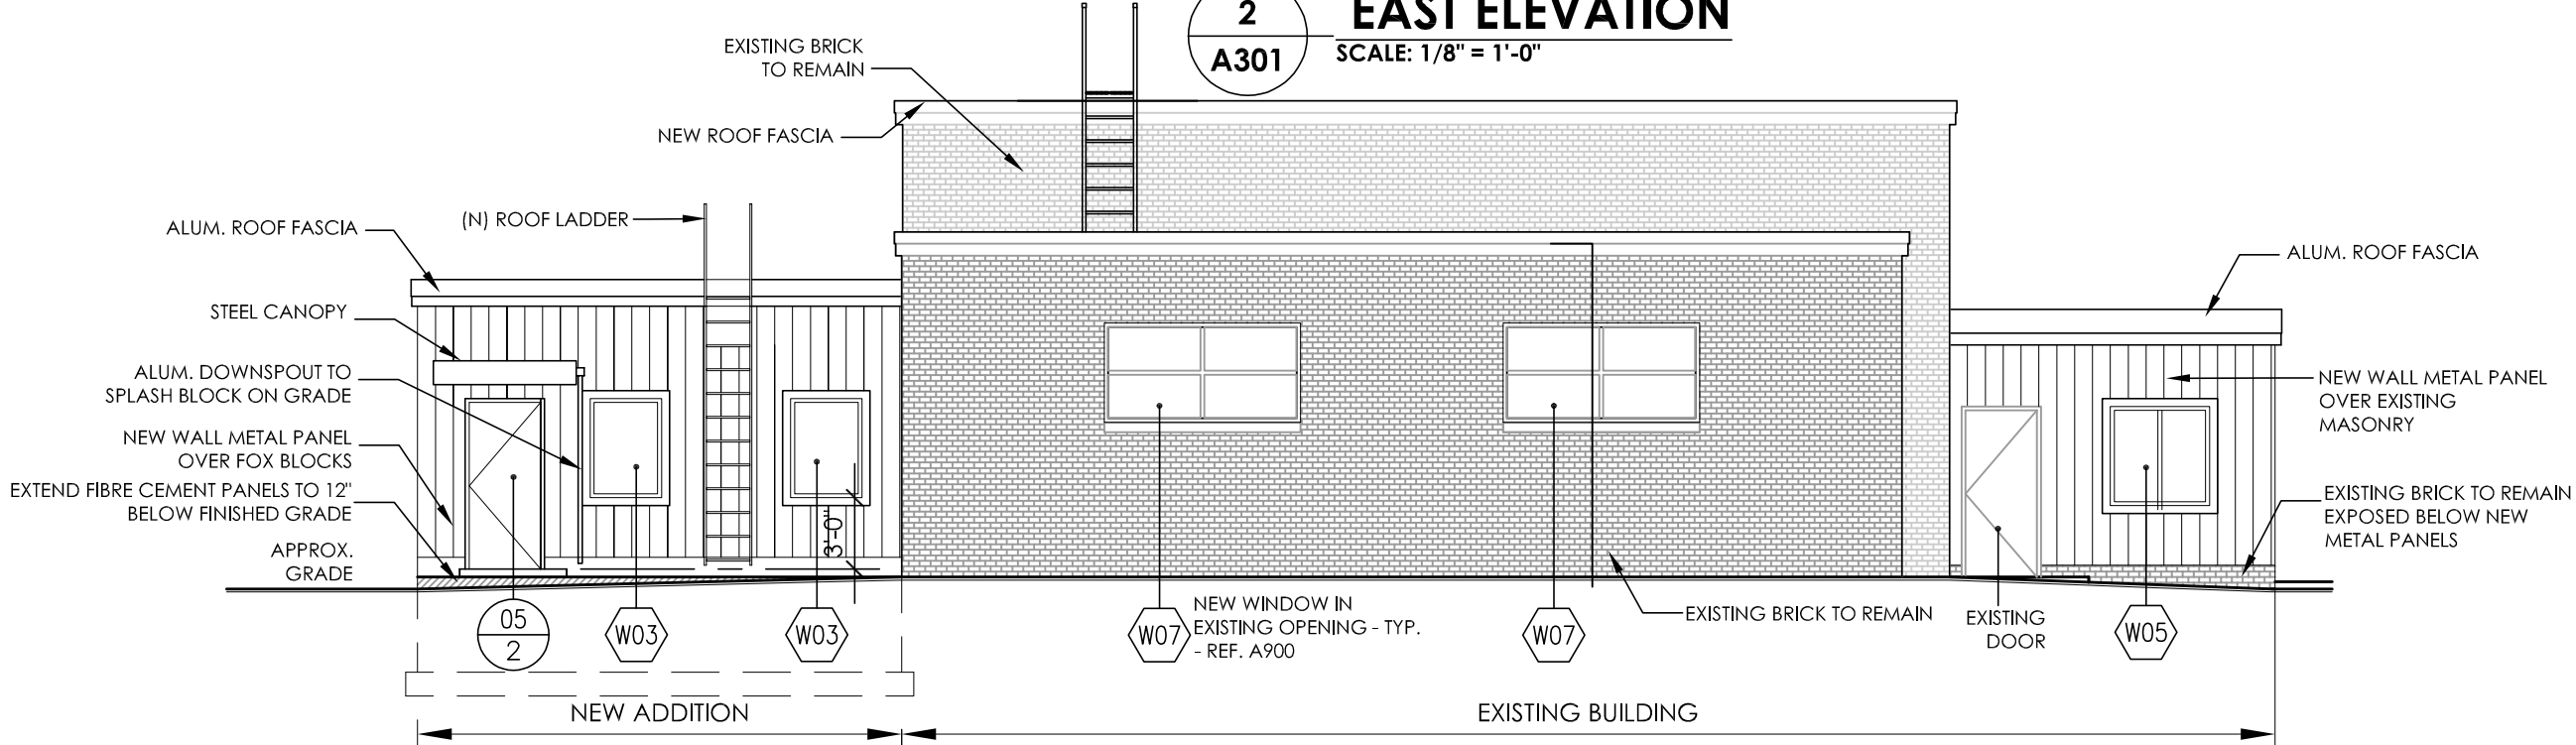


1
A301
WEST ELEVATION
SCALE: 1/8" = 1'-0"

NOTE:
TRIM NEW METAL WALL PANELS
AROUND EXISTING WALL
MOUNTED CONDUITS/PIPING
AND DEVICES. DEVICES THAT
ARE NOT BEING REMOVED OR
RELOCATED ARE TO REMAIN
MOUNTED ON EXISTING BRICK.

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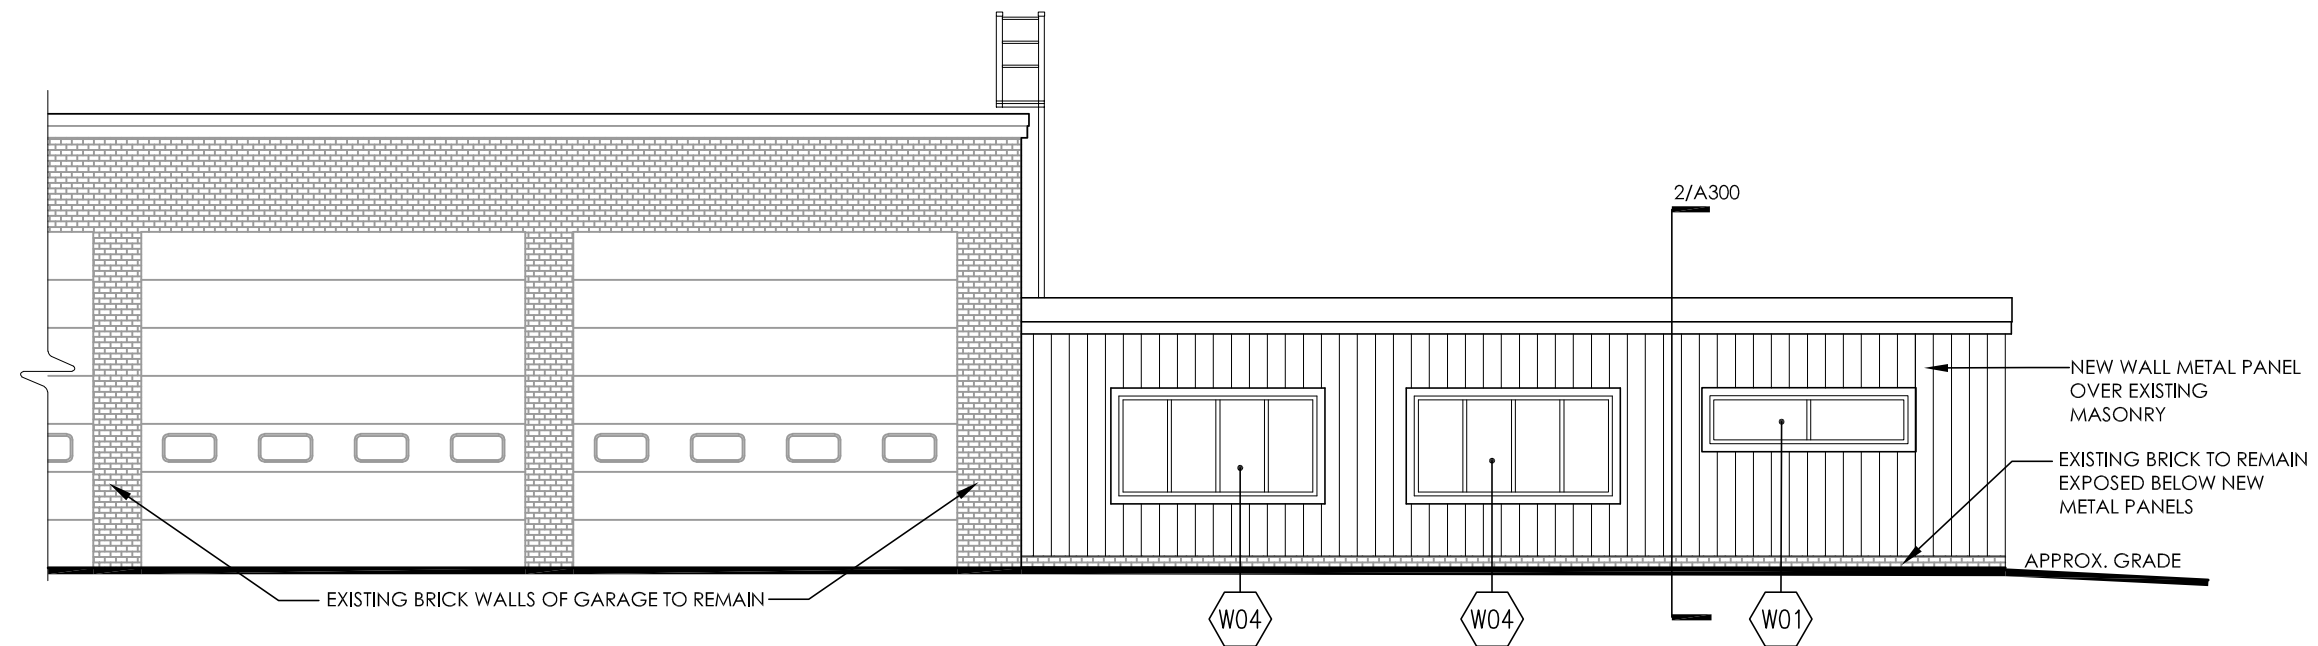
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DATE	DESCRIPTION	BY	SYM.

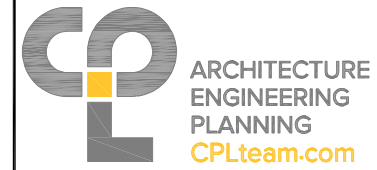


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LOCATION OF PROJECT MANCHESTER MP 340.15	DATE: 07/30/2025
TITLE OF DRAWING BUILDING ELEVATIONS	DRAWING NUMBER: A301

TA NUMBER/DWG/DWG NUMBER
CHECKED BY: XXX
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CHECKED BY: XXX
DESIGNED BY: XXX
BUREAU DIRECTOR: J.L. MORRIS



2
A302
SOUTH ELEVATION
SCALE: 1/8" = 1'-0"

NOTE:
TRIM NEW METAL WALL PANELS AROUND EXISTING WALL MOUNTED CONDUITS/PIPING AND DEVICES. DEVICES THAT ARE NOT BEING REMOVED OR RELOCATED ARE TO REMAIN MOUNTED ON EXISTING BRICK.

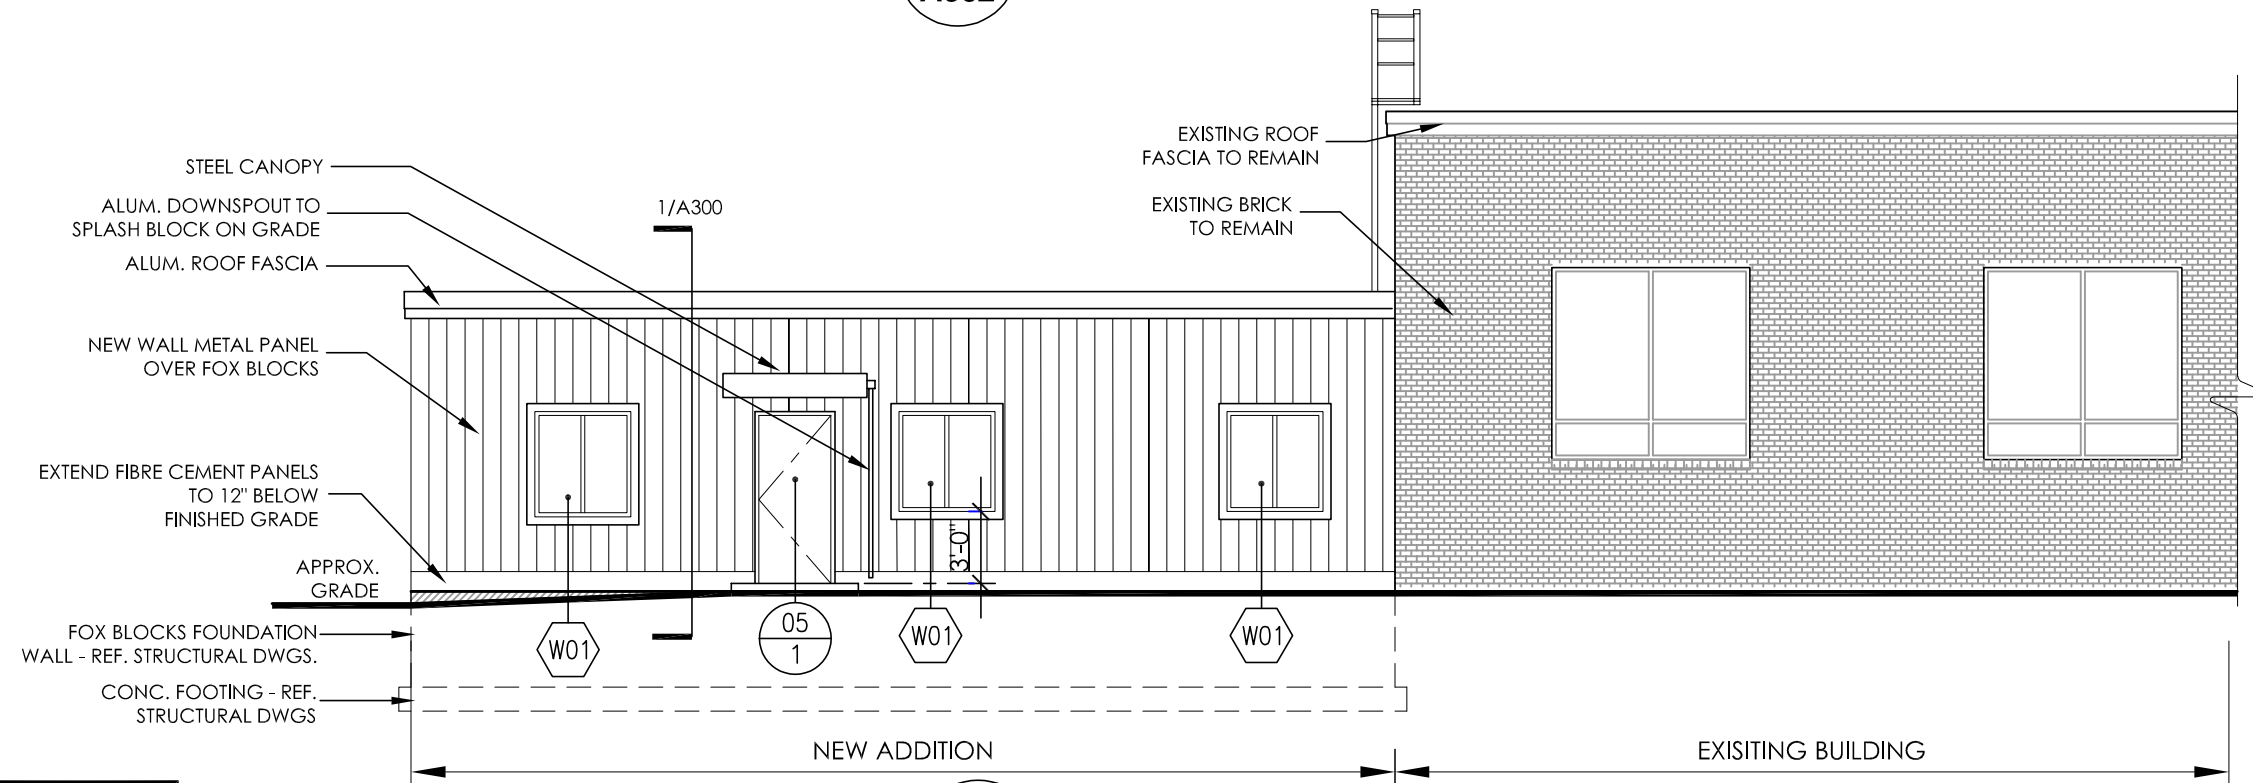

1
A302
NORTH ELEVATION
SCALE: 1/8" = 1'-0"

ALTERED ON:

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REVISIONS			
DATE	DESCRIPTION	BY	SYM.

TITLE OF PROJECT
ADDITIONS TO MAINTENANCE
SECTION

LOCATION OF PROJECT
MANCHESTER
MP 340.15

TITLE OF DRAWING
BUILDING ELEVATIONS


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TAS 25-9A

DATE:
07/30/2025

DRAWING NUMBER:
A302

TA NUMBER/DWG/DWG NUMBER
XXX
CHECKED BY:
XXX
DRAFTED BY:
XXX
CHECKED BY:
XXX
DESIGNED BY:
J.L. MORRIS
BUREAU DIRECTOR:

30
63

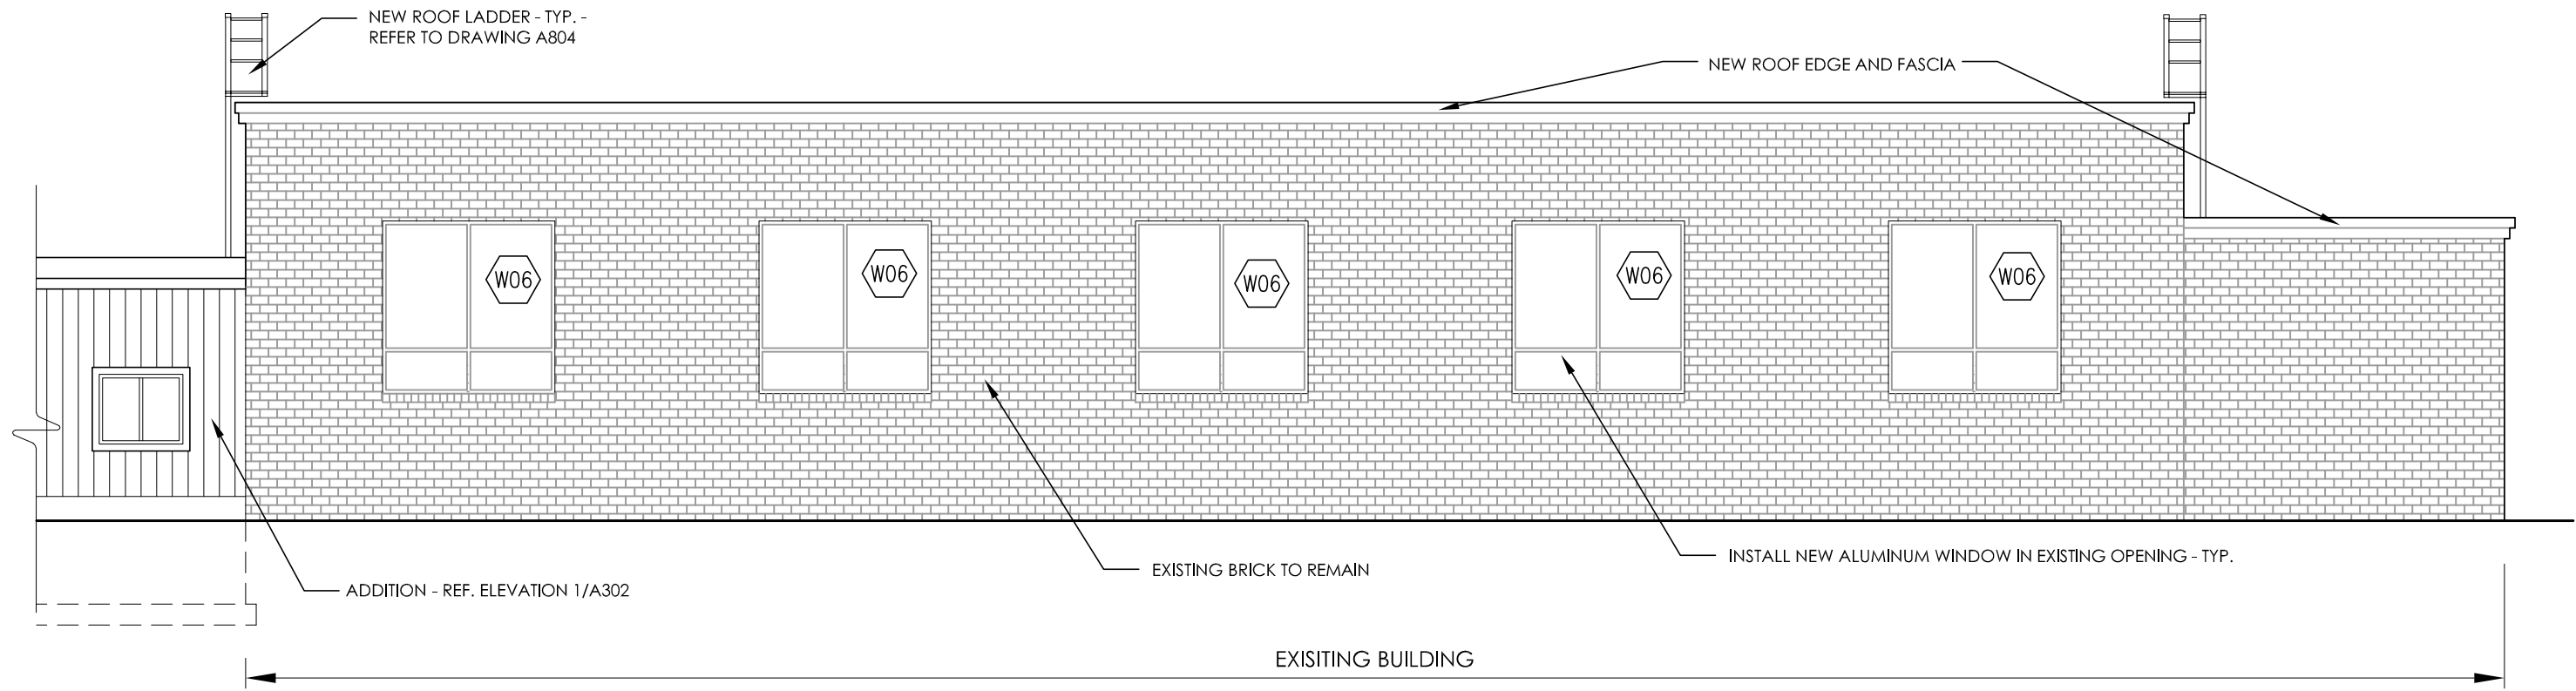


1
A303

NORTH ELEVATION - EXISTING GARAGE

SCALE: 1/8" = 1'-0"

ALTERED ON:	AFFIXED ON: 07/30/2025
SIGNATURE: STAMP:	SIGNATURE: STAMP:

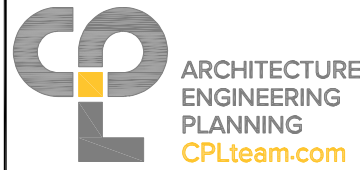


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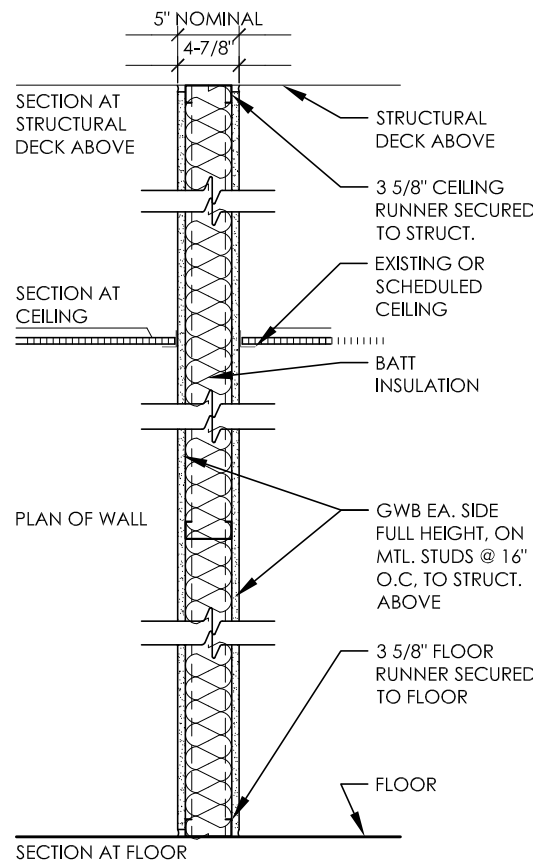
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DATE	DESCRIPTION	BY	SYM.




TITLE OF PROJECT ADDITIONS TO MAINTENANCE SECTION	CONTRACT NUMBER: TAS 25-9A
LOCATION OF PROJECT MANCHESTER MP 340.15	DATE: 07/30/2025
TITLE OF DRAWING BUILDING ELEVATION	DRAWING NUMBER: A303

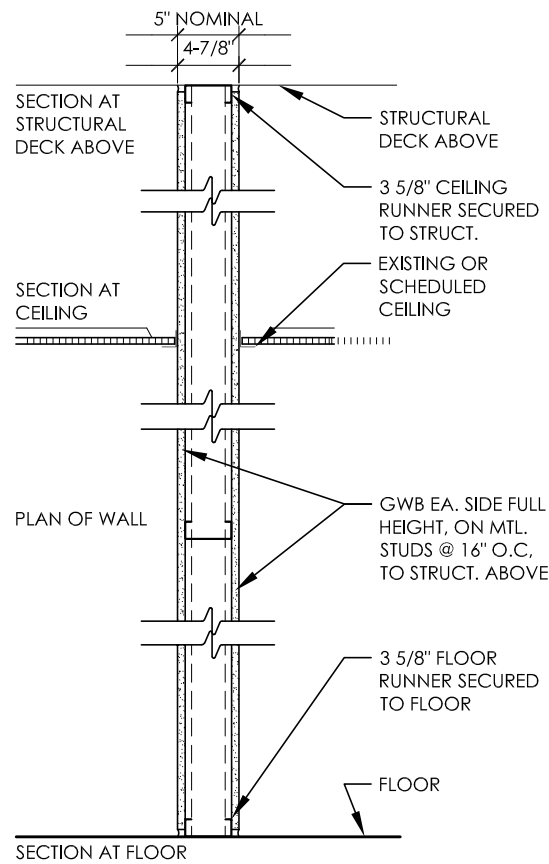


TYPE	FIRE TEST LAB & DESIGN	FIRE RATING	STC
S3	NA	NR	42



TYPE	FIRE TEST LAB & DESIGN	FIRE RATING	STC
S3i	NA	NR	47

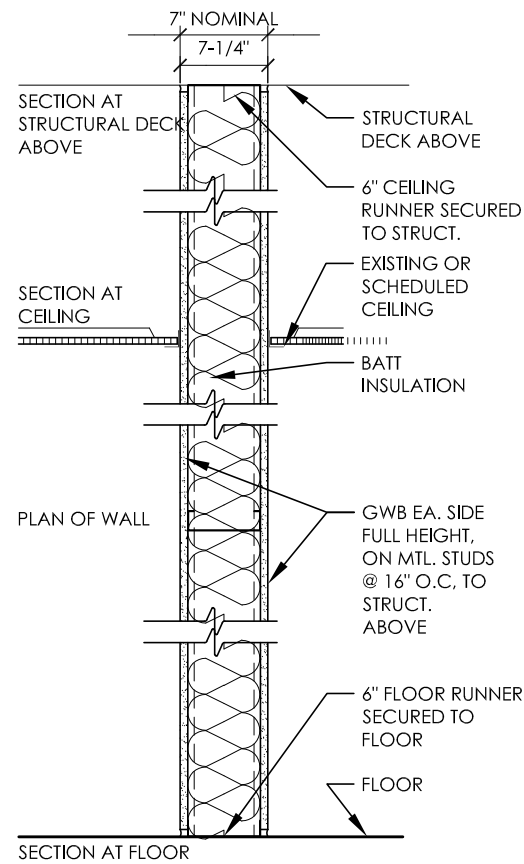


TYPE	FIRE TEST LAB & DESIGN	FIRE RATING	STC
S6i	NA	NR	47

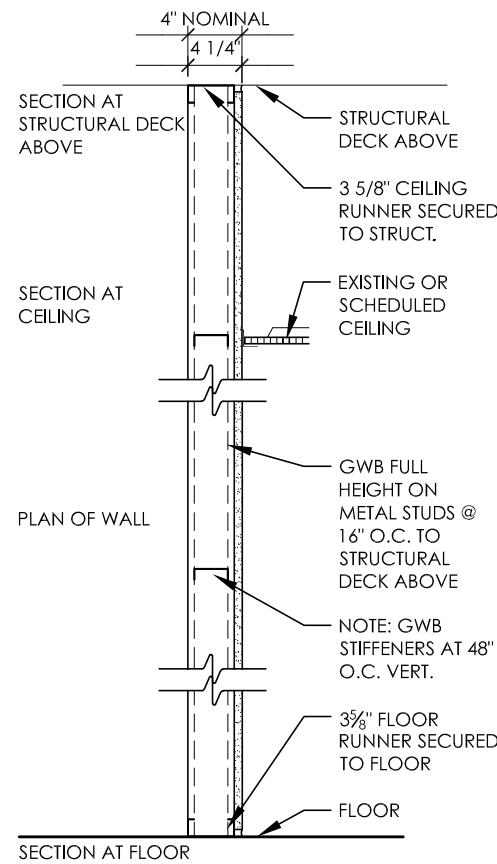

TYPE	FIRE TEST LAB & DESIGN	FIRE RATING	STC
F3	NA	NR	NA
F6i	NA	NR	47

NOTE: FURRED PARTITION F6i: SAME AS F3, WITH 6" STUDS AND ACOUSTIC BATT INSULATION BETWEEN STUDS.

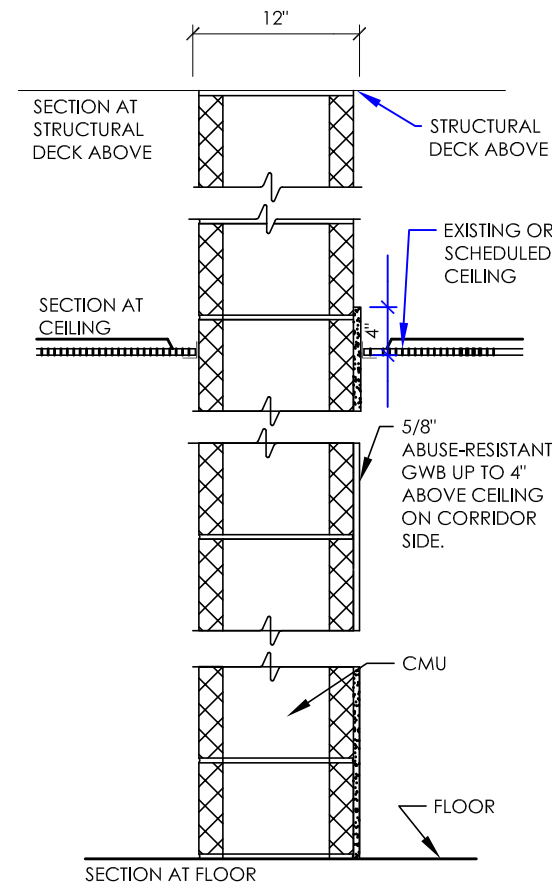


TYPE	FIRE TEST LAB & DESIGN	FIRE RATING	STC
M12	NA	-	-

1 WALL TYPES

A401 SCALE: 3/4" = 1'-0"

ALTERED ON:	AFFIXED ON: 07/30/2025
SIGNATURE: STAMP:	SIGNATURE: STAMP:

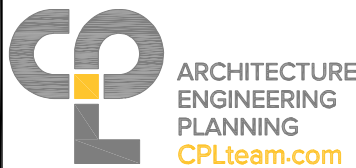

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REVISIONS			
DATE	DESCRIPTION	BY	SYM.



TITLE OF PROJECT: ADDITIONS TO MAINTENANCE SECTION	CONTRACT NUMBER: TAS 25-9A
LOCATION OF PROJECT: MANCHESTER MP 340.15	DATE: 07/30/2025
TITLE OF DRAWING: WALL TYPES	DRAWING NUMBER: A401



A logic diagram of a 2-to-1 multiplexer. It has two data inputs on the left, each represented by a square with a diagonal line from the top-left to the bottom-right. The top input is labeled '0' and the bottom input is labeled '1'. A single select input, represented by a square with a diagonal line from the top-right to the bottom-left, is located at the bottom. The outputs of the two data inputs and the select input are connected to a single output line on the right.

MECHANICAL DIFFUSERS & GRILLES,
REFER TO MECHANICAL SERIES DWGS.
FOR INTENDED DESIGNATIONS AND
DESCRIPTIONS.




EMERGENCY LIGHT FIXTURE,
RE: ELEC. DWGS.

1. ALL DRAWINGS ARE GRAPHIC REPRESENTATION OF APPROXIMATE LOCATIONS OF NEW MATERIALS FOR CONSTRUCTION. IT IS THE CONTRACTORS RESPONSIBILITY TO FIELD VERIFY ALL CONDITIONS PRIOR TO COMMENCEMENT OF WORK.
2. THE CONTRACTOR IS RESPONSIBLE FOR DAMAGE TO ANY EXISTING FINISHES AND EQUIPMENT NOT REMOVED UNDER THE SCOPE OF WORK. ANY DAMAGE WILL BE REPAIRED TO THE OWNER/ARCHITECT'S SATISFACTION.
3. REFER TO THE MECHANICAL, ELECTRICAL, AND PLUMBING DRAWINGS FOR ADDITIONAL FIXTURES, UTILITY AND SERVICE INFORMATION.
4. IT IS THE RESPONSIBILITY OF THE MECHANICAL, ELECTRICAL, AND PLUMBING CONTRACTORS TO FIRE STOP THEIR WORK, INCLUDING BUT NOT LIMITED TO DUCTWORK, PIPE AND CONDUIT PENETRATIONS, RESPECTIVELY, THROUGH FLOORS AND WALLS.
5. WORK AREAS SHALL BE MAINTAINED AND ALL WORK AREAS SHALL BE LEFT BROOMED CLEAN AT END OF EACH DAY.
6. THE GENERAL CONTRACTOR SHALL COORDINATE CEILING INSTALLATIONS WITH MECHANICAL, ELECTRICAL, AND PLUMBING CONTRACTORS.
7. REFER TO ELECTRICAL DRAWINGS FOR FIXTURE AND DEVICE LOCATIONS.
8. REFER TO MECHANICAL DRAWINGS FOR DIFFUSER LOCATIONS.

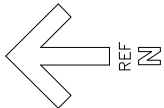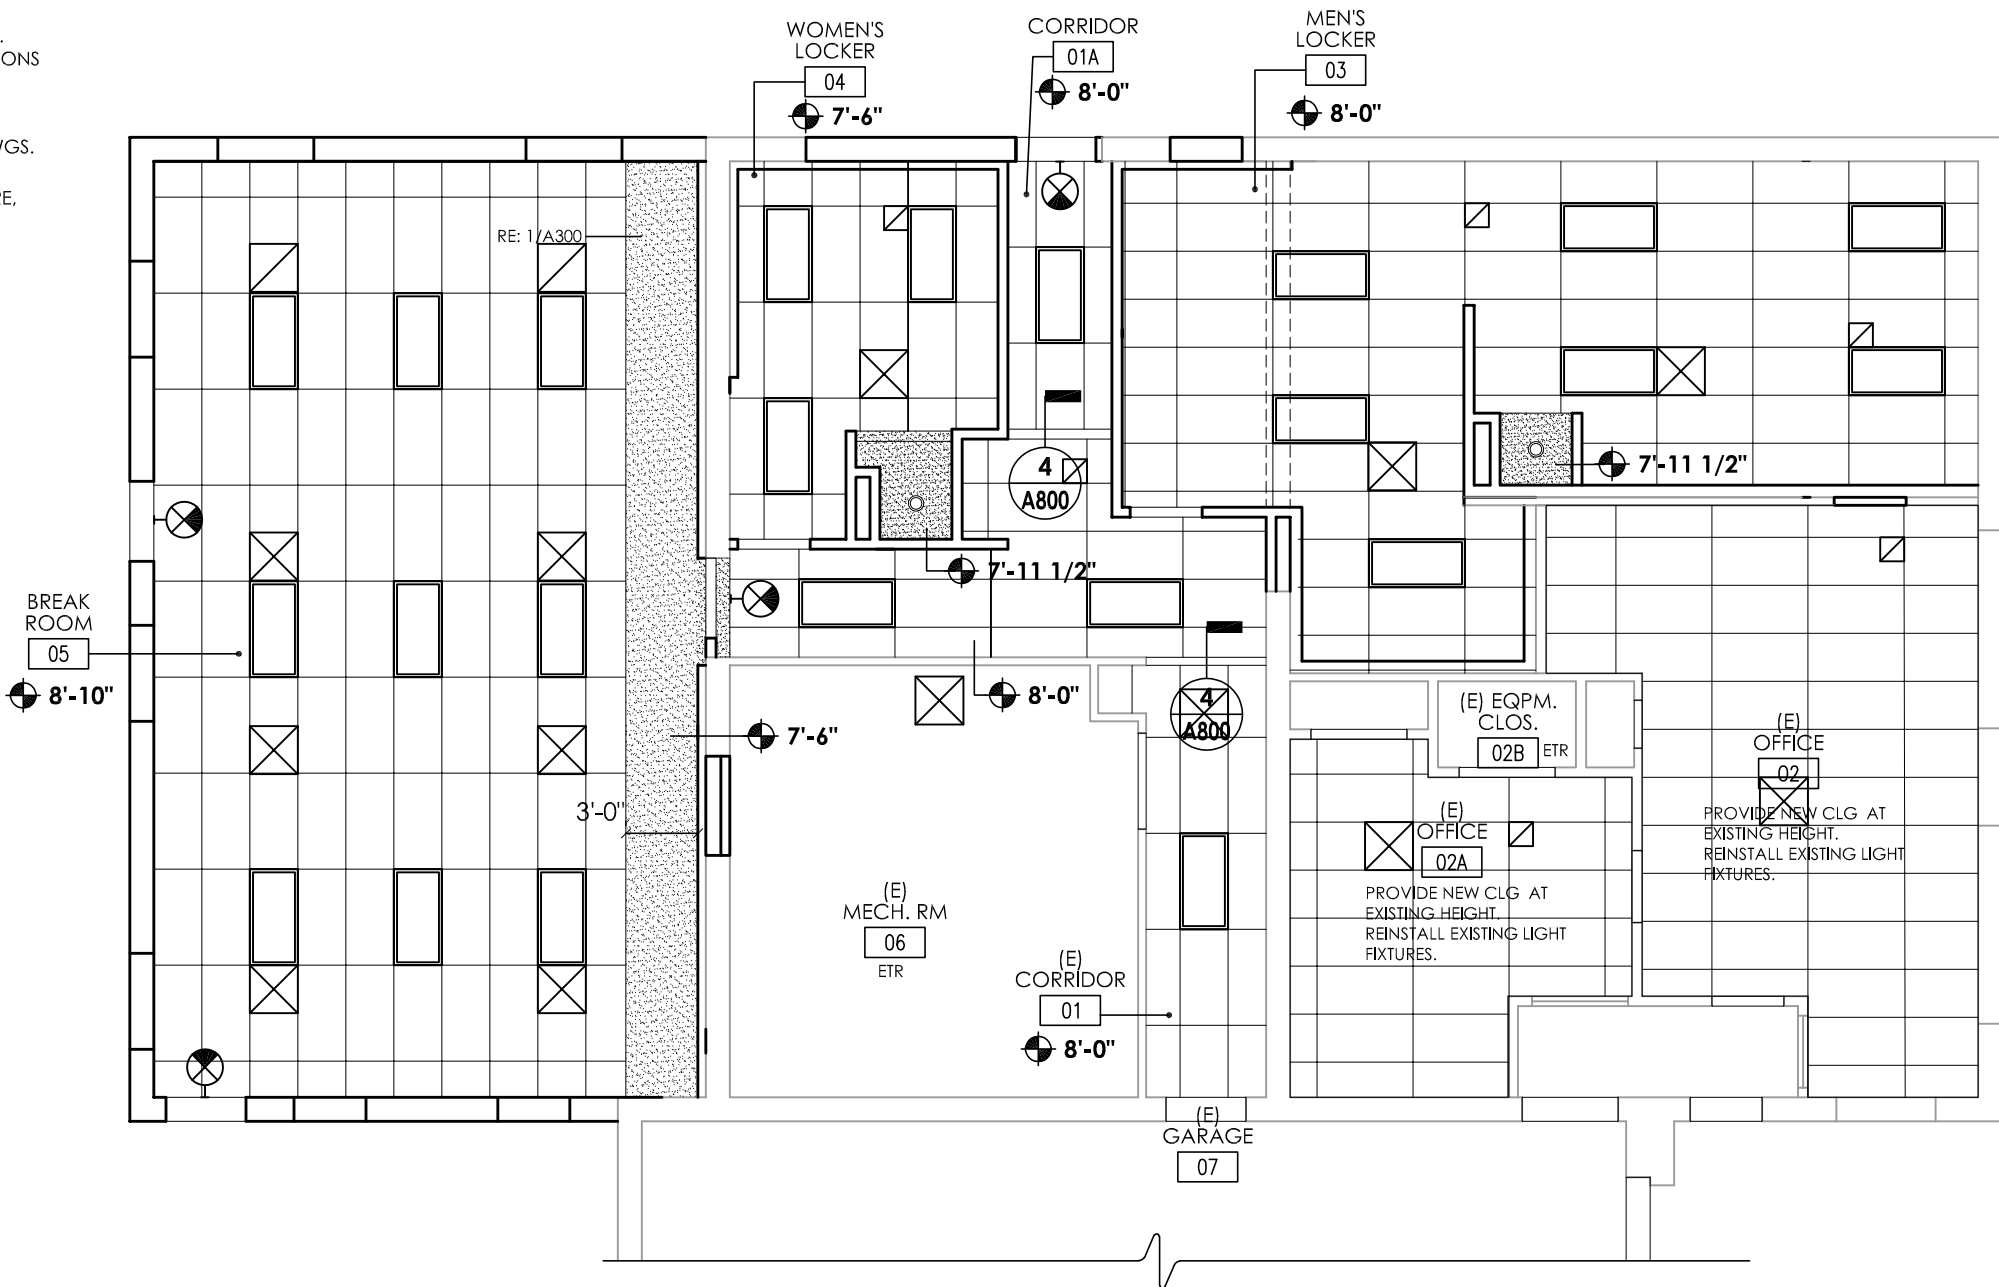

1
A601

SCALE: 1/8" = 1'-0"

ALTERED ON:	AFFIXED ON: 07/30/2025
SIGNATURE: STAMP:	SIGNATURE: STAMP:  EXP. 05/31/2026



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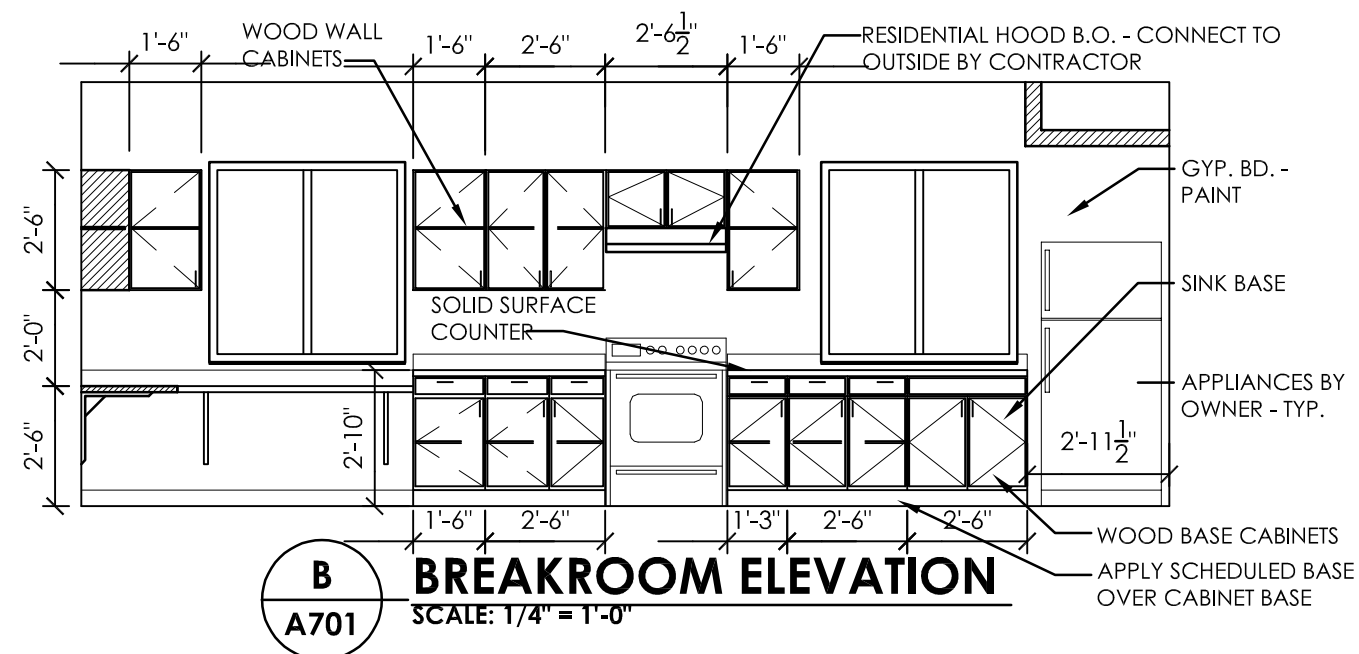
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REVISIONS			
DATE	DESCRIPTION	BY	SYM.







Thruway Authority

TITLE OF PROJECT ADDITIONS TO MAINTENANCE SECTION	CONTRACT NUMBER: TAS 25-9A
LOCATION OF PROJECT MANCHESTER MP 340.15	DATE: 07/30/2025
TITLE OF DRAWING REFLECTED CEILING PLAN	DRAWING NUMBER: A601



TA NUMBER/DWG NUMBER
XXX
CHECKED BY:
XXX
DRAFTED BY:
XXX
CHECKED BY:
XXX
DESIGNED BY:
XXX
BUREAU DIRECTOR:
J.L. MORRIS

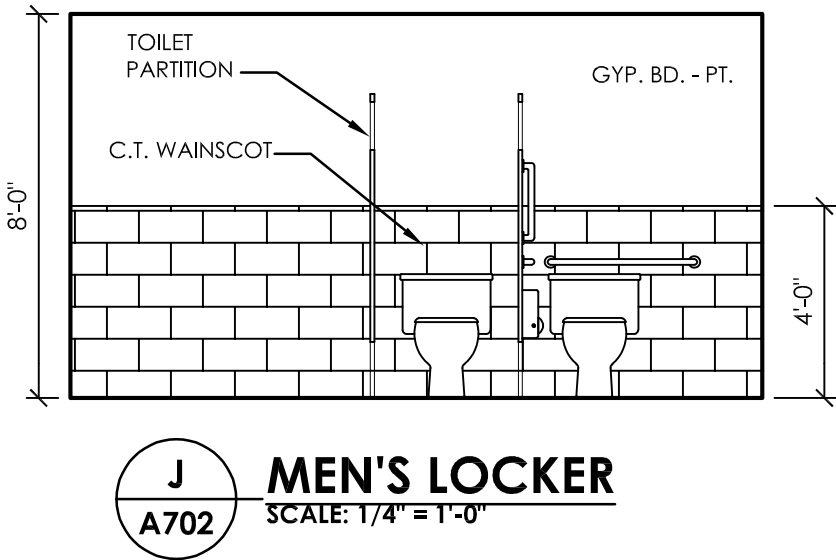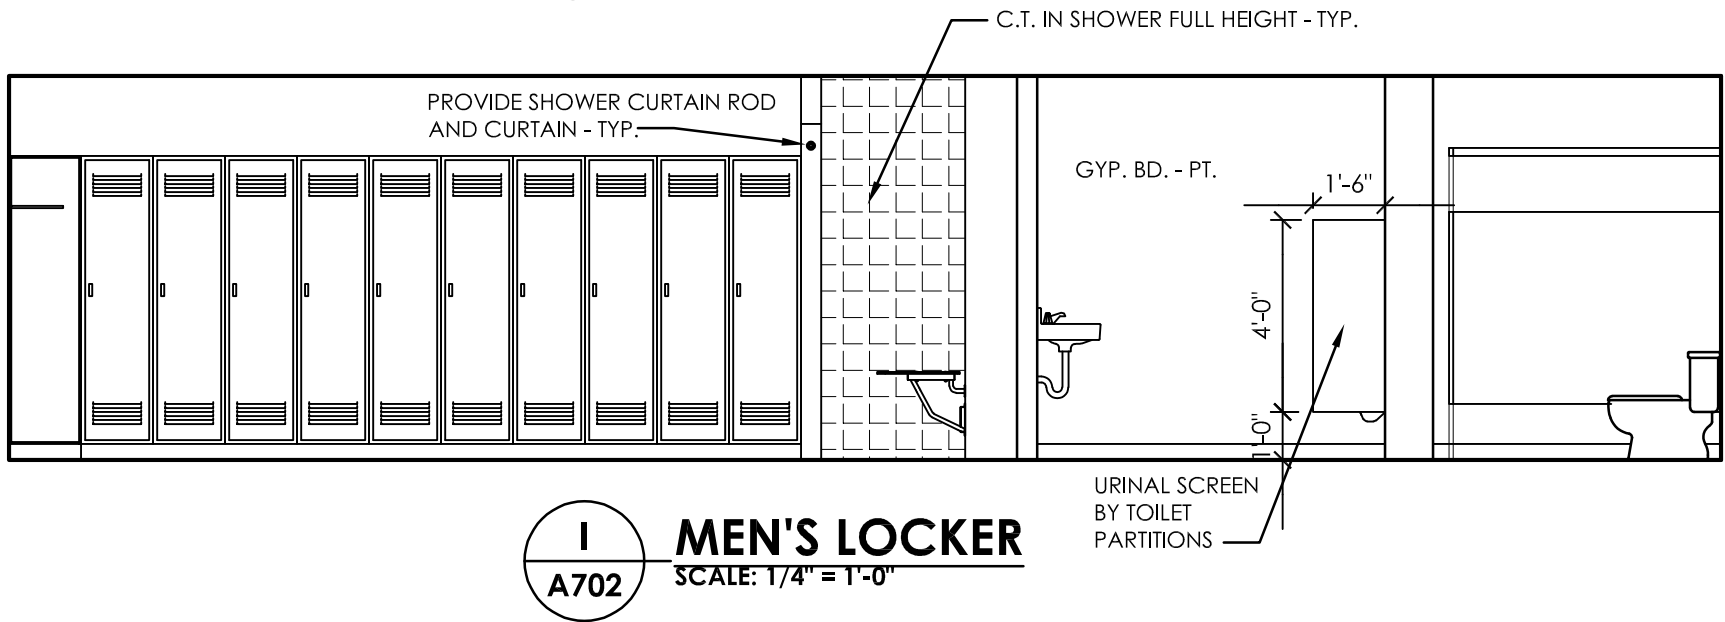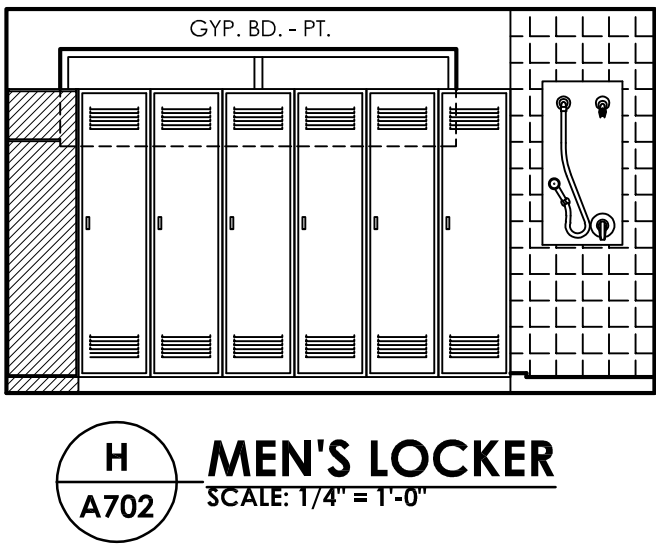
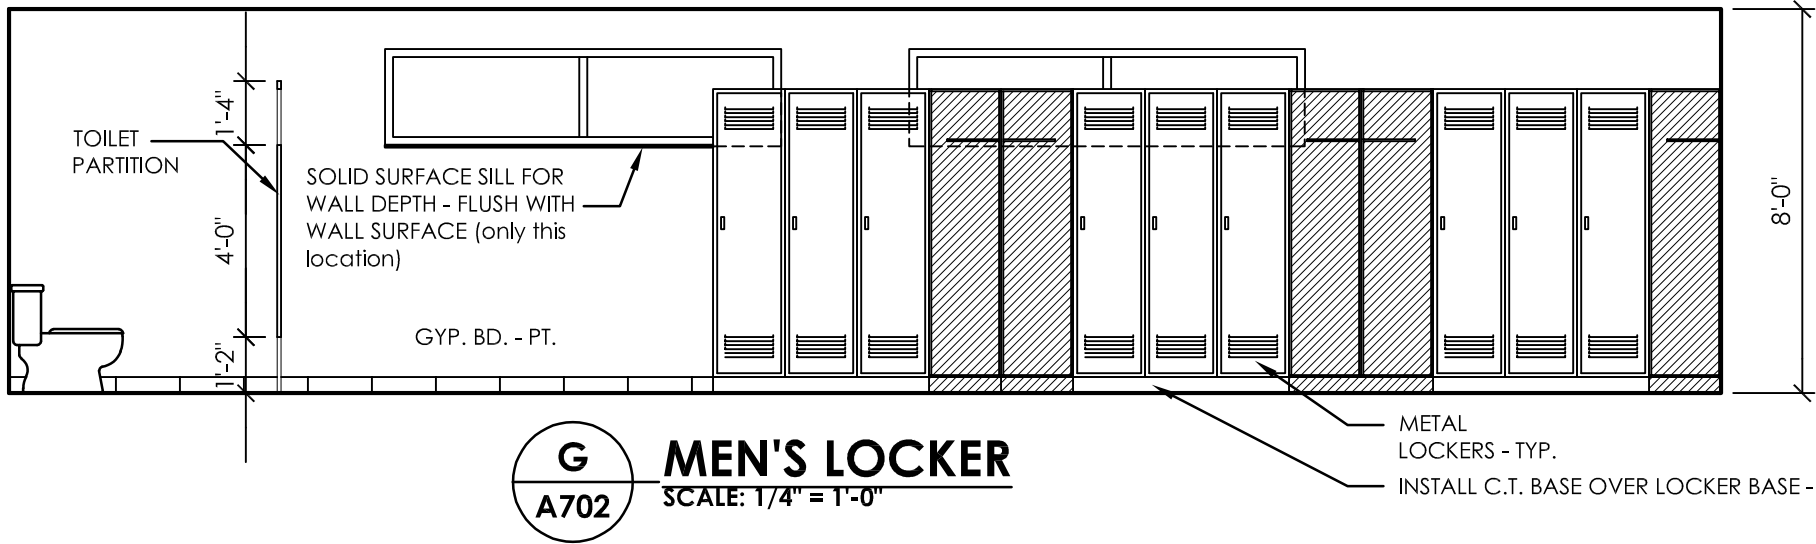


ROOM #	ROOM NAME	FLOOR	WALL BASE	WALLS				CEILING	REMARKS
				NORTH	SOUTH	EAST	WEST		
01	(E)CORRIDOR	CT	CT	PT-01	PT-01	PT-01	PT-01	ACT	
01A	CORRIDOR	CT	CT	PT-01	PT-01	PT-01	PT-01	ACT	
03	MEN'S LOCKER	CT	CT	EPT-02	EPT-02	EPT-02	EPT-02	ACT/GWB	C.T. WAINSCOT WET WALLS, FULL HT. IN SHOWER
04	WOMEN'S LOCKER	CT	CT	EPT-02	EPT-02	EPT-02	EPT-02	ACT/GWB	C.T. WAINSCOT WET WALLS, FULL HT. IN SHOWER
05	BREAK ROOM	LVT	RB	PT-03	PT-03	PT-03	PT-03	ACT	

- FINISH SCHEDULE NOTES:
- ALL FINISHES TO BE FINALIZED BY OWNER PRIOR TO INSTALLATION.
 - PROVIDE METAL TRANSITIONS FOR NEW FLOOR FINISHES AT DOOR OPENINGS AS NOTED IN DOOR SCHEDULE/THRESHOLD.
 - PAINT ALL EXISTING DOORS AND FRAMES IN CORRIDOR 01 & 01A.
 - PROVIDE MINIMUM OF (3) PAINT COLORS PLUS CEILING/SOFFIT COLOR.

FINISH SYMBOLS LEGEND & ABBREVIATIONS

ACT	ACOUSTICAL CEILING TILE	PT	PAINT
AFF	ABOVE FINISHED FLOOR	PTM	PATCH TO MATCH
CPT	CARPET TILE	RB	RESILIENT BASE
CT	CERAMIC TILE	SF	SPORTS FLOORING
EPT	EPOXY PAINT	SGT	STRUCTURAL GLAZED TILE
ETR	EXISTING TO REMAIN	SSM	SOLID SURFACE MATERIAL
GRT	GROUT	TER	TERRAZZO
GWB	GYPSUM WALL BOARD	TR	TRANSITION STRIP/TRIM PIECE
HPL	HIGH PRESSURE LAMINATE	VCT	VINYL COMPOSITION TILE
INT	INTEGRAL BASE	LVT	LUXURY VINYL TILE

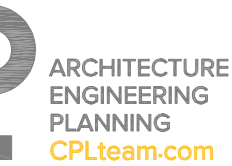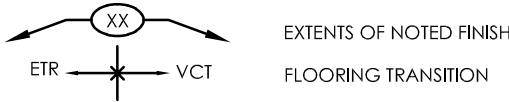


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REVISIONS			
DATE	DESCRIPTION	BY	SYM.




TITLE OF PROJECT ADDITIONS TO MAINTENANCE SECTION	CONTRACT NUMBER: TAS 25-9A
LOCATION OF PROJECT MANCHESTER MP 340.15	DATE: 07/30/2025
TITLE OF DRAWING INTERIOR ELEVATIONS	DRAWING NUMBER: A702


TA NUMBER/DWG NUMBER
XXX
CHECKED BY:
XXX
DRAFTED BY:
XXX
CHECKED BY:
XXX
DESIGNED BY:
J.L. MORRIS
BUREAU DIRECTOR:

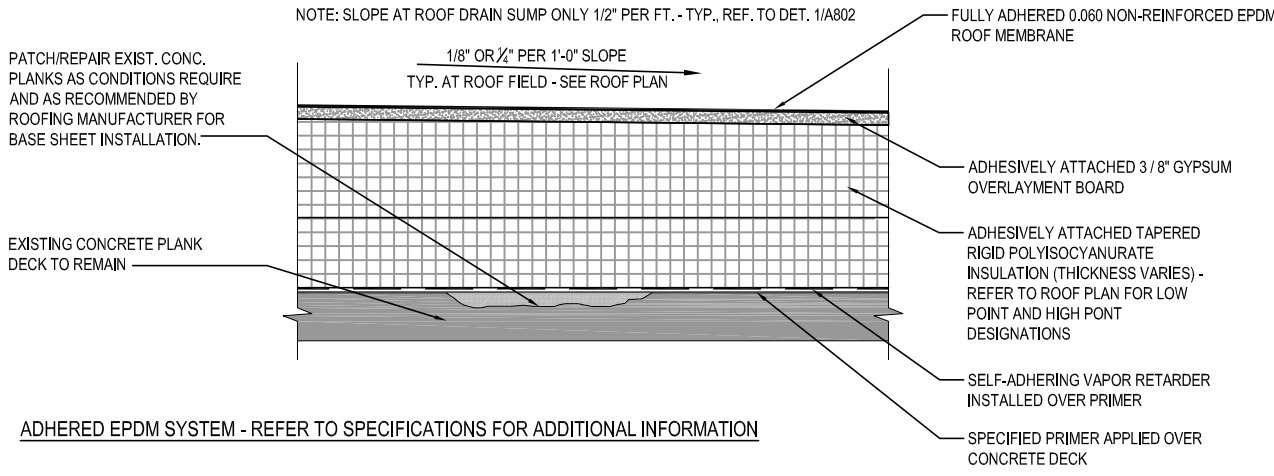


1
A801 **TYPICAL ROOF SYSTEM DETAIL - CONCRETE DECK**
SCALE: 1 1/2" = 1'-0"

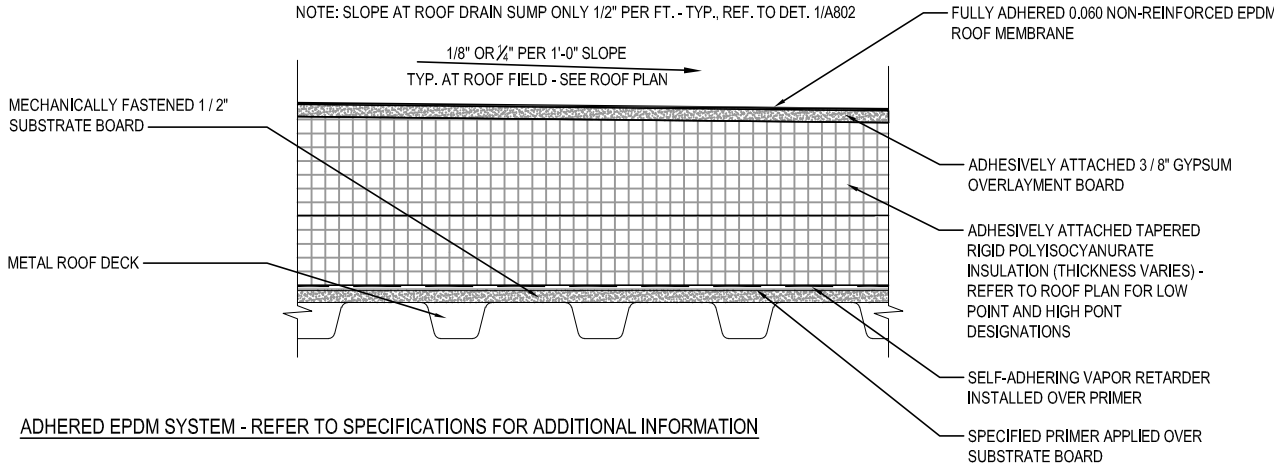


1A
A801 **TYPICAL ROOF SYSTEM DETAIL - METAL DECK**
SCALE: 1 1/2" = 1'-0"

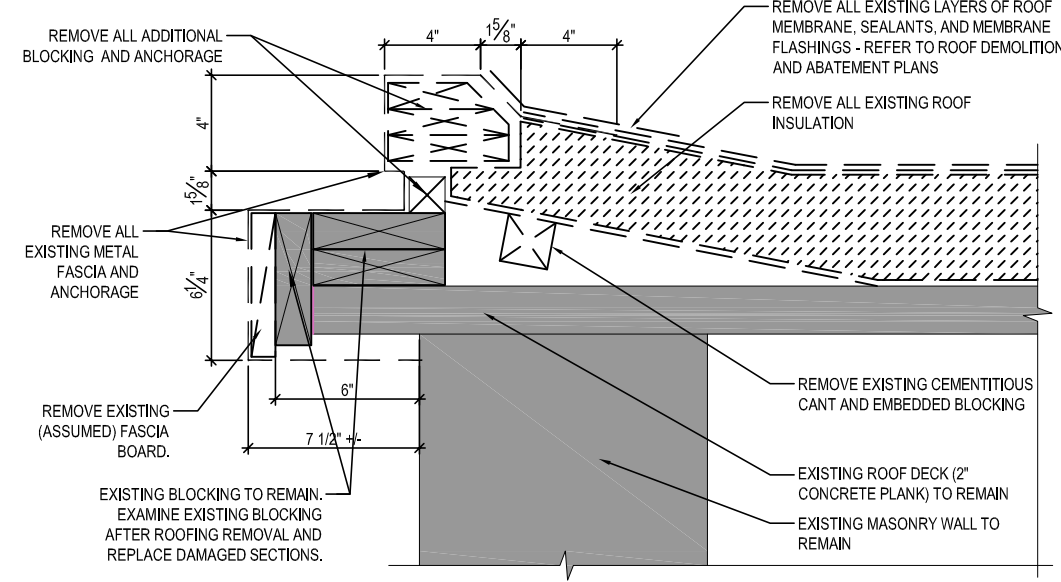

2
A801 **TYPICAL ROOF FASCIA REMOVAL DETAIL**
SCALE: 1 1/2" = 1'-0"

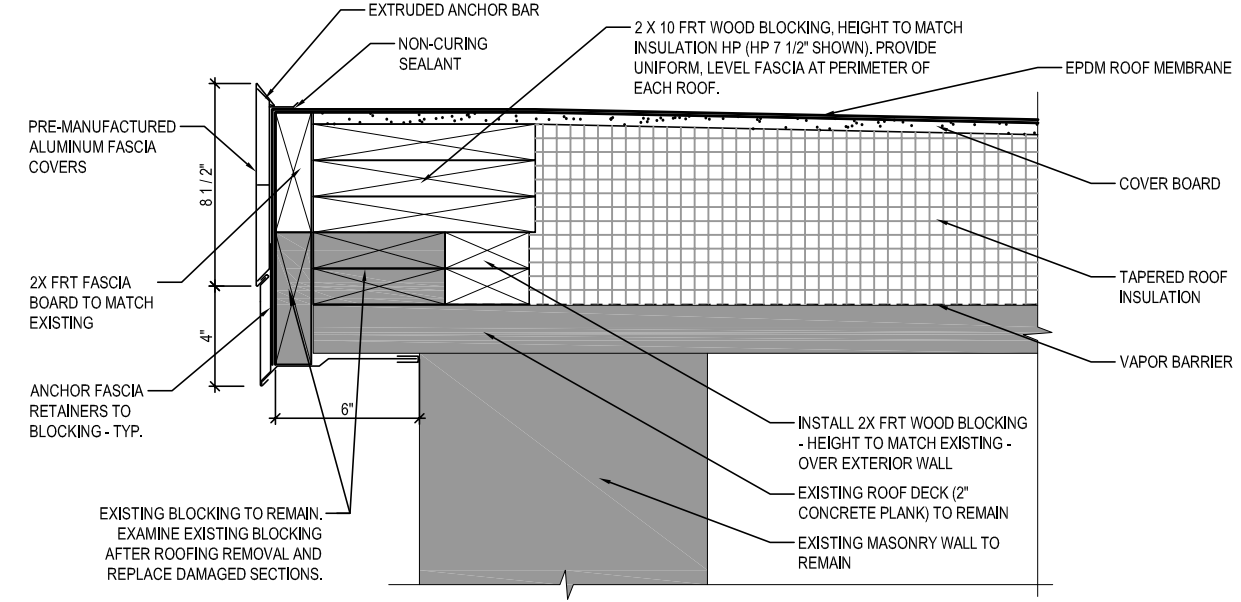

3
A801 **TYPICAL NEW ROOF FASCIA DETAIL**
SCALE: 1 1/2" = 1'-0"


ALTERED ON:	AFFIXED ON: 07/30/2025
SIGNATURE: STAMP:	SIGNATURE: STAMP: 



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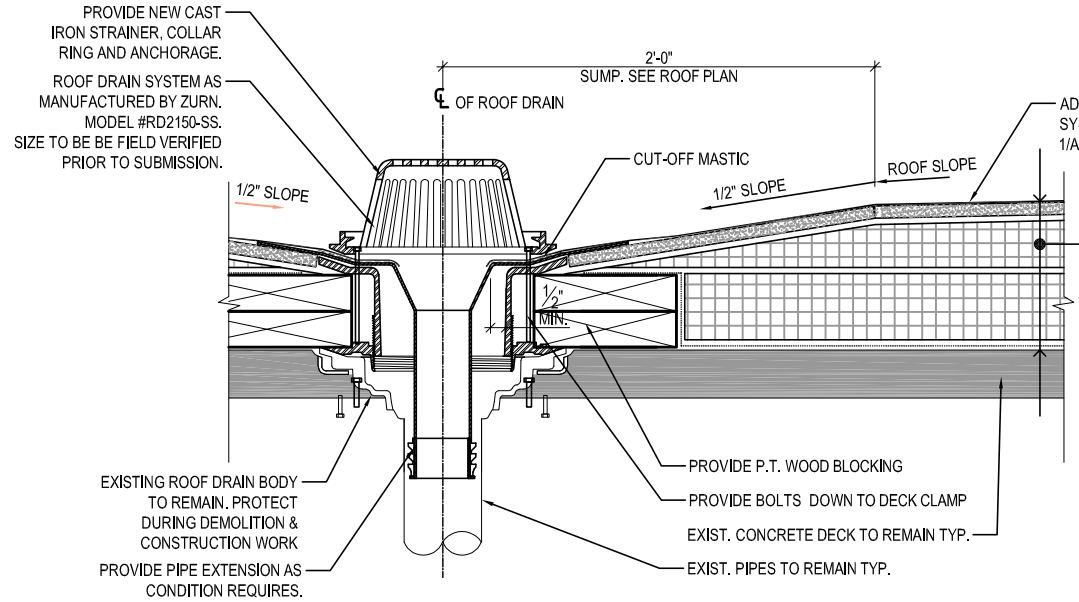
REVISIONS			
DATE	DESCRIPTION	BY	SYM.




Thruway
Authority

TITLE OF PROJECT ADDITIONS TO MAINTENANCE SECTION	CONTRACT NUMBER: TAS 25-9A
LOCATION OF PROJECT MANCHESTER MP 340.15	DATE: 07/30/2025
TITLE OF DRAWING ROOF DETAILS	DRAWING NUMBER: A801


TA NUMBER/DWG/DWG NUMBER
CHECKED BY: XXX
DRAFTED BY: XXX
CHECKED BY: XXX
DESIGNED BY: XXX
BUREAU DIRECTOR: J.L. MORRIS




1
A802
TYP. ROOF DRAIN FLASHING AND RETROFITTING DETAIL
SCALE: 1 1/2" = 1'-0"
NOTE: NEW ROOF DRAIN DETAIL SIMILAR.

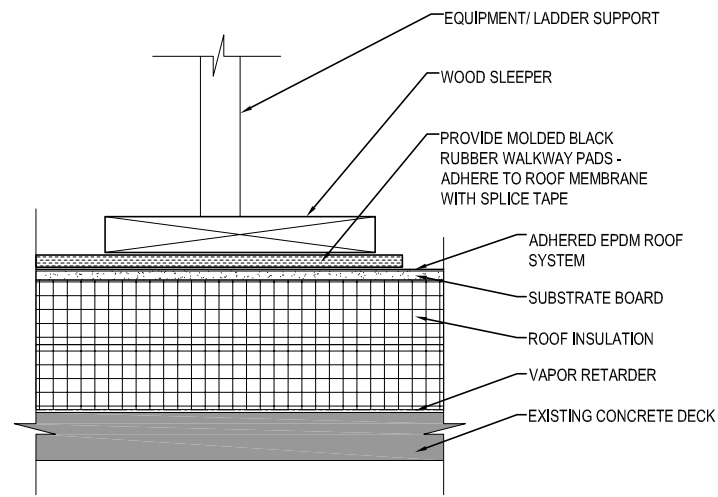


5
A802
ROOF WALKWAY DETAIL
SCALE: 1 1/2" = 1'-0"

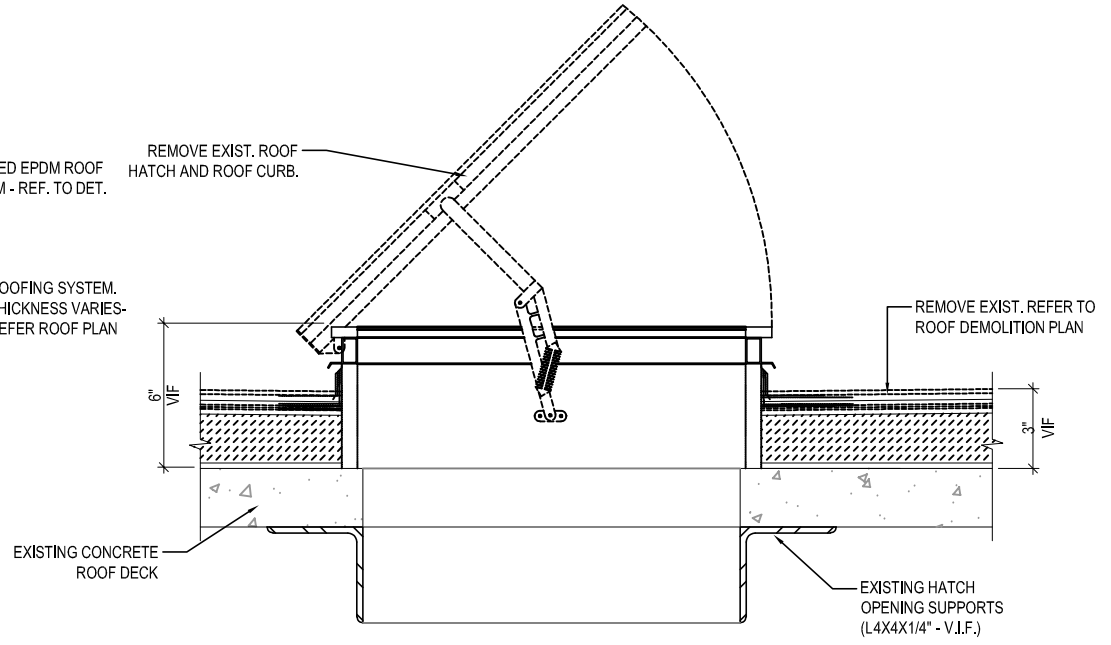

2
A802
EXISTING ROOF HATCH REMOVAL SECTION
SCALE: 1 1/2" = 1'-0"

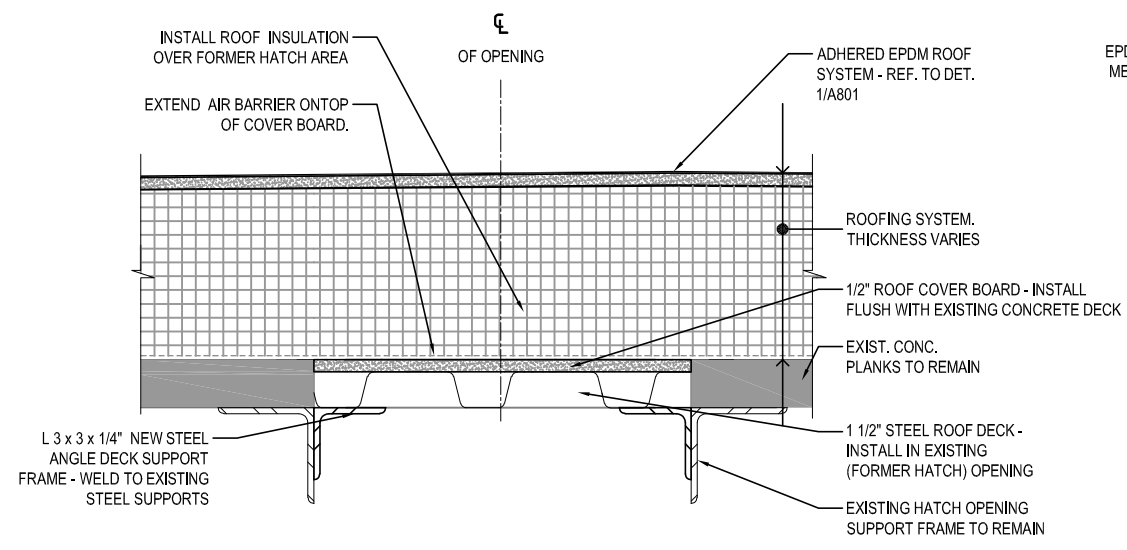


3
A802
ROOF HATCH ENCLOSURE
SCALE: 1 1/2" = 1'-0"

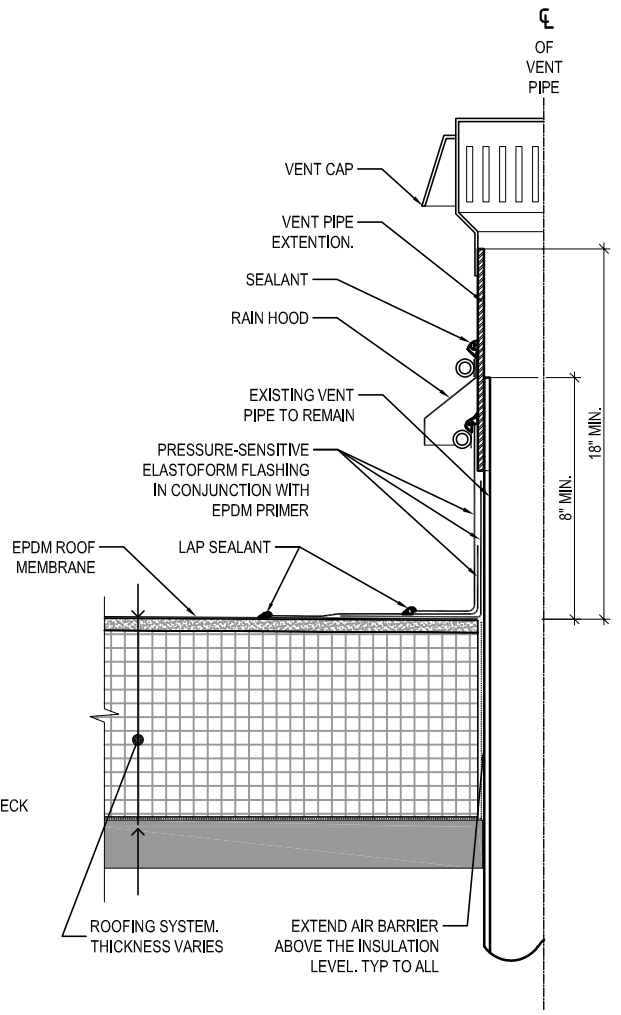

4
A802
TYP. ROOF VENT FLASHING AND EXTENSION DETAIL
SCALE: 1 1/2" = 1'-0"

NOTE: FLASHING SIMILAR FOR HOT VENT AND PLUMBING VENT THROUGH ROOF/ AS RECOMMENDED BY ROOF MANUFACTURER

ALTERED ON:	AFFIXED ON: 07/30/2025
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REVISIONS			
DATE	DESCRIPTION	BY	SYM.

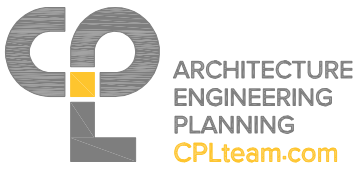

TITLE OF PROJECT ADDITIONS TO MAINTENANCE SECTION	CONTRACT NUMBER: TAS 25-9A
LOCATION OF PROJECT MANCHESTER MP 340.15	DATE: 07/30/2025
TITLE OF DRAWING ROOF DETAILS	DRAWING NUMBER: A802

TA NUMBER/DWG/DWG NUMBER

XXX

CHECKED BY:

XXX

DRAFTED BY:


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CHECKED BY:

XXX

DESIGNED BY:


BUREAU DIRECTOR: J.L. MORRIS

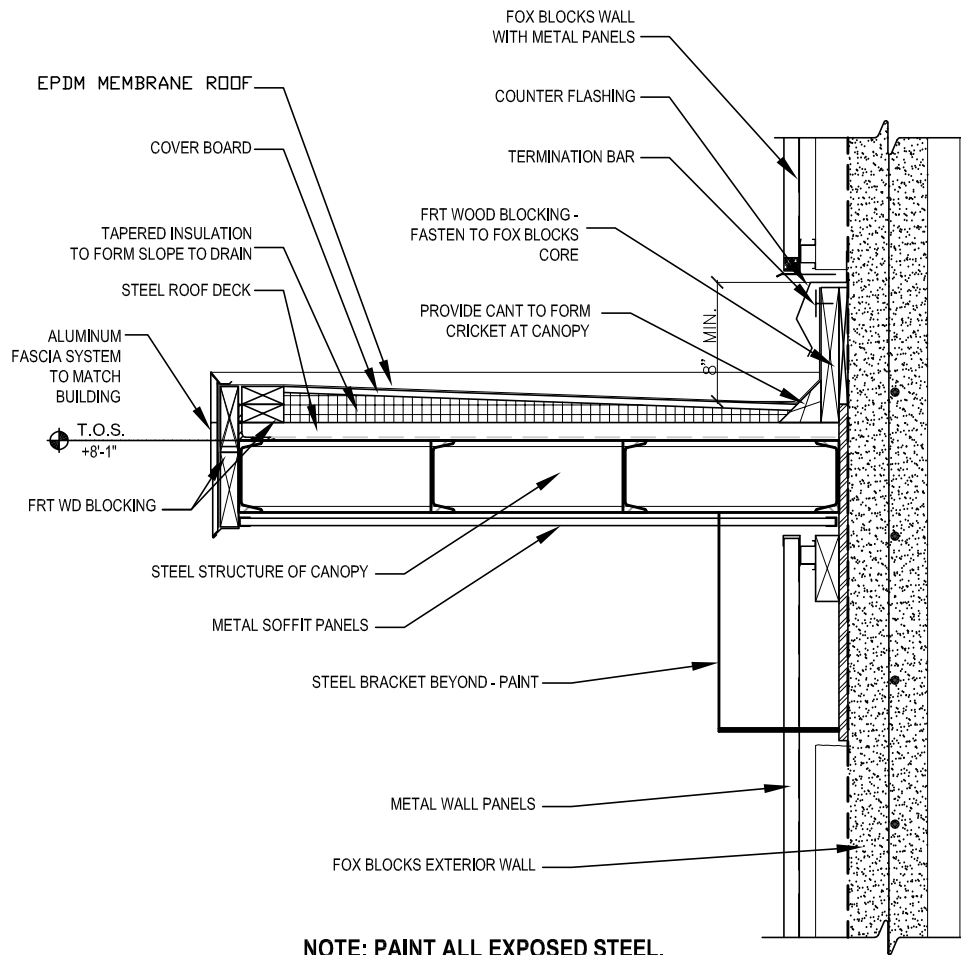

NOTE: PAINT ALL EXPOSED STEEL.


1 CANOPY SECTION

SCALE: 3/4" = 1'-0"

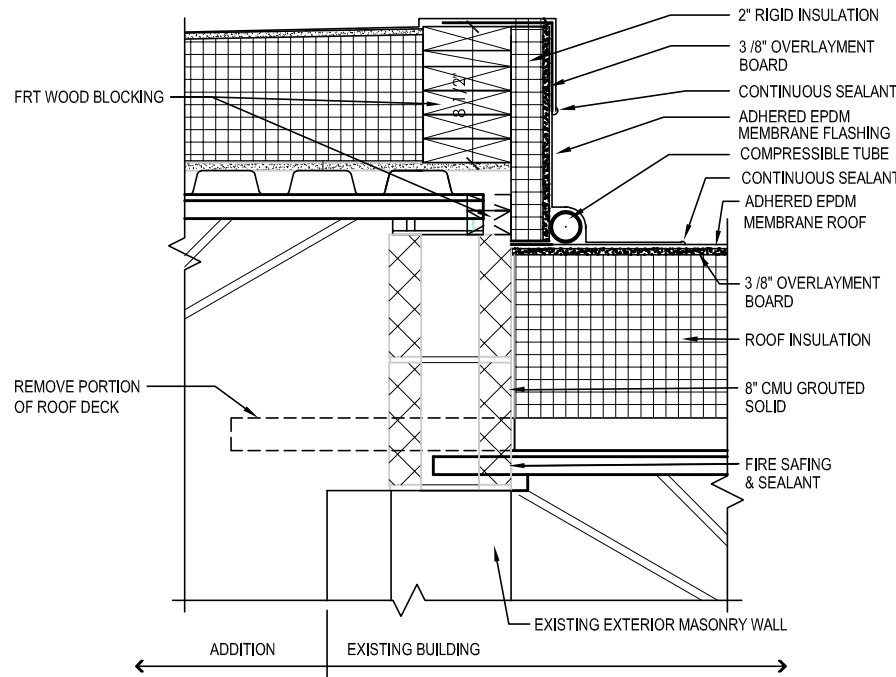


2 EXPANSION JOINT DETAIL

SCALE: 1" = 1'-0"

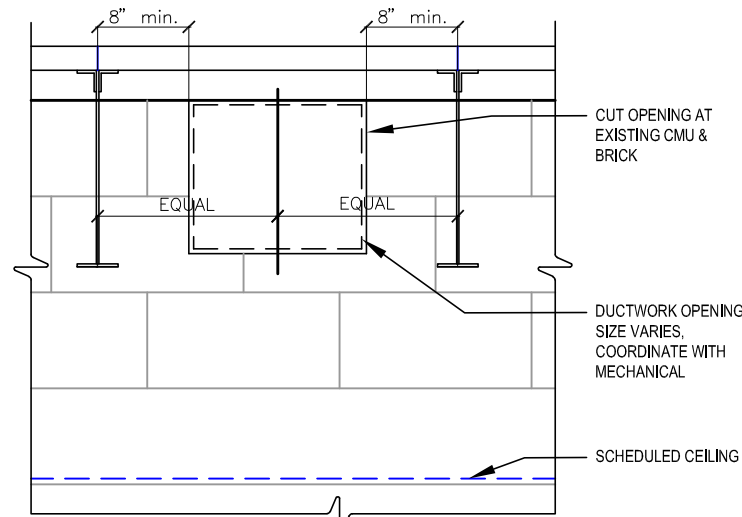


5 WALL OPENING

SCALE: 3/4" = 1'-0"

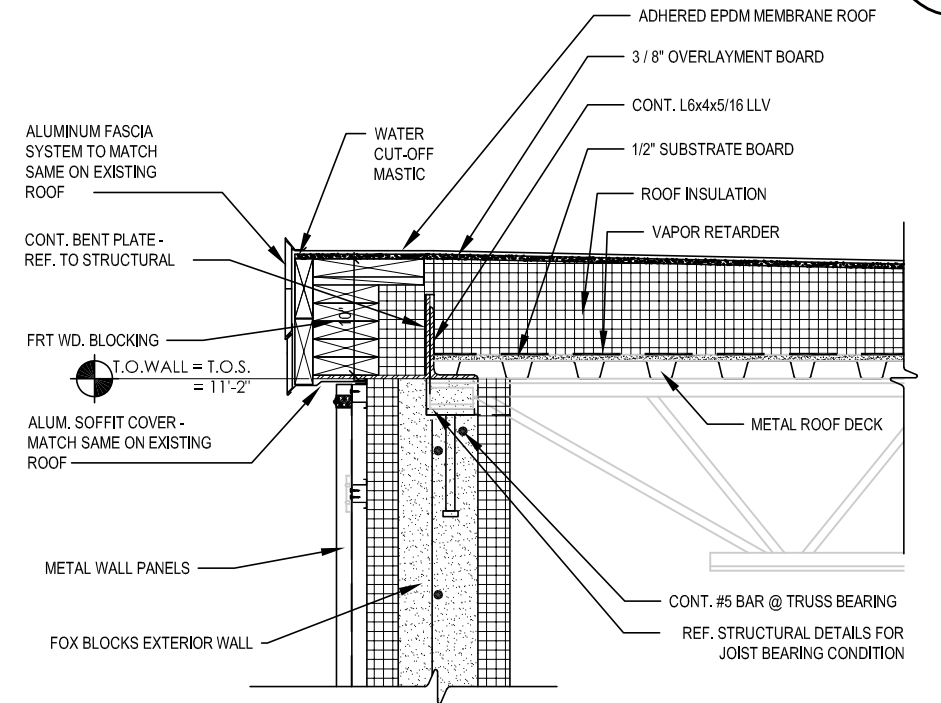

3 NEW ROOF EDGE DETAIL


SCALE: 3/4" = 1'-0"

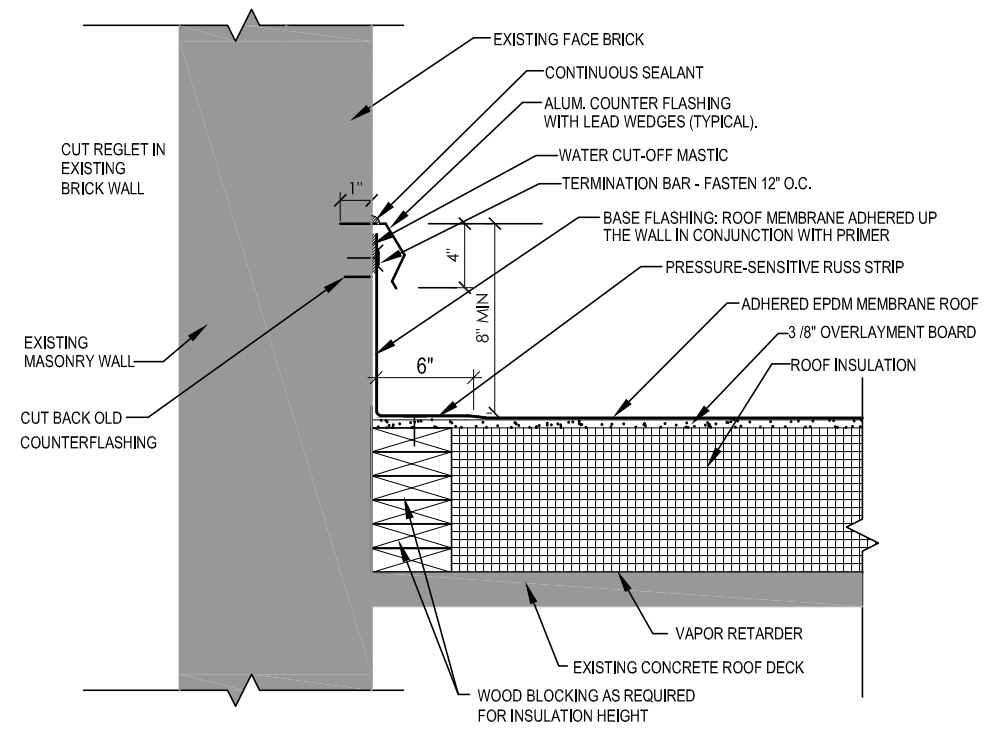

4 FLASHING DETAIL



SCALE: 1" = 1'-0"

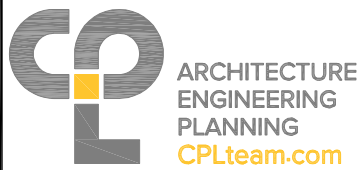
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	07/30/2025
SIGNATURE:	SIGNATURE:
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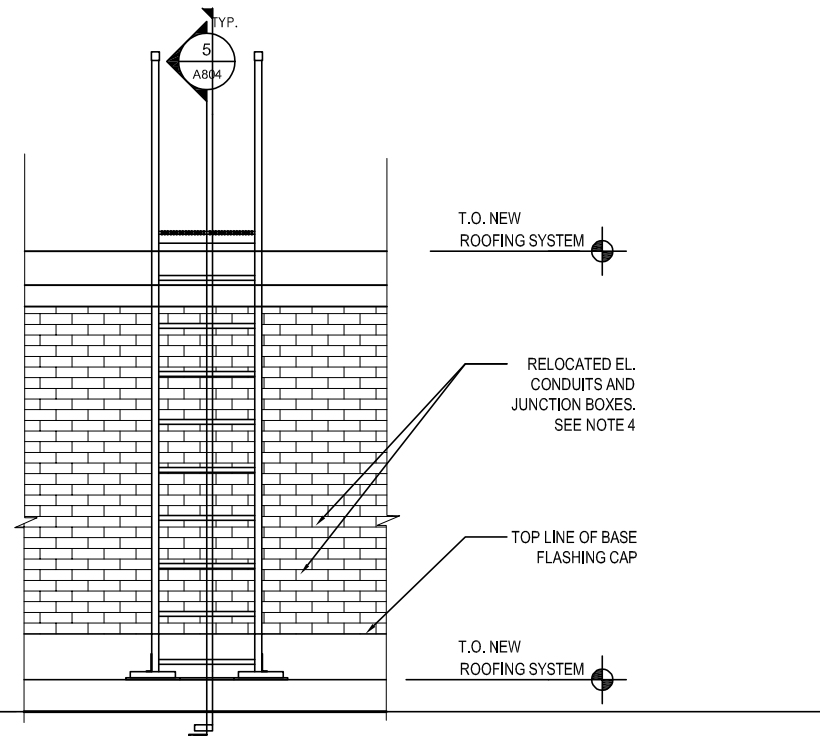
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REVISIONS			
DATE	DESCRIPTION	BY	SYM.


 	TITLE OF PROJECT	CONTRACT NUMBER:
	ADDITIONS TO MAINTENANCE SECTION	TAS 25-9A
	LOCATION OF PROJECT: MANCHESTER MP 340.15	DATE: 07/30/2025
TITLE OF DRAWING	DRAWING NUMBER:	
ROOF DETAILS	A803	

**1**
A804**LADDER REMOVAL AT EAST FACADE**


SCALE: 1/4" = 1'-0"

**2**
A804**LADDER ELEVATION AT EAST FACADE**

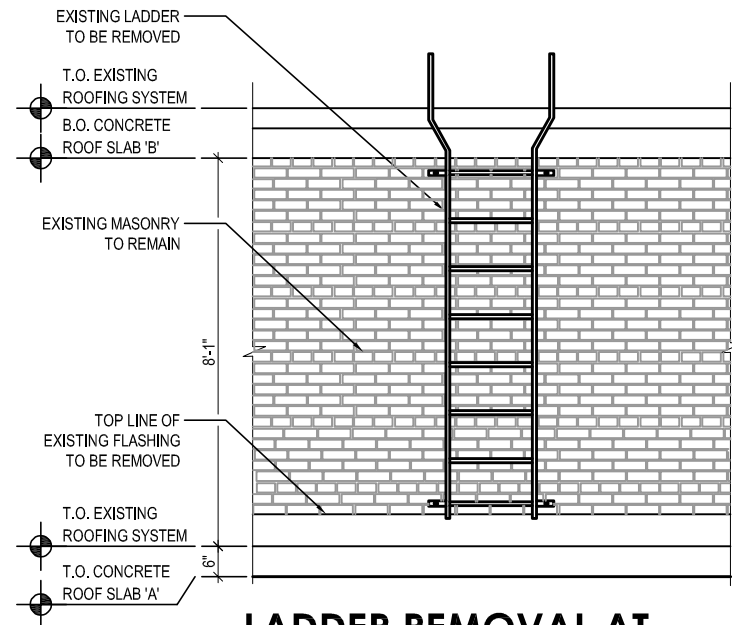SCALE: 1/4" = 1'-0"

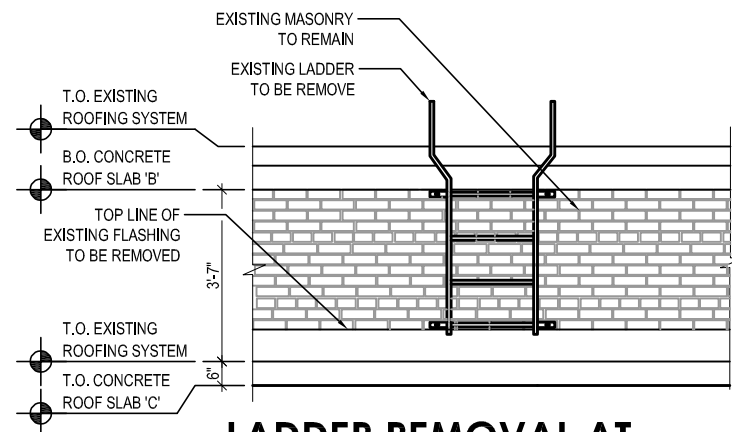
**3**
A804**LADDER REMOVAL AT WEST FACADE**

SCALE: 1/4" = 1'-0"

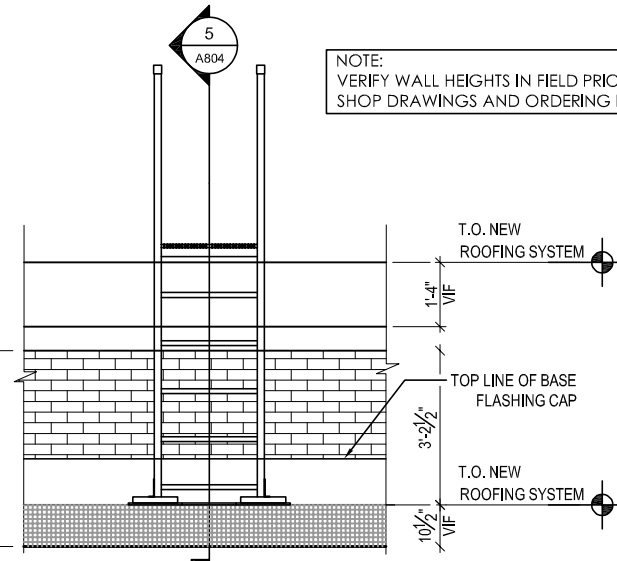**4**
A804**LADDER ELEVATION AT WEST FACADE**

SCALE: 1/4" = 1'-0"

NOTE:
VERIFY WALL HEIGHTS IN FIELD PRIOR TO PROVIDING
SHOP DRAWINGS AND ORDERING LADDERS.

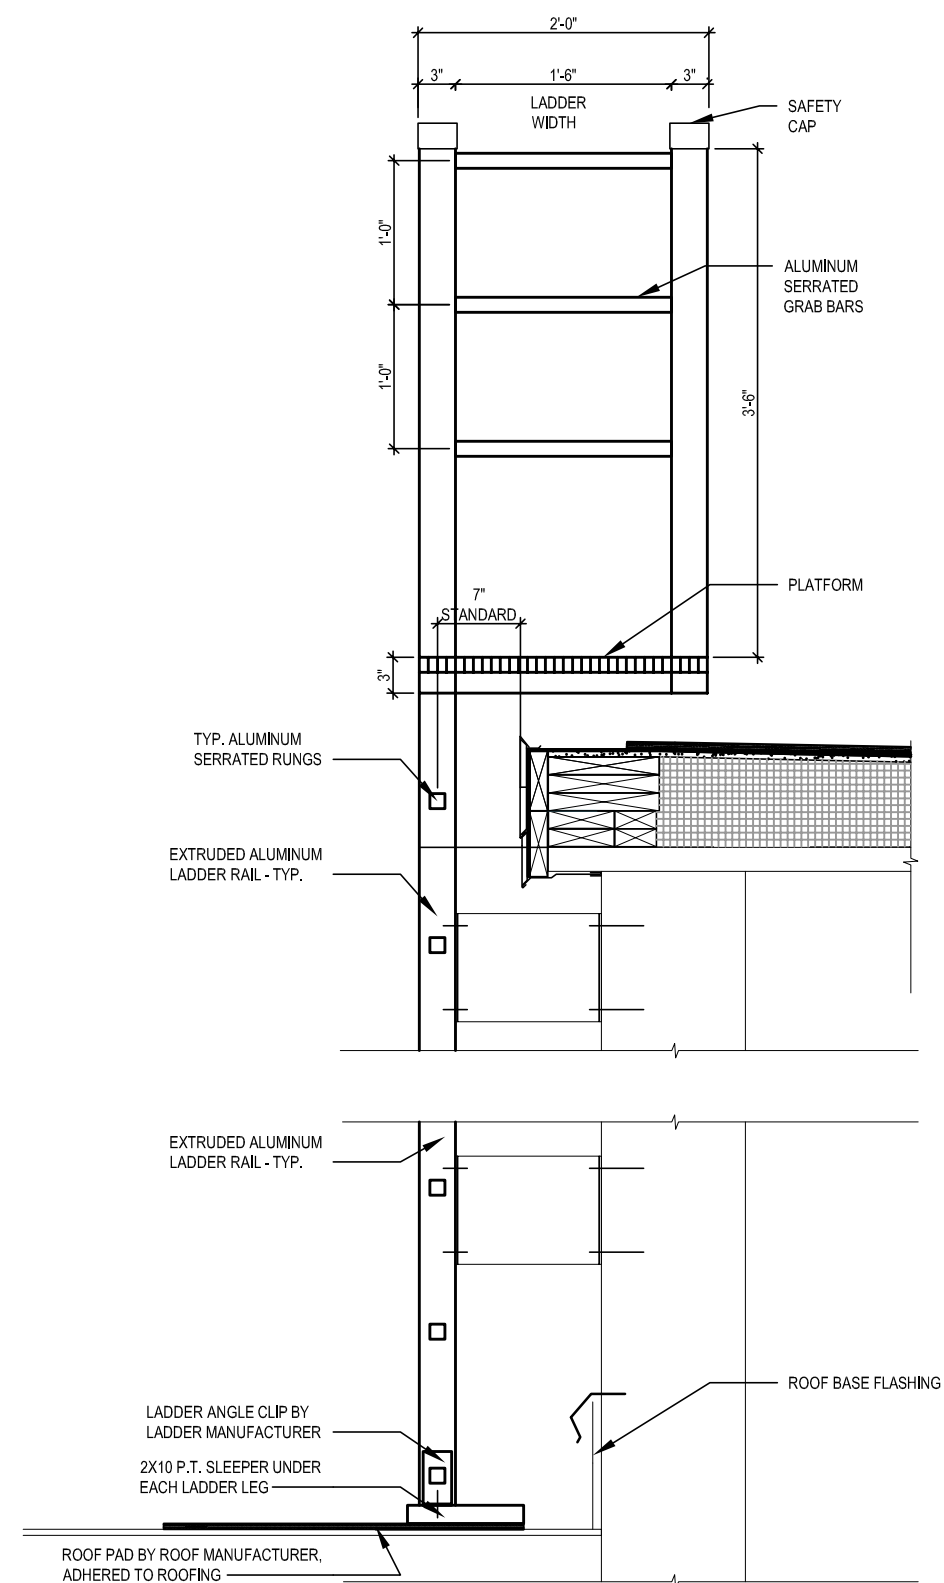
**5**
A804**SECTION THROUGH EAST/WEST LADDER**

SCALE: 1 1/2" = 1'-0"

ALTERED ON:

AFFIXED ON:

07/30/2025

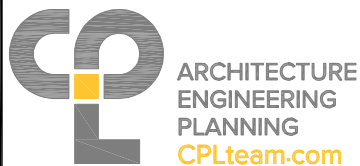SIGNATURE:
STAMP:SIGNATURE:
STAMP:

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REVISIONS

DATE	DESCRIPTION	BY	SYM.




TITLE OF PROJECT
ADDITIONS TO MAINTENANCE
SECTION
LOCATION OF PROJECT
MANCHESTER
MP 340.15
TITLE OF DRAWING
ROOF LADDERS DETAILS

CONTRACT NUMBER:
TAS 25-9A
DATE:
07/30/2025
DRAWING NUMBER:
A804

TA NUMBER/DWG/DWG NUMBER
XXX
CHECKED BY: XXX
DRAFTED BY: XXX
CHECKED BY: XXX
DESIGNED BY: XXX
BUREAU DIRECTOR: J. L. MORRIS

WINDOW SCHEDULE								
TYPE	UNIT SIZE		MATERIAL	ROUGH OPENING		GLAZING		REMARKS
	WIDTH	HEIGHT		WIDTH	HEIGHT	TYPE	THICKNESS	
W01	4'-0"	4'-2"	ALUMINUM	4'-1"	4'-3"	SLIDING	1" INSULATED LOW-E	NEW WINDOW IN ADDITION
W02	8'-3" +/-	2'-0"	ALUMINUM	8'-3" V.I.F.	2'-1"	FIXED	1" INSULATED LOW-E	NEW WINDOW IN EXISTING MASONRY OPENING WIDTH.
W03	3'-0"	4'-2"	ALUMINUM	3'-1"	4'-3"	FIXED	1" INSULATED LOW-E	NEW WINDOW IN ADDITION
W04	8'-3" +/-	4'-2"	ALUMINUM	8'-3" V.I.F.	4'-3" V.I.F.	SLIDING	1" INSULATED LOW-E	NEW WINDOW IN EXISTING MASONRY OPENING (OFFICE)
W05	4'-2" +/-	4'-2" +/-	ALUMINUM	4'-2" V.I.F.	4'-3" V.I.F.	SLIDING	1" INSULATED LOW-E	NEW WINDOW IN EXISTING MASONRY OPENING (OFFICE)
W06	8'-3" +/-	8'-3" +/-	ALUMINUM	8'-3" V.I.F.	8'-3" V.I.F.	FIXED	1" INSULATED LOW-E	NEW WINDOW IN EXISTING MASONRY OPENING (GARAGE)
W07	8'-3" +/-	4'-2" +/-	ALUMINUM	8'-3" V.I.F.	4'-3" V.I.F.	FIXED	1" INSULATED LOW-E	NEW WINDOW IN EXISTING MASONRY OPENING (GARAGE)

- NOTES:
- VERIFY IN FIELD ALL ROUGH OPENINGS - NEW AND EXISTING - PRIOR TO ORDERING WINDOWS.
 - REFER TO EXISTING WINDOW REPLACEMENT NOTES ON DRAWING GN-2
 - VERIFY ROUGH OPENING TO UNIT SIZE REQUIREMENTS WITH WINDOW MANUFACTURER.

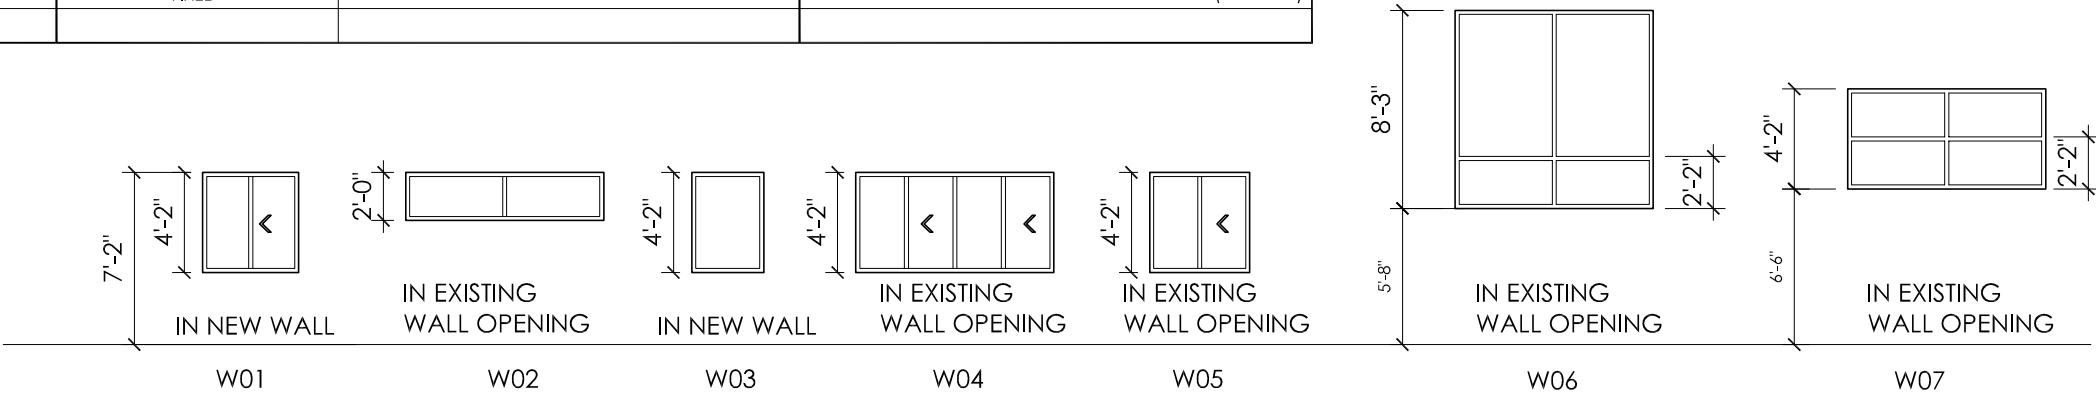

WINDOW TYPES

NOTE: GLASS IN WINDOWS TO BE I-2

DOOR SCHEDULE																	
DOORS							LABEL RATING	FRAMES					THRESHOLD	GLASS TYPE	HARDWARE	REMARKS	
DOOR NO.	SIZE			TYPE	MATERIAL / FINISH	UNDERCUT		OVERALL SIZE			TYPE	HEAD/JAMB DETAIL NUMBERS					MATERIAL / FINISH
	WIDTH	HEIGHT	TH.					WIDTH	HEIGHT	DEPTH							
00-1	---	---	---	---	---	---	---	---	---	---	---	---	---	---	---	---	PAINT EXISTING DOOR & FRAME
01A-1	3'-0"	7'-0"	1 3/4"	D1	EXT. HM-PT	-	-	3'-4"	7'-2"	5 3/4"	F1	2/A800	HM/PT	ALUM. 8/A800	I-1	1	REVISE OPENING IN EXISTING MASONRY, PROVIDE NEW STEEL LINTEL, PAINT LINTEL. COORDINATE ACCESS CONTROL WITH OWNER.
03-1	3'-0"	7'-0"	1 3/4"	D2	HM-PT	-	-	3'-4"	7'-2"	5 3/4"	F1	2/A800	HM/PT	MARBLE	-	2	
04-1	3'-0"	7'-0"	1 3/4"	D2	HM-PT	-	-	3'-4"	7'-2"	5 3/4"	F1	1/A800	HM/PT	MARBLE	-	2	
05-1	3'-0"	7'-0"	1 3/4"	D1	EXT. HM-PT	-	-	3'-4"	7'-2"	5 3/4"	F1	3/A800	HM/PT	ALUM. 8/A800	I-1	1	COORDINATE ACCESS CONTROL WITH OWNER.
05-2	3'-0"	7'-0"	1 3/4"	D1	EXT. HM-PT	-	-	3'-4"	7'-2"	5 3/4"	F1	3/A800	HM/PT	ALUM. 8/A800	I-1	1	COORDINATE ACCESS CONTROL WITH OWNER.
05-3	3'-0"	7'-0"	1 3/4"	D1	HM-PT	-	-	3'-4"	7'-2"	5 3/4"	F1	1/A800	HM/PT	TRANSITION STRIP	S-1	3	


NOTE:
REFER TO SPECIFICATION SECTION 87100 FOR HARDWARE SETS

ALTERED ON:


AFFIXED ON:
07/30/2025

SIGNATURE:
STAMP:

EXP. 05/31/2026

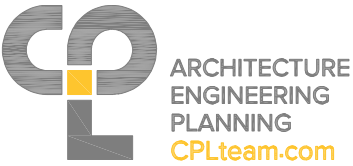

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DOOR TYPES

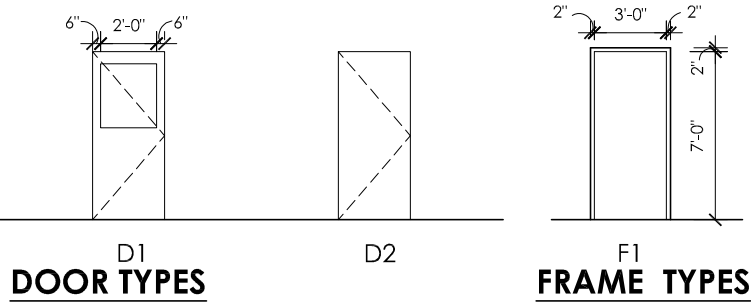FRAME TYPES

- GLASS TYPES:
- I-1 1" INSULATED SAFETY GLASS
 - I-2 1" INSULATED LOW-E GLASS
 - S-1 1/4" SAFETY GLASS

REVISIONS			
DATE	DESCRIPTION	BY	SYM.



TITLE OF PROJECT ADDITIONS TO MAINTENANCE SECTION	CONTRACT NUMBER: TAS 25-9A
LOCATION OF PROJECT MANCHESTER MP 340.15	DATE: 07/30/2025
TITLE OF DRAWING DOOR AND WINDOW SCHEDULES	DRAWING NUMBER: A900


DESIGNED BY: J.L. MORRIS
BUREAU DIRECTOR:
CHECKED BY: SRZ
DRAFTED BY: RPM

HVAC ABBREVIATIONS				HVAC DUCTWORK SYMBOLS		HVAC GENERAL NOTES	
A/C	AIR CONDITIONING	HVAC	HEATING, VENTILATING, AIR CONDITIONING	A/C	DUCTWORK	<p>A. CONTRACTOR IS RESPONSIBLE FOR PROPER FIELD FITTING AND QUANTITY OF WORK. CONTRACTOR SHALL TAKE FIELD MEASUREMENTS AS REQUIRED AND BE RESPONSIBLE FOR FITTING NEW CONSTRUCTION TO EXISTING CONSTRUCTION. CONTRACTOR SHALL BE RESPONSIBLE TO REPAIR ANY EXISTING CONDITIONS DISTURBED OR DAMAGED DURING CONSTRUCTION (TO MATCH EXISTING). REPAIRED WORK SHALL BE REVIEWED & APPROVED BY ARCHITECT AND ENGINEER OF RECORD.</p> <p>B. CONTRACTOR IS RESPONSIBLE FOR SITE INVESTIGATION PRIOR TO START OF WORK TO REVEAL EXISTING CONDITIONS.</p> <p>C. CONTRACTOR SHALL EXAMINE ALL DRAWINGS AND SPECIFICATIONS AND COORDINATE WORK WITH ALL OTHER TRADES.</p> <p>D. PROVIDE ALL CUTTING, PATCHING AND FIRE STOPPING REQUIRED TO ACCOMPLISH WORK SHOWN. PATCH AND SEAL OPENINGS TO MATCH ADJACENT EXISTING WALLS, FLOORS, CEILINGS, ETC. UNLESS OTHERWISE INDICATED. CONCEAL ALL WORK IN FINISHED AREAS UNLESS OTHERWISE INDICATED OR DIRECTED BY THE ARCHITECT AND ENGINEER OF RECORD.</p> <p>E. CONTRACTOR SHALL FIELD VERIFY ALL LOCATIONS, DIMENSIONS AND EXISTING CONDITIONS (PIPING, DUCTWORK, EQUIPMENT, STRUCTURAL ELEMENTS, ETC.) PRIOR TO STARTING WORK. CONTRACTOR SHALL COORDINATE INSTALLATION OF EQUIPMENT AND DUCTWORK WITH EXISTING CONDITIONS AND OTHER TRADES. PROVIDE FITTINGS, TRANSITIONS, OFFSETS, ELEVATION CHANGES, ETC. TO MINIMIZE CONFLICTS WITH EXISTING CONDITIONS.</p> <p>F. CONTRACTOR SHALL COORDINATE CONNECTIONS TO ALL MECHANICAL EQUIPMENT, DUCTWORK, AIR OUTLET, AND ACCESSORY.</p> <p>G. DRAWINGS ARE SCHEMATIC, AND SERVE TO INDICATE THE TYPE AND LOCATION OF MAJOR PIECES OF EQUIPMENT. THIS CONTRACTOR SHALL PROVIDE AND INSTALL ALL MATERIALS, EQUIPMENT, AND LABOR NECESSARY FOR A COMPLETE INSTALLATION PER DESIGN INTENT. ADJUST THE LOCATION OF ALL DUCTWORK, WIRING, EQUIPMENT, AND CONNECTIONS TO ACCOMMODATE ACTUAL CONSTRUCTION CONDITIONS ENCOUNTERED; OBTAIN APPROVAL FROM THE ENGINEER FOR ALL CHANGES. IN ALL CASES EQUIPMENT AND DEVICES SHALL BE FULLY ACCESSIBLE AND MAINTAINABLE PER MANUFACTURER'S GUIDELINES & MAINTENANCE REQUIREMENTS.</p> <p>H. INSTALL ALL EQUIPMENT AND SYSTEMS IN COMPLETE COMPLIANCE WITH 2020 NYSBC, 2020 NYSMC, 2020 NYSECCC, MANUFACTURERS INSTALLATION INSTRUCTIONS, AND SPECIFICATIONS.</p> <p>I. ALL PHYSICAL ATTRIBUTES OF EQUIPMENT AND DEVICES ARE BASED ON THOSE MANUFACTURERS LISTED IN THE SPECIFICATIONS AND/OR THE EQUIPMENT SCHEDULES. THE RESPECTIVE CONTRACTORS ARE RESPONSIBLE FOR ALL CHANGES AND ASSOCIATED COSTS BROUGHT ABOUT BY THE USE OF ITEMS BY OTHER MANUFACTURERS. THE ARCHITECT/ENGINEER HAS RESERVED THE RIGHT TO REJECT ITEMS BY OTHER MANUFACTURERS FOR REASONS INCLUDING, BUT NOT LIMITED TO, THOSE ITEMS NOT MATCHING THE PHYSICAL ATTRIBUTES OF THE MANUFACTURERS LISTED.</p> <p>J. THE EXISTING MECHANICAL SYSTEMS, OR PORTIONS THEREOF, SHALL REMAIN IN SERVICE THROUGHOUT CONSTRUCTION. ALL SYSTEM INSTALLATIONS AND EXISTING SYSTEM DEMOLITION SHALL BE COORDINATED TO MINIMIZE SYSTEM DOWNTIME.</p> <p>K. PROVIDE ANY AND ALL NECESSARY TEMPORARY SERVICES TO ADEQUATELY CONDITION THE BUILDING DURING ALL PHASES OF CONSTRUCTION. SCHEDULE SYSTEMS SHUTDOWNS WITH OWNER, SYSTEM SHUTDOWNS SHALL NOT INTERFERE WITH BUILDING OPERATIONS.</p> <p>L. COORDINATE DUCT INSTALLATION WITH ELECTRICAL DEVICES. DO NOT INSTALL PIPING OR DUCTWORK IN PROHIBITED LOCATIONS SUCH AS ABOVE ELECTRICAL PANELS, WITHIN HIGH VOLTAGE ROOMS, ETC. COMPLY WITH NEC REQUIREMENTS.</p> <p>M. REFER TO ARCHITECTURAL REFLECTED CEILING PLAN DRAWINGS FOR DIFFUSER AND REGISTER LOCATIONS WITH RESPECT TO OTHER ELEMENTS.</p> <p>N. CAP ALL EXISTING DUCT OPENINGS AIRTIGHT CREATED BY REMOVALS WORK. THIS APPLIES TO THOSE ITEMS NOT IDENTIFIED FOR REUSE.</p>	
AD	ACCESS DOOR	HX	HEAT EXCHANGER	---	EXISTING DUCTWORK TO REMAIN		
AFF	ABOVE FINISH FLOOR	HZ	HERTZ	---	DUCTWORK TO BE REMOVED		
AFR	ABOVE FINISH ROOF			---	EQUIPMENT		
AHU	AIR HANDLING UNIT	IN	INCH(ES)	□	EXISTING EQUIPMENT TO REMAIN		
BDD	BACK DRAFT DAMPER	KW	KILOWATT	□	EXISTING EQUIPMENT TO BE REMOVED		
BHP	BRAKE HORSE POWER			20X12SA	DUCT SIZE & TYPE		
BMS	BUILDING MANAGEMENT SYSTEM	LAT	LEAVING AIR TEMPERATURE	A	TRANSITION, CONCENTRIC		
BOD	BOTTOM OF DUCT	LDB	LEAVING DRY BULB TEMPERATURE	A	TRANSITION, ECCENTRIC		
BTU	BRITISH THERMAL UNIT	LWB	LEAVING WET BULB TEMPERATURE	⊠	DUCT SECTION, POSITIVE PRESSURE		
CFM	CUBIC FEET PER MINUTE	LWT	LEAVING WATER TEMPERATURE	⊟	DUCT SECTION, NEGATIVE PRESSURE		
CO	CLEAN OUT	MAU	MAKEUP AIR UNIT	⊞	POSITIVE PRESSURE DUCT THRU FLOOR OR ROOF		
CO2	CARBON DIOXIDE	MAX	MAXIMUM	⊟	NEGATIVE PRESSURE DUCT THRU FLOOR OR ROOF		
COND	CONDENSATE	MBH	THOUSAND BTU'S PER HOUR	⌢	MITERED ELBOW		
CP	CONDENSATE PUMP	MCA	MINIMUM CIRCUIT AMPS	⌣	RADIUSSED ELBOW		
CUH	CABINET UNIT HEATER	MIN	MINIMUM	AD	ACCESS DOOR, SIDE OR BOTTOM		
CV	CONTROL VALVE	MOCPP	MAXIMUM OVER CURRENT PROTECTION	AD	DUCT CAP		
DB	DRY BULB	NC	NORMALLY CLOSED	⌢	FLEXIBLE DUCT CONNECTION		
DCV	DEMAND CONTROL VENTILATION	NIC	NOT IN CONTRACT	⌣	POSITIVE PRESSURE DUCT DOWN		
DDC	DIRECT DIGITAL CONTROL	NO	NORMALLY OPEN	⌣	NEGATIVE PRESSURE DUCT DOWN		
DIA	DIAMETER	NTS	NOT TO SCALE	⌣	DUCT BREAK		
DN	DOWN			FDx	FIRE DAMPER, "X" DENOTES RATING 1=1.5HR, 3=3HR		
DX	DIRECT EXPANSION	OA	OUTDOOR AIR	SD	SMOKE DAMPER		
EA	EXHAUST AIR	OAT	OUTDOOR AIR TEMPERATURE	FSDx	FIRE-SMOKE DAMPER, "X" DENOTES RATING 1=1.5HR, 3=3HR	<p>O. PROVIDE ALL CUTTING, PATCHING AND FIRE STOPPING REQUIRED TO ACCOMPLISH WORK SHOWN. PATCH AND SEAL OPENINGS TO MATCH ADJACENT EXISTING WALLS, FLOORS, CEILINGS, ETC. UNLESS OTHERWISE INDICATED. CONCEAL ALL WORK IN FINISHED AREAS UNLESS OTHERWISE INDICATED OR DIRECTED BY THE ARCHITECT AND ENGINEER OF RECORD.</p> <p>P. CONTRACTOR SHALL FIELD VERIFY ALL LOCATIONS, DIMENSIONS AND EXISTING CONDITIONS (PIPING, DUCTWORK, EQUIPMENT, STRUCTURAL ELEMENTS, ETC.) PRIOR TO STARTING WORK. CONTRACTOR SHALL COORDINATE INSTALLATION OF EQUIPMENT AND DUCTWORK WITH EXISTING CONDITIONS AND OTHER TRADES. PROVIDE FITTINGS, TRANSITIONS, OFFSETS, ELEVATION CHANGES, ETC. TO MINIMIZE CONFLICTS WITH EXISTING CONDITIONS.</p> <p>Q. CONTRACTOR SHALL COORDINATE CONNECTIONS TO ALL MECHANICAL EQUIPMENT, DUCTWORK, AIR OUTLET, AND ACCESSORY.</p> <p>R. DRAWINGS ARE SCHEMATIC, AND SERVE TO INDICATE THE TYPE AND LOCATION OF MAJOR PIECES OF EQUIPMENT. THIS CONTRACTOR SHALL PROVIDE AND INSTALL ALL MATERIALS, EQUIPMENT, AND LABOR NECESSARY FOR A COMPLETE INSTALLATION PER DESIGN INTENT. ADJUST THE LOCATION OF ALL DUCTWORK, WIRING, EQUIPMENT, AND CONNECTIONS TO ACCOMMODATE ACTUAL CONSTRUCTION CONDITIONS ENCOUNTERED; OBTAIN APPROVAL FROM THE ENGINEER FOR ALL CHANGES. IN ALL CASES EQUIPMENT AND DEVICES SHALL BE FULLY ACCESSIBLE AND MAINTAINABLE PER MANUFACTURER'S GUIDELINES & MAINTENANCE REQUIREMENTS.</p> <p>S. INSTALL ALL EQUIPMENT AND SYSTEMS IN COMPLETE COMPLIANCE WITH 2020 NYSBC, 2020 NYSMC, 2020 NYSECCC, MANUFACTURERS INSTALLATION INSTRUCTIONS, AND SPECIFICATIONS.</p> <p>T. ALL PHYSICAL ATTRIBUTES OF EQUIPMENT AND DEVICES ARE BASED ON THOSE MANUFACTURERS LISTED IN THE SPECIFICATIONS AND/OR THE EQUIPMENT SCHEDULES. THE RESPECTIVE CONTRACTORS ARE RESPONSIBLE FOR ALL CHANGES AND ASSOCIATED COSTS BROUGHT ABOUT BY THE USE OF ITEMS BY OTHER MANUFACTURERS. THE ARCHITECT/ENGINEER HAS RESERVED THE RIGHT TO REJECT ITEMS BY OTHER MANUFACTURERS FOR REASONS INCLUDING, BUT NOT LIMITED TO, THOSE ITEMS NOT MATCHING THE PHYSICAL ATTRIBUTES OF THE MANUFACTURERS LISTED.</p> <p>U. THE EXISTING MECHANICAL SYSTEMS, OR PORTIONS THEREOF, SHALL REMAIN IN SERVICE THROUGHOUT CONSTRUCTION. ALL SYSTEM INSTALLATIONS AND EXISTING SYSTEM DEMOLITION SHALL BE COORDINATED TO MINIMIZE SYSTEM DOWNTIME.</p> <p>V. PROVIDE ANY AND ALL NECESSARY TEMPORARY SERVICES TO ADEQUATELY CONDITION THE BUILDING DURING ALL PHASES OF CONSTRUCTION. SCHEDULE SYSTEMS SHUTDOWNS WITH OWNER, SYSTEM SHUTDOWNS SHALL NOT INTERFERE WITH BUILDING OPERATIONS.</p> <p>W. COORDINATE DUCT INSTALLATION WITH ELECTRICAL DEVICES. DO NOT INSTALL PIPING OR DUCTWORK IN PROHIBITED LOCATIONS SUCH AS ABOVE ELECTRICAL PANELS, WITHIN HIGH VOLTAGE ROOMS, ETC. COMPLY WITH NEC REQUIREMENTS.</p> <p>X. REFER TO ARCHITECTURAL REFLECTED CEILING PLAN DRAWINGS FOR DIFFUSER AND REGISTER LOCATIONS WITH RESPECT TO OTHER ELEMENTS.</p> <p>Y. CAP ALL EXISTING DUCT OPENINGS AIRTIGHT CREATED BY REMOVALS WORK. THIS APPLIES TO THOSE ITEMS NOT IDENTIFIED FOR REUSE.</p>	
EAT	ENTERING AIR TEMPERATURE	OS	OPEN-ENDED DUCT	MD	MOTORIZED AIR DAMPER, ELECTRIC OR PNEUMATIC		
EDB	ENTERING DRY BULB TEMPERATURE			VD	MANUAL VOLUME DAMPER		
EER	ENERGY EFFICIENCY RATIO	PH	PHASE	TAG CFM	SUPPLY, DIFFUSER/GRILLE/REGISTER IDENTIFICATION		
EF	EXHAUST FAN	PPM	PARTS PER MILLION	TAG CFM	RETURN/EXHAUST, GRILLE OR REGISTER IDENTIFICATION		
ERP	ELECTRIC RADIANT PANEL	PSI	POUNDS PER SQUARE INCH				
ERV	ENERGY RECOVERY VENTILATOR	QTY	QUANTITY				
ESP	EXTERNAL STATIC PRESSURE	RA	RETURN AIR				
ETR	EXISTING TO REMAIN	RTU	ROOF TOP UNIT				
EWB	ENTERING WET BULB TEMPERATURE	SA	SUPPLY AIR				
EWT	ENTERING WATER TEMPERATURE	SD	SMOKE DAMPER				
EX	EXISTING	SP	STATIC PRESSURE				
F	FAHRENHEIT	SS	STAINLESS STEEL				
FCU	FAN COIL UNIT						
FD	FIRE DAMPER	TA	TRANSFER AIR				
FLA	FULL LOAD AMPS	TC	TEMPERATURE CONTROL				
FPM	FEET PER MINUTE	TYP	TYPICAL				
FSD	FIRE/SMOKE DAMPER						
FT	FEET						
G	GAS	V	VOLT/VOLTAGE				
GA	GAUGE/GAGE (THICKNESS)	VAV	VARIABLE AIR VOLUME				
GAL	GALLONS	VD	VOLUME DAMPER				
GPM	GALLONS PER MINUTE	VFD	VARIABLE FREQUENCY DRIVE				
HP	HORSEPOWER	W	WATTS				
		WB	WET BULB				
HVAC REFERENCE SYMBOLS							
				⊙	CONNECT NEW TO EXISTING		
				⊠	TERMINATION POINT OF DEMOLITION		
				#	KEYED NOTE - EXISTING TO REMAIN		
				⬢	KEYED NOTE - NEW CONSTRUCTION		
				#	KEYED NOTE - DEMOLITION/REMOVAL		
				⚠	KEYED NOTE - REVISION		
				SP	DUCT MOUNTED STATIC PRESSURE SENSOR INTERFACED WITH SUPPLY FAN'S VFD		
				CO2	WALL MOUNTED CARBON DIOXIDE SENSOR FOR DCV		
				T	REMOTE THERMOSTAT/TEMPERATURE SENSOR		

ALTERED ON:

AFFIXED ON:
07/30/2025

SIGNATURE:
STAMP:

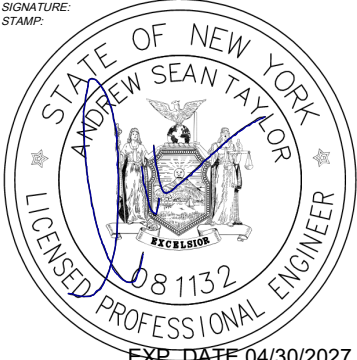



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REVISIONS			
DATE	DESCRIPTION	BY	SYM.



TITLE OF PROJECT ADDITIONS TO MAINTENANCE SECTION	CONTRACT NUMBER: TAS 25-9A
LOCATION OF PROJECT MANCHESTER MP 340.15	DATE: 07/30/2025
TITLE OF DRAWING MECHANICAL SYMBOLS & ABBREVIATIONS	DRAWING NUMBER: MG100

HEATING VENTILATING AND AIR CONDITIONING UNIT [1/2]

TAG	MANUFACTURER	MODEL	REFRIGERANT	EER	SUPPLY FAN								EXHAUST FAN						
					TOTAL (CFM)	DESIGNED MIN./MAX. O.A. (CFM)	ESP (in wg)	TSP (in wg)	DRIVE TYPE	FAN QTY.	HP (ea)	FAN RPM	TOTAL (CFM)	ESP (in wg)	TSP (in wg)	DRIVE TYPE	FAN QTY.	HP (ea)	FAN RPM
HVAC-1	AAON	RN-007-3-0-GAAY-V0-21-000-A	R-454B	12.6	2300	520 / 720	1.25	2.12	VFD	1	2.0	1465	2300	0.25	0.67	VFD	1	1.0	1416

HEATING VENTILATING AND AIR CONDITIONING UNIT [2/2]

HEAT PUMP COOLING							ENERGY RECOVERY WHEEL								NATURAL GAS HEATING						ELECTRICAL						WEIGHT (LBS.)	NOTES
TOTAL CAPACITY (MBH)	SENSIBLE CAPACITY (MBH)	ROWS	EAT (db/wb)	UNIT LAT (db/wb)	% RH	COMPRESSORS (QTY), TYPE	WINTER			SUMMER					MIN. PRESSURE	MAX. PRESSURE	INPUT CAPACITY (MBH)	OUTPUT CAPACITY (MBH)	EAT (db/wb)	LAT (db/wb)	VOLTS	PH	HZ	FLA	MCA	MOCP		
							EAT DB	LAT DB	TOTAL EFF. (%)	EAT DB	EAT WB	LAT DB	LAT WB	TOTAL EFF. (%)														
70.0	53.4	2	75.7/62.8	55.6/52.5	41.7	1, VARIABLE CAPACITY SCROLL	0.0	56.9	80.7	89.0	73.0	77.3	64.4	78.8	6" W.C.	10.5" W.C.	90.0	51.5	65.9/52.6	75.0/60.1	208	3	60	39	45	60	1550	1-8

- NOTES:
1. PROVIDE A UNIT CURB FOR THE HORIZONTAL SUPPLY AND RETURN DUCTWORK CONNECTIONS. THE UNIT CURB/PLENUM SHALL BE BY MGM PRODUCTS, INC. "AAON RN A W/EWR, 22" TALL PLENUM FRC W/ PAD MOUNT" - 16 GAUGE G90 CONSTRUCTION, 1" FOIL FACED RIGID INSULATION, GASKETING, 1X4 WOOD NAILER, MECHANICAL CONTRACTOR TO IDENTIFY THE EXACT LOCATION ON THE SIDE OF THE CURB AND CUT THE CURB/PLENUM FOR DUCTWORK CONNECTIONS.
 2. PROVIDE MERV-8 PRE-FILTERS AND MERV-13 FINAL FILTERS.
 3. PROVIDE A CLOGGED FILTER SWITCH, STANDARD WARRANTY, 5-YEAR COMPRESSORS WARRANTY.
 4. PROVIDE FACTORY INSTALLED VFD PER FAN/MOTOR. MOTORS SHALL BE HIGH EFFICIENCY OPEN MOTORS.
 5. PROVIDE AIRSIDE ECONOMIZER, ENERGY RECOVERY, BYPASS DAMPER, BAROMETRIC RELIEF EXHAUST AIR DAMPER, FULLY MODULATING ACTUATOR FOR OUTSIDE AIR CONTROL-ENTHALPY LIMIT, POLYMER ENERGY RECOVERY WHEEL, LOW CFM ENTHALPY.
 6. PROVIDE SUPPLY DAN WITH DIRECT DRIVE BACKWARD CURVED ALUMINUM AND EXHAUST FAN WITH BACKWARD CURVED ALUMINUM.
 7. PROVIDE MODULATING HOT GAS REHEAT MICROCHANNEL COIL, SINGLE POINT POWER-NON-FUSED DISCONNECT POWER SWITCH, REMOTE SAFETY SHUTDOWN TERMINALS, PHASE & BROWN OUT PROTECTION, VAV UNIT CONTROLLER, AAON CONTROLS, BACNET IP, OUTSIDE AIR HOOD, BASE INSULATION, FACTORY WIRED 115 V CONVENIENCE OUTLET, ETL USA LISTING,ECM CONDENSER FAN HEAD PRESSURE CONTROL, ENERGY RECOVERY WHEEL DEFROST - START/STOP, SCCR (10KA), GALVANIZED CABINET - DOUBLE WALL, + R-13 FOAM INSULATION, AND PREMIUM AAON GRAY EXTERIOR PAINT.
 8. PROVIDE A NATURAL GAS FURNACE WITH A TOTAL TURNDOWN RATIO OF 10.0:1 AND 81% EFFICIENCY. THE GAS FURNACE SHALL HAVE STAINLESS STEEL HEAT EXCHANGER.

VAV SCHEDULE

TAG	LOCATION	SERVICE	MANUFACTURER	MODEL	SIZE		CFM		STATIC PRESSURE			NC LEVEL		ELECTRIC HEAT COIL						ELECTRICAL		UNIT INFORMATION	NOTES
					UNIT	OUTLET	MAX	MIN	INLET	DOWN	MIN	RAD.	DISTCH.	CFM	KW	VOLTS/PH/HZ	STEPS	EAT	LAT	MCA	MOP	HAND	
VAV-01	BREAK ROOM - 05	MEN'S LOCKER - 03	TITUS	DESV	06	12X8	330	85	1	0.25	0.09	22	23	330	1.5	208/1/60	S	75	89.4	9.0	15	PER APPROVED SUBMITTAL	1-7
VAV-02	BREAK ROOM - 05	WOMAN'S LOCKER - 04	TITUS	DESV	04	12X8	160	40	1	0.25	0.05	23	32	160	1	208/1/60	S	75	94.8	6.0	15	PER APPROVED SUBMITTAL	1-7
VAV-03	BREAK ROOM - 05	(E) OFFICE - 02	TITUS	DESV	04	12X8	135	35	1	0.25	0.04	20	31	135	1	208/1/60	S	75	98.4	6.0	15	PER APPROVED SUBMITTAL	1-7
VAV-04	BREAK ROOM - 05	BREAK ROOM - 05	TITUS	DESV	12	16X15	1260	315	1	0.25	0.11	23	24	1260	6	208/1/60	S	75	90.0	36.1	40	PER APPROVED SUBMITTAL	1-7
VAV-05	BREAK ROOM - 05	MECH. RM - 06, CORRIDOR - 01	TITUS	DESV	06	12X8	245	65	1	0.25	0.05	17	23	245	1.5	208/1/60	S	75	94.3	9.0	15	PER APPROVED SUBMITTAL	1-7
VAV-06	BREAK ROOM - 05	(E) OFFICE - 02A	TITUS	DESV	06	12X8	260	70	1	0.25	0.06	18	24	265	1.5	208/1/60	S	75	92.9	9.0	15	PER APPROVED SUBMITTAL	1-7

- NOTES:
1. ALL VAV UNITS TO BE ASSOCIATED WITH HVAC-1
 2. MECHANICAL CONTRACTOR SHALL PROVIDE ACOUSTICAL DUCT INSULATION FOR A MINIMUM OF 10 FT DOWNSTREAM OF EACH VAV OUTLET.
 3. ALL CONTROL WIRING, RELAYS, MISCELLANEOUS CONTROL DEVICES SHALL BE PROVIDED BY THE MECHANICAL CONTRACTOR.
 4. ALL VAV BOXES SHALL BE PRESSURE INDEPENDENT WITH DDC CONTROLS, 24V CONTROLS TRANSFORMER, SCR CONTROLLED ELECTRIC HEATER, 1/2" FIBERGLASS LINING, EXTENDED HOUSING, RJ-45 THERMOSTAT CABLES. DISCONNECT SWITCH, DOOR INTERLOCK TYPE, REMOVABLE CROSS FLOW AIR FLOW SENSOR, AUTOMATIC RESET THERMAL CUTOUTS, POSITIVE PRESSURE FLOW SWITCH, DUST TIGHT CONSTRUCTION AND HANGING BRACKETS.
 5. CONTROLLER FURNISHED BY CONTROLS CONTRACTOR/MECHANICAL CONTRACTOR.
 6. PROVIDE A REMOTE PROGRAMMABLE THERMOSTAT ON THE WALL FOR EACH VAV BOX. THE CENTERLINE OF THE THERMOSTAT FOR THE TEMPERATURE ADJUSTMENT BUTTON/SCREEN SHALL BE AT 4'-0" ABOVE FINISHED FLOOR. COLOR SHALL BE WHITE OR PER ARCHITECT'S APPROVED CUSTOM COLOR/DESIGN.
 7. PROVIDE A REMOTE PROGRAMMABLE THERMOSTAT/ROOM SENSOR SHALL BE BY TITUS ALPHA BACNET CONTROLLER MODEL #BAC-8205 OR APPROVED EQUAL, POWERED BY CONNECTED CONTROLLER, COLOR SHALL BE WHITE OR PER ARCHITECT'S APPROVED CUSTOM COLOR/DESIGN. PROVIDE MOUNTING HARDWARE.

DIFFUSER & GRILLE SCHEDULE

TAG	APPLICATION	MATERIAL	COLOR	FEATURES	NECK SIZE	CFM RANGE	MAX NC	BASIS OF DESIGN	NOTES
SD-1	SUPPLY AIR DIFFUSER	ALUMINUM	WHITE	24"X24", SQUARE CEILING, PLAQUE FACE	8"	0-265	25	PRICE SCDA	1-5
RG-1	EXHAUST/RETURN GRILLE	ALUMINUM	WHITE	LOUVERED FACE, SURFACE MOUNT 45° DEFLECTION AT 1/2" SPACING, 12"x12" MIN.	DUCT SIZE	0-450	25	PRICE 635	1-5
RG-2	EXHAUST/RETURN GRILLE	ALUMINUM	WHITE	LOUVERED FACE, SURFACE MOUNT 45° DEFLECTION AT 1/2" SPACING, 24"x24" MIN.	DUCT SIZE	451-650	25	PRICE 635	1-5

- NOTES:
1. 25 NC SHALL BE THE NOISE CRITERIA CURVE NOT TO BE EXCEEDED. ADJUSTMENT OF SELECTION MAY BE NECESSARY BASED ON MANUFACTURER.
 2. PROVIDE A MANUAL VOLUME DAMPER (VD), OPPOSED BLADE DAMPER TYPE IN THE DUCTWORK FOR EACH SD-1, RG-1, AND RG-2.
 3. REFER TO DIFFUSER/GRILLE TAG IN PLAN FOR NECK SIZE, CFM, ETC.
 4. COLOR/FINISH AS SELECTED BY ARCHITECT.
 5. REFER TO ARCHITECTURAL REFLECTED CEILING PLAN DRAWINGS FOR DIFFUSER AND GRILLE LOCATIONS WITH RESPECT TO OTHER ELEMENTS.

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REVISIONS

DATE	DESCRIPTION	BY	SYM.



Thruway Authority

TITLE OF PROJECT
ADDITIONS TO MAINTENANCE SECTION

LOCATION OF PROJECT
MANCHESTER
MP 340.15


TITLE OF DRAWING
MECHANICAL EQUIPMENT
SCHEDULES SHEET

CONTRACT NUMBER:
TAS 25-9A

DATE:
07/30/2025

DRAWING NUMBER:
MG801

CHECKED BY: SRZ
DRAFTED BY: RPM
CHECKED BY:
DESIGNED BY: J.L. MORRIS
BUREAU DIRECTOR:

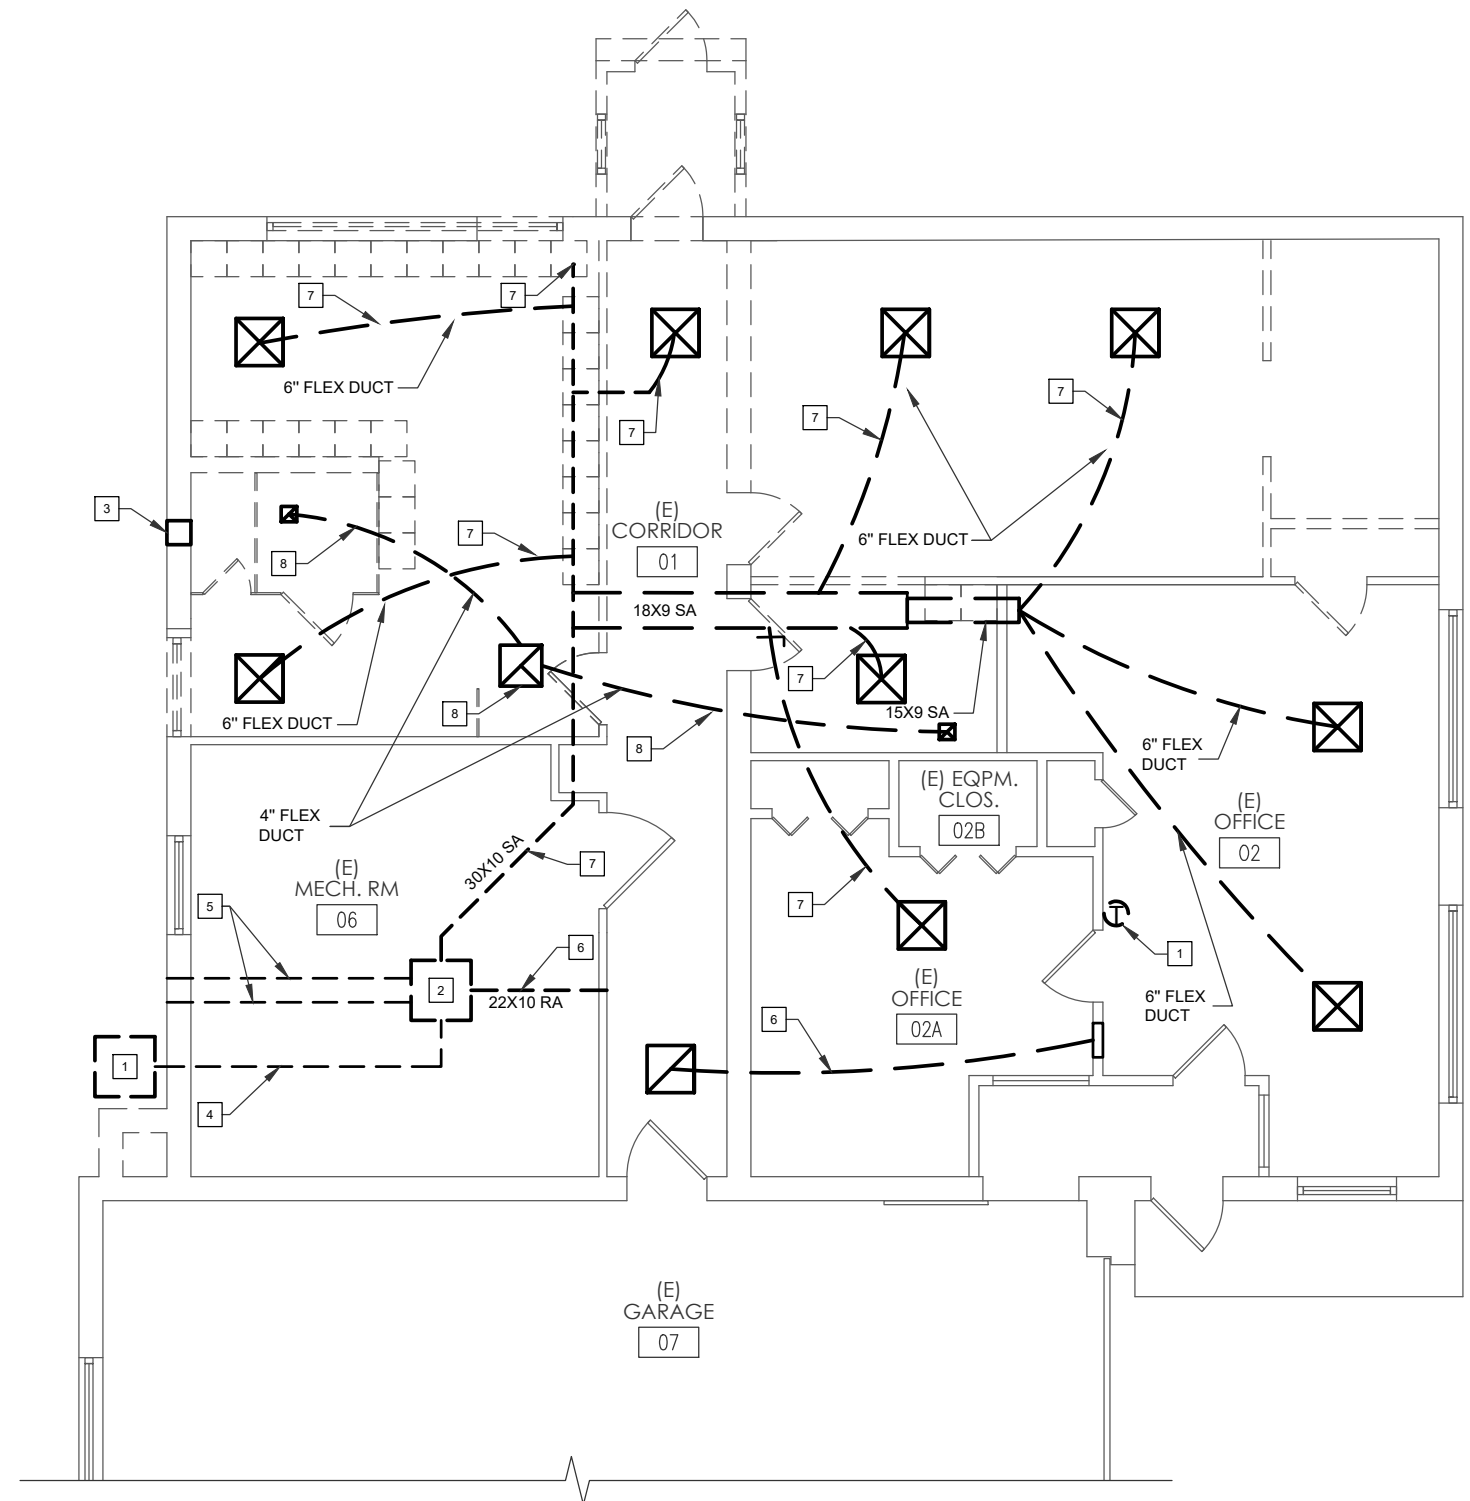

- # MECHANICAL DEMOLITION NOTES:
1. REMOVE EXISTING CONDENSING UNIT, DISCONNECT, MOUNTING PAD, THERMOSTAT, CONTROL WIRING, AND ACCESSORIES.
 2. REMOVE EXISTING FURNACE, SUPPLY DUCTWORK, ASSOCIATED HANGERS, BRACKETS & INSULATION, AND ACCESSORIES.
 3. REMOVE WALL-MOUNTED EXHAUST FAN.
 4. REMOVE REFRIGERANT LIQUID & SUCTION PIPING AND ASSOCIATED HANGERS, BRACKETS & INSULATION VENT/DUCT.
 5. REMOVE FURNACE VENT INTAKE AND EXHAUST PIPING TO EXTENTS SHOWN.
 6. REMOVE RETURN AIR DUCTWORK AND ASSOCIATED FITTINGS, HANGERS & ACCESSORIES.
 7. REMOVE SUPPLY AIR DUCTWORK, FLEX DUCT, SUPPLY CEILING DIFFUSER (CD), ASSOCIATED FITTINGS, HANGERS & ACCESSORIES.
 8. REMOVE EXHAUST AIR DUCTWORK AND ASSOCIATED FITTINGS, HANGERS & ACCESSORIES.

1 FIRST FLOOR MECHANICAL DEMOLITION PLAN
SCALE: 1/8"=1'-0"

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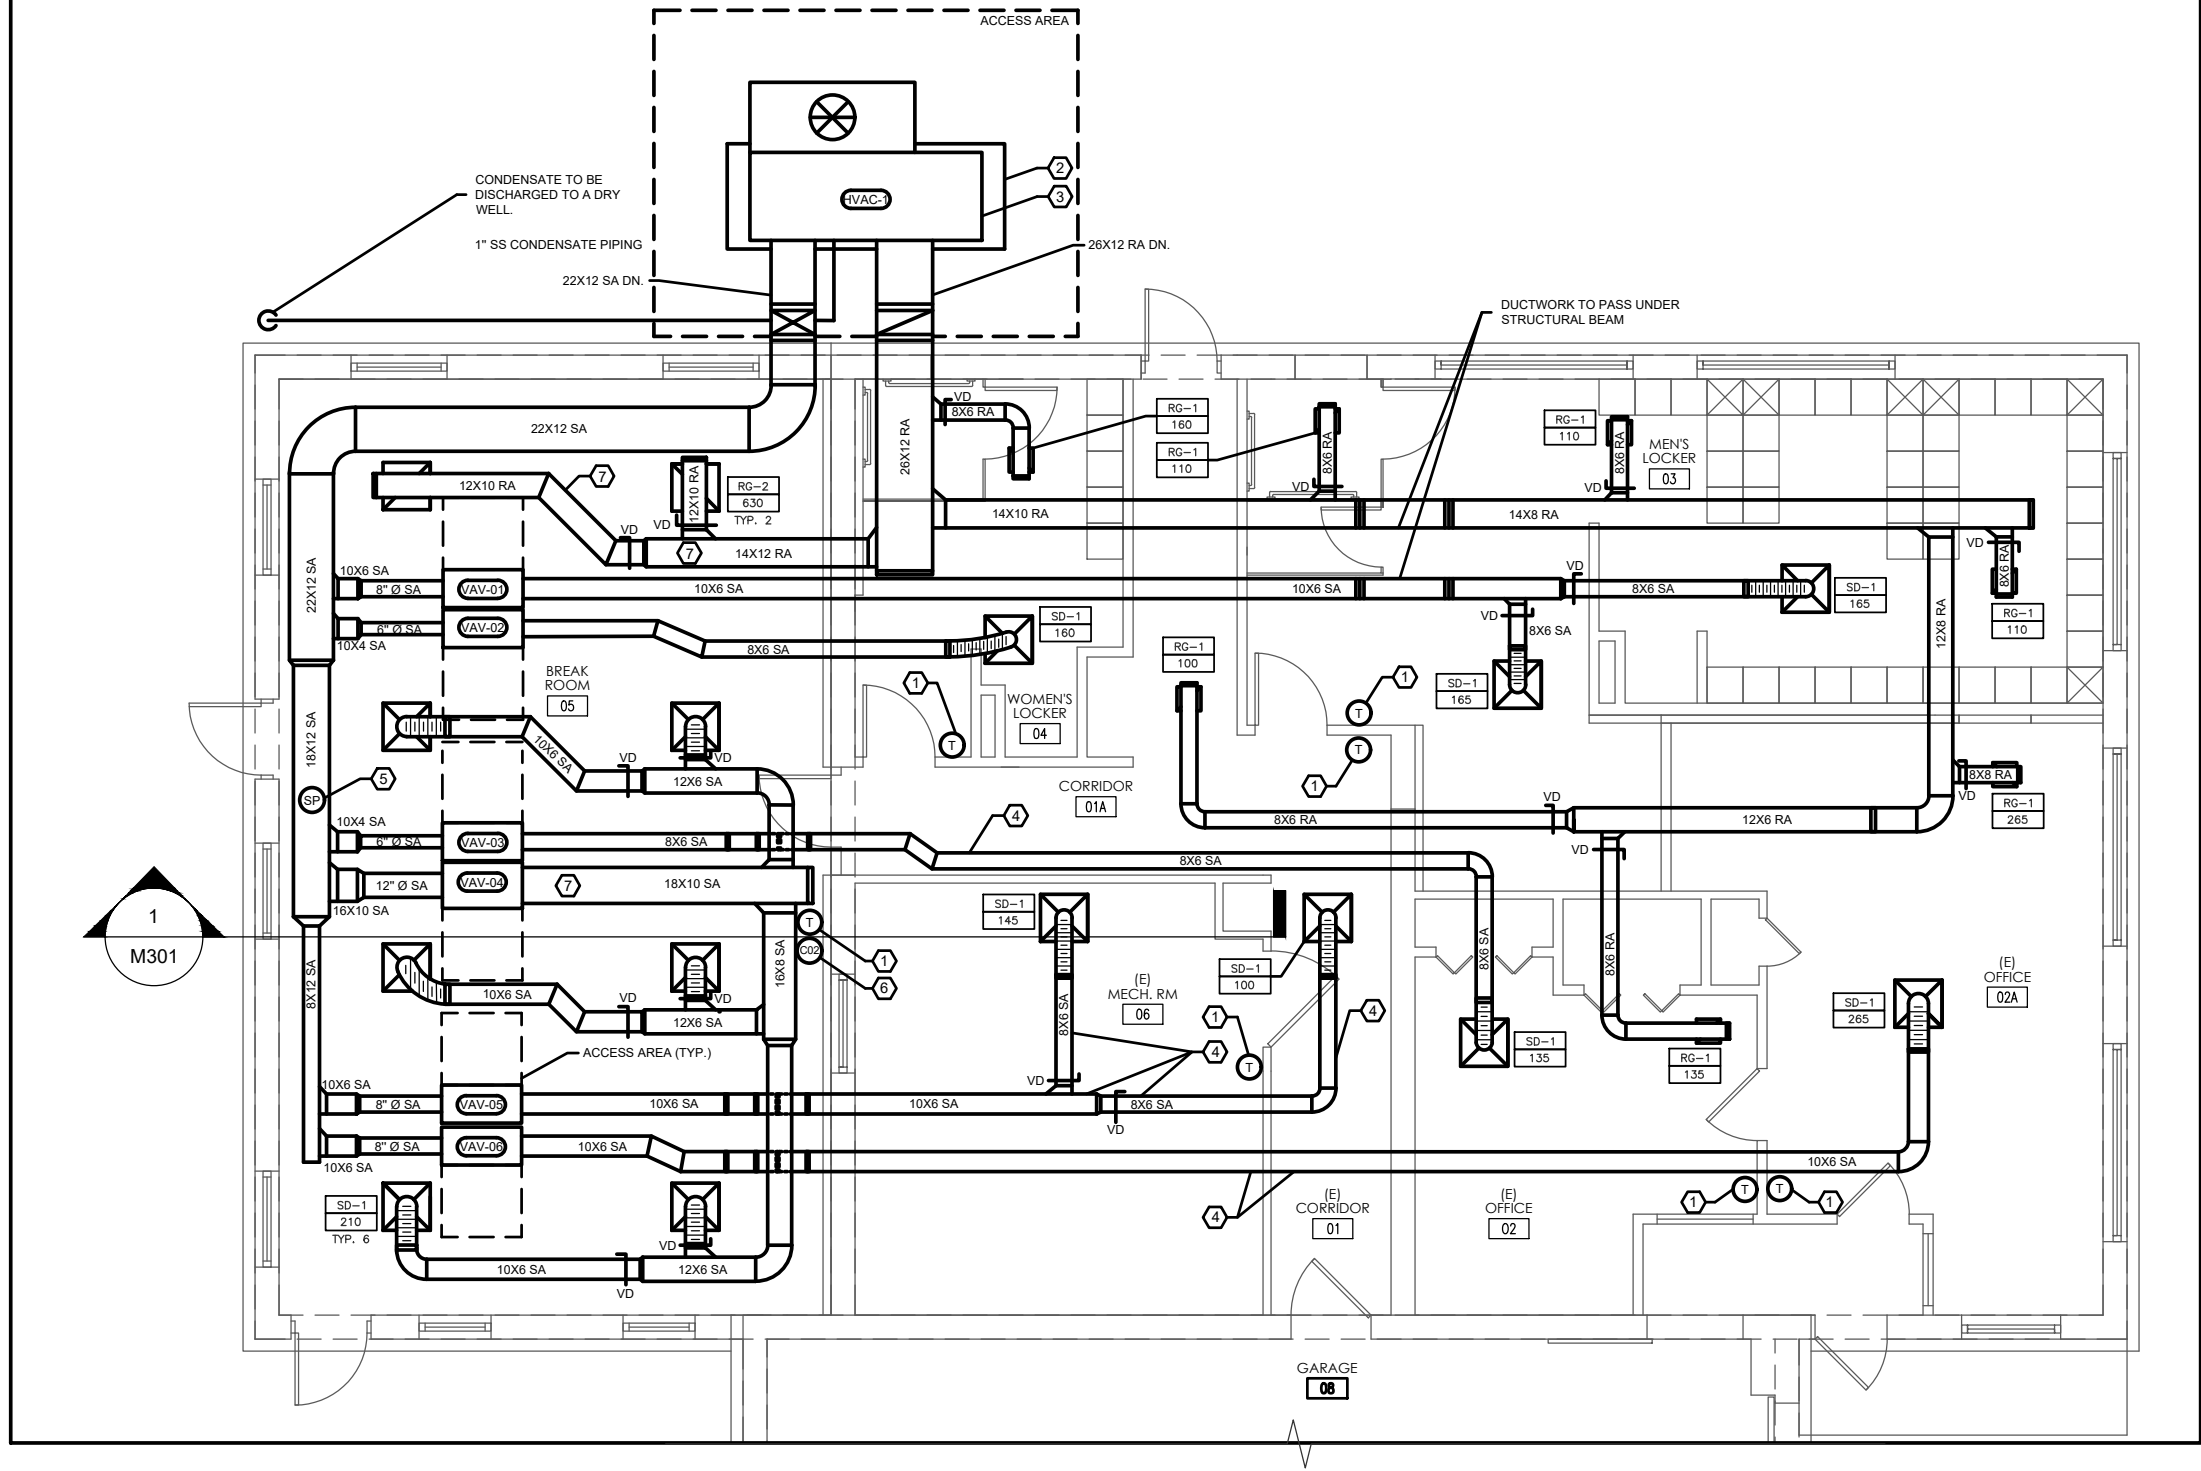
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DATE	DESCRIPTION	BY	SYM.



TITLE OF PROJECT ADDITIONS TO MAINTENANCE SECTION	CONTRACT NUMBER: TAS 25-9A
LOCATION OF PROJECT MANCHESTER MP 340.15	DATE: 07/30/2025
TITLE OF DRAWING FIRST FLOOR MECHANICAL DEMOLITION PLAN	DRAWING NUMBER: MD101



KEYED MECHANICAL NEW SCOPE OF WORK NOTES:

1. 7-DAY PROGRAMMABLE THERMOSTAT, WALL MOUNTED.
2. REINFORCED CONCRETE EQUIPMENT PAD. COORDINATE WITH ARCH. & STRUCTURAL DRAWINGS FOR EXACT LOCATION.
3. 22" EQUIPMENT CURB, PROVIDED BY MANUFACTURER
4. PROVIDE A MIN. 1" INTERNAL ACOUSTICAL LINING FOR SUPPLY DUCTWORK PASSING THROUGH MECH. RM. AND CORRIDOR. THE REMAINING SUPPLY DUCTWORK SHALL HAVE EXTERNAL 1 1/2" THICK INSULATION PER 2020 NYSECCC.
5. PROVIDE A DUCT MOUNTED STATIC PRESSURE (SP) SENSOR 2/3 DOWNSTREAM FROM THE HVAC-1'S SA OUTLET. THE SP SHALL BE INTERFACED WITH SUPPLY FAN'S VFD AND SET INITIALLY AT 1.0" (ADJ.). AIR TESTING AND BALANCING CONTRACTOR SHALL MAKE THE FINAL CFM ADJUSTMENT AND STATIC PRESSURE SETTING.
6. PROVIDE A WALL MOUNTED CARBON DIOXIDE (CO2) SENSOR AND SET THE ALARM AT 700 PPM (ADJ.). THE CO2 SENSOR SHALL BE INTERFACED WITH OA'S DAMPER. UPON THE ACTIVATION OF THE ALARM, THE OA DAMPER POSITION SHALL BE AT THE MAXIMUM DESIGN POSITION (720 CFM).
7. PROVIDE 1" INTERNAL ACOUSTICAL LINING FOR ALL SUPPLY DUCTWORK ASSOCIATED WITH VAV-04 AND RETURN AIR DUCTWORK SERVING THE BREAK ROOM.

GENERAL MECHANICAL NOTES:

- A. PROVIDE DUCT INSULATION AND JACKET FOR EXTERIOR INSTALLATION PER 2020 NYSECCC AND SPECIFICATION.
- B. PROVIDE OFFSETS IN DUCTWORK AS REQUIRED BY FIELD CONDITIONS
- C. PROVIDE TURNING VANES FOR RECTANGULAR & SQUARE DUCTWORK PER SMACNA STANDARDS.
- D. PROVIDE CONNECTION TO THE CEILING DIFFUSERS AND CEILING GRILLES TO SUPPLY AIR DUCTWORK WITH 3'-0" OR LESS INSULATED FLEXIBLE DUCT (UL-181 & UL-181B) PER SMACNA STANDARDS.

1 FIRST FLOOR MECHANICAL PLAN
SCALE: 1/8"=1'-0"

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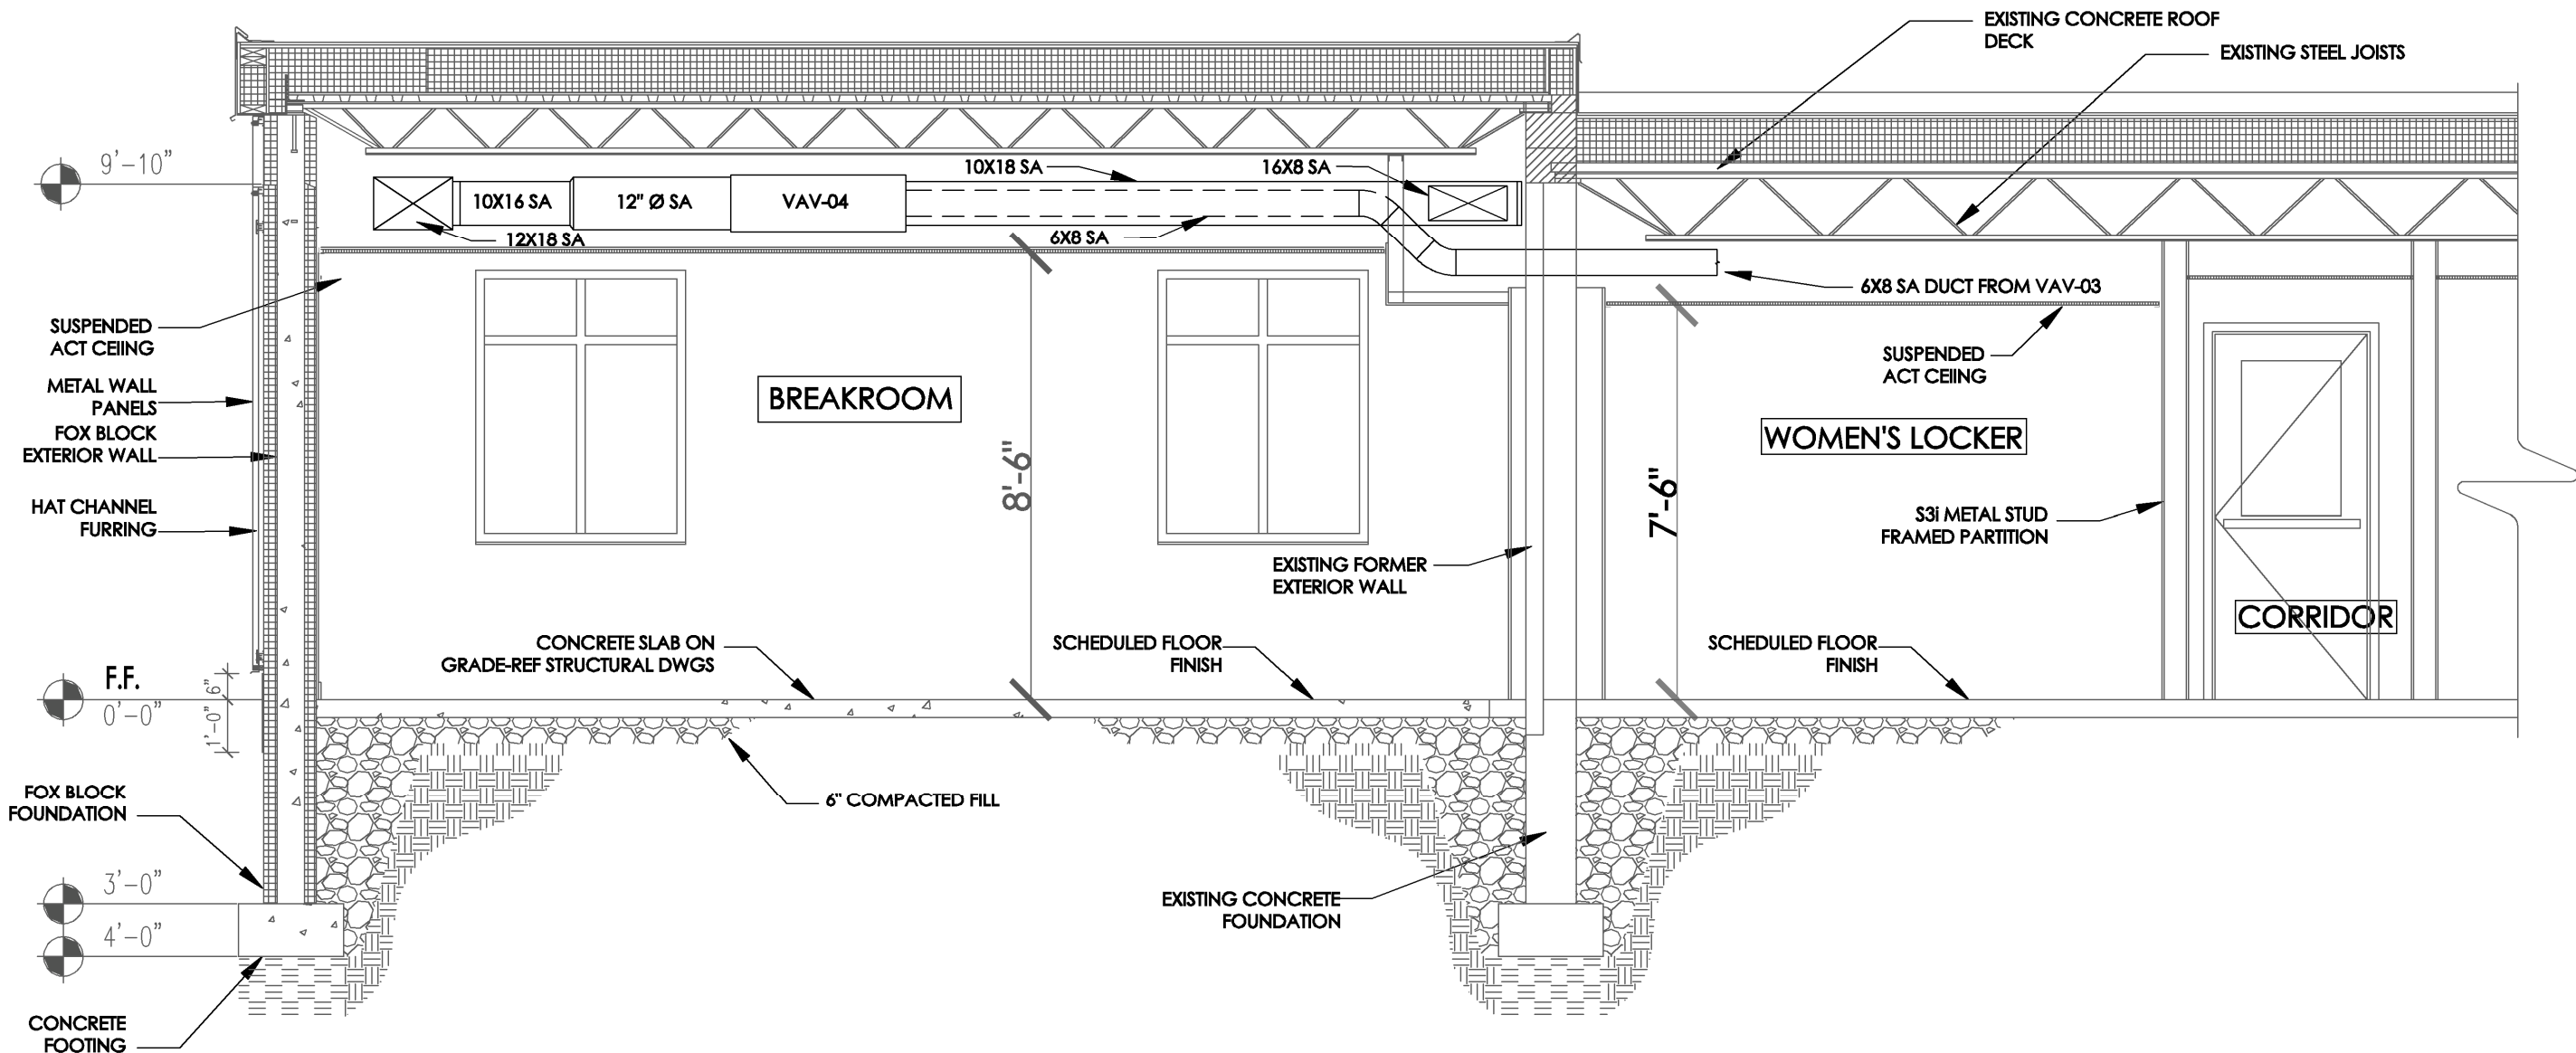
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LOCATION OF PROJECT MANCHESTER MP 340.15	DATE: 07/30/2025
TITLE OF DRAWING FIRST FLOOR NEW MECHANICAL PLAN	DRAWING NUMBER: M101



1 MECHANICAL SECTION VIEW
SCALE: 1/8" = 1'-0"

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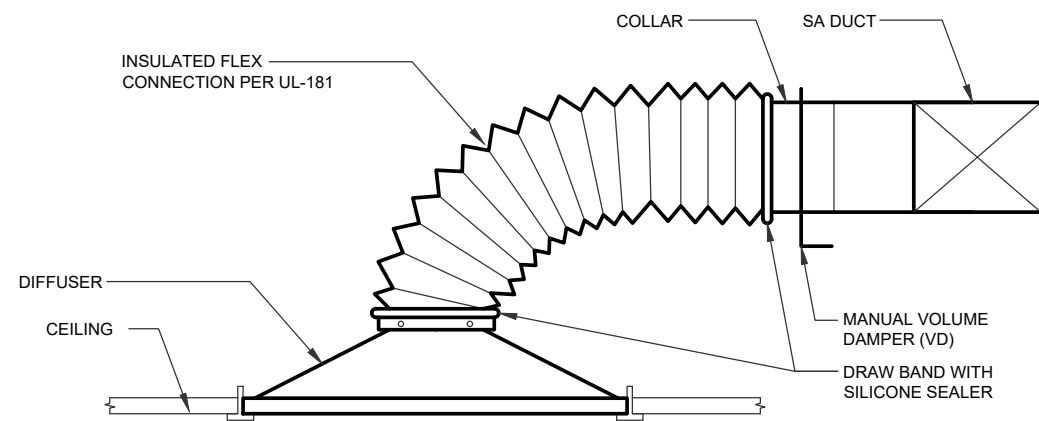
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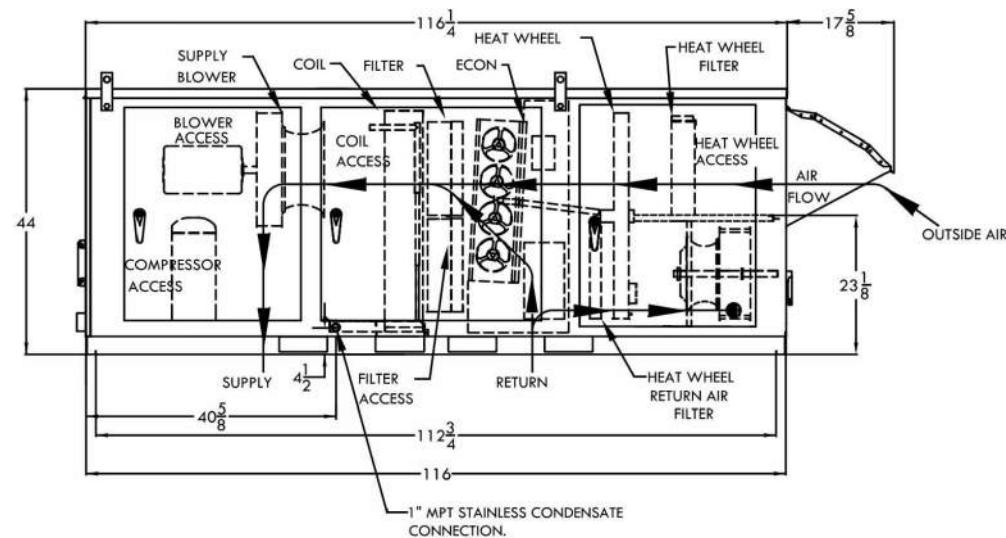
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TITLE OF PROJECT ADDITIONS TO MAINTAINACE SECTION	CONTRACT NUMBER: TAS 25-9A
LOCATION OF PROJECT MANCHESTER MP 340.15	DATE: 07/30/2025
TITLE OF DRAWING MECHANICAL SECTIONS SHEET	DRAWING NUMBER: M301




1 TYPICAL DIFFUSER CONNECTION DETAIL
NTS




- NOTES:
1. PROVIDE 22" HIGH CURB FOR THE HVAC UNIT.

3 HVAC-1 ARRANGEMENT DETAIL
NTS

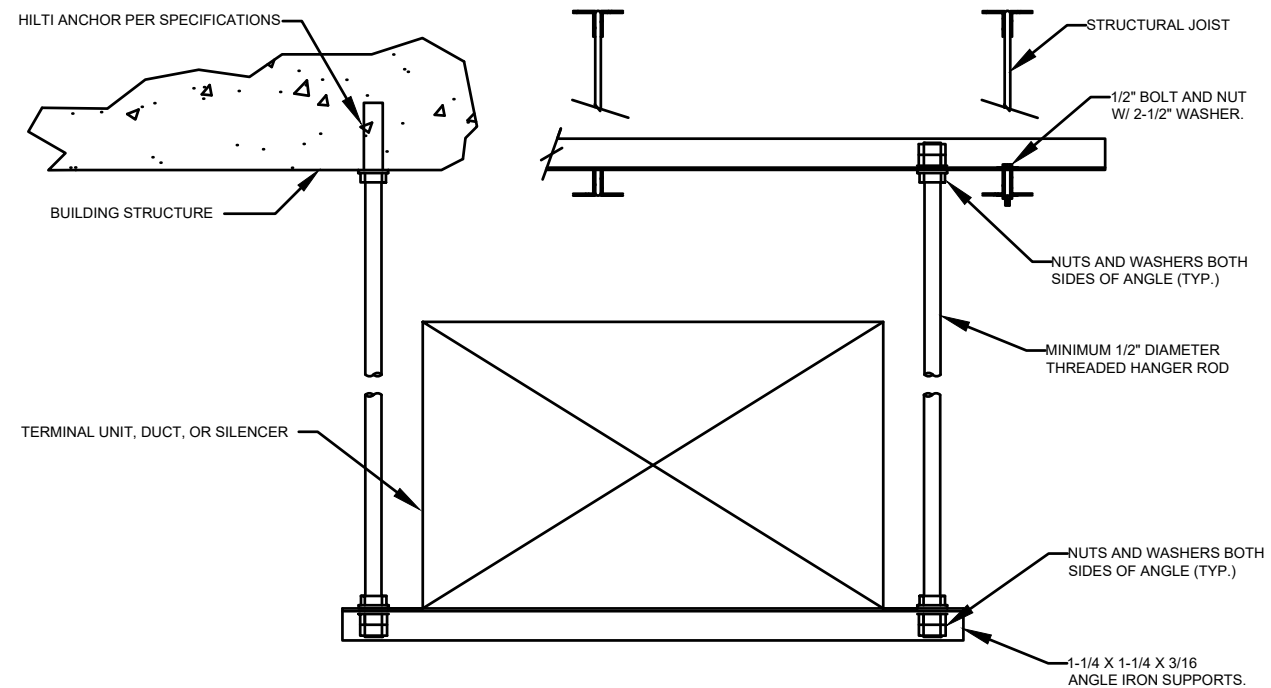

2 DUCT AND TERMINAL UNIT HANGER DETAIL
NTS

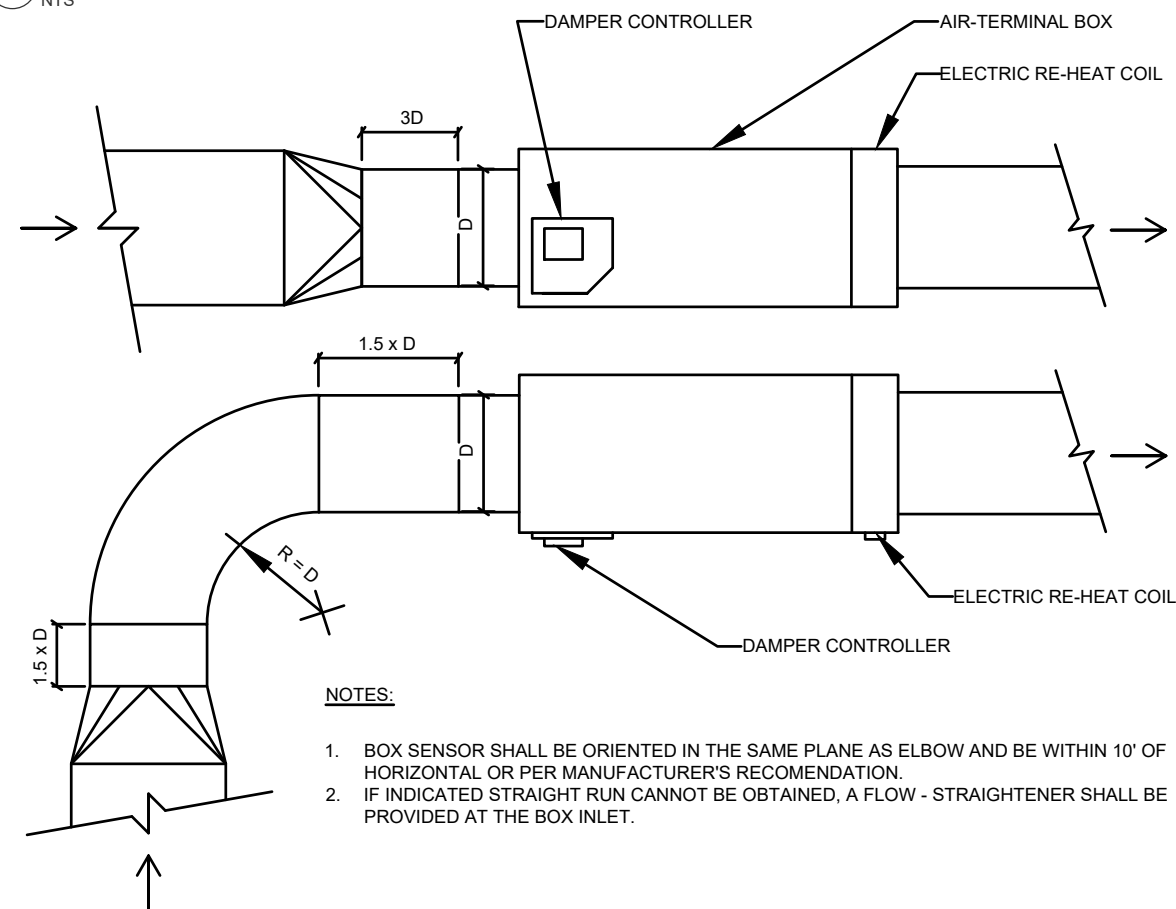

- NOTES:
1. BOX SENSOR SHALL BE ORIENTED IN THE SAME PLANE AS ELBOW AND BE WITHIN 10' OF HORIZONTAL OR PER MANUFACTURER'S RECOMMENDATION.
 2. IF INDICATED STRAIGHT RUN CANNOT BE OBTAINED, A FLOW - STRAIGHTENER SHALL BE PROVIDED AT THE BOX INLET.

4 NTS

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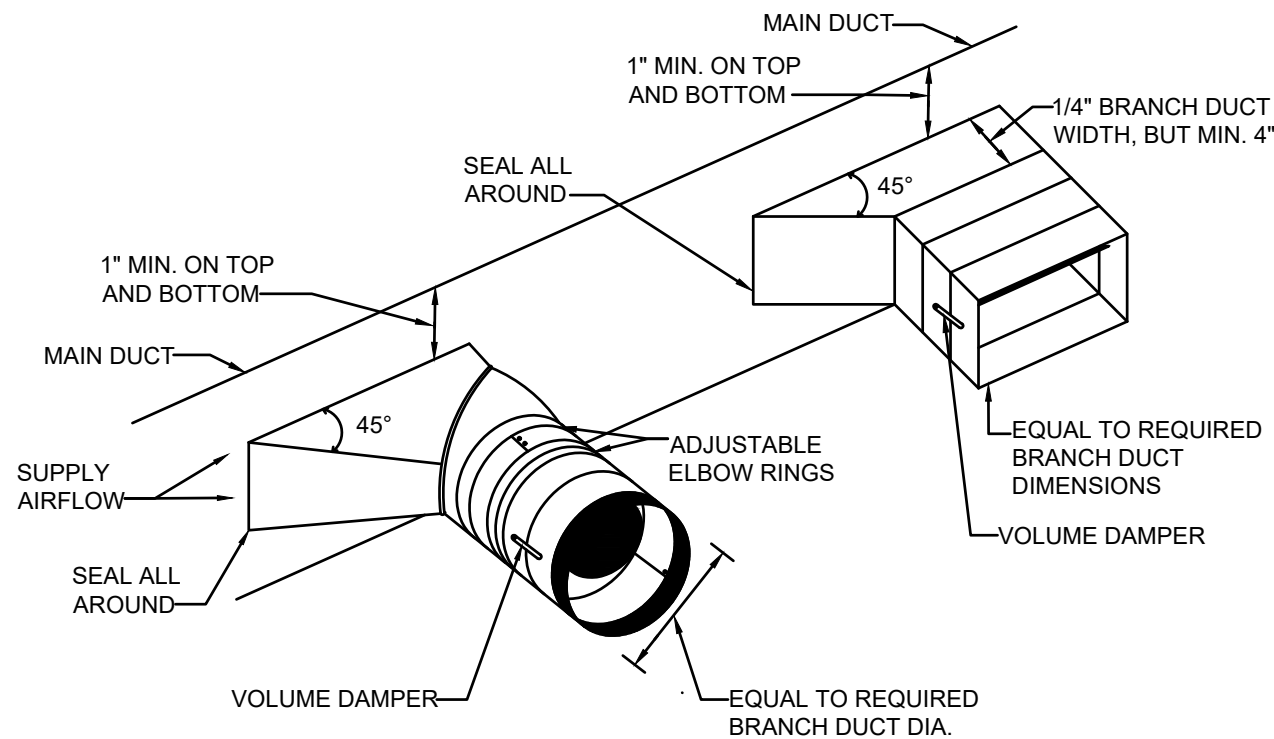
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LOCATION OF PROJECT MANCHESTER MP 340.15	DATE: 07/30/2025
TITLE OF DRAWING MECHANICAL DETAILS SHEET #1	DRAWING NUMBER: M501



- NOTES:
- 1. PROVIDE VOLUME DAMPER AT EACH BRANCH TAKE OFF LOCATION.
 - 2. REFER TO FLOOR PLANS FOR DUCT SIZES

1 TYPICAL BRANCH TAKEOFF FITTING DETAIL
NTS

CHECKED BY: SRZ
DRAFTED BY: RPM
CHECKED BY:
DESIGNED BY: J.L. MORRIS
BUREAU DIRECTOR:

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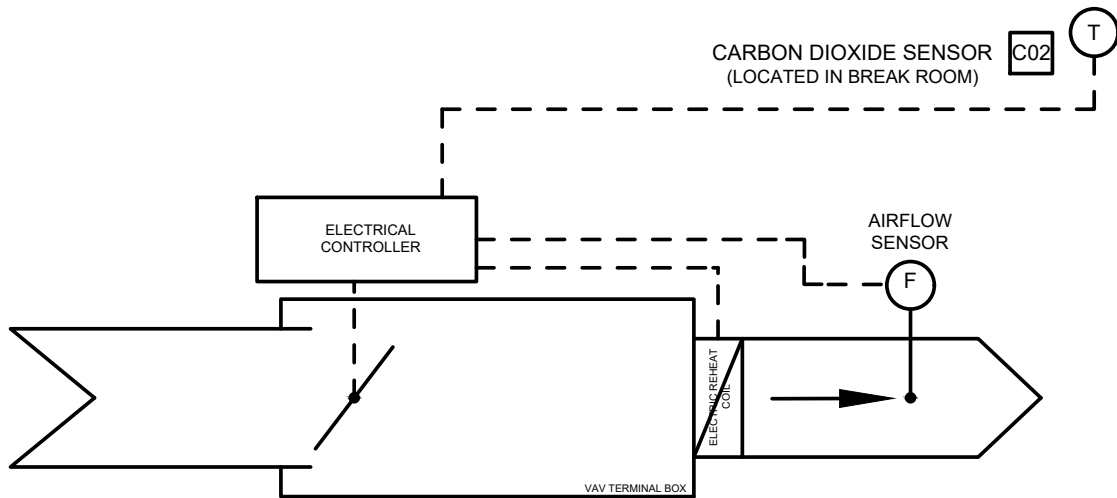
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TITLE OF PROJECT ADDITIONS TO MAINTAINACE SECTION	CONTRACT NUMBER: TAS 25-9A
LOCATION OF PROJECT MANCHESTER MP 340.15	DATE: 07/30/2025
TITLE OF DRAWING MECHANICAL DETAILS SHEET #2	DRAWING NUMBER: M502



VARIABLE AIR VOLUME (VAV) BOXES WITH ELECTRIC REHEAT (TYPICAL)

FOR COOLING MODE:

- A. UPON THE REMOTE THERMOSTAT CALLS FOR COOLING BASED ON THE SPACE/ROOM TEMPERATURE SETTING OF 75 DEG. F (ADJUSTABLE), THE VAV BOX SHALL BE ACTIVATED/OPENED TO A MAXIMUM POSITION. THE VAV BOX SHALL REMAIN OPEN TO THE DESIGNED CFM UNTIL THE SPACE/ROOM TEMPERATURE IS SATISFIED. AFTER THE SPACE TEMPERATURE SETPOINT HAS BEEN SATISFIED, THE VAV BOX SHALL BE IN A MINIMUM POSITION.

FOR HEATING MODE:

- A. UPON THE REMOTE THERMOSTAT CALLS FOR HEAT BASED ON THE SPACE/ROOM TEMPERATURE SETTING OF 70 DEG. F (ADJUSTABLE), THE ELECTRIC HEATING COIL SHALL BE ENERGIZED AND THE VAV BOX SHALL BE ACTIVATED/OPENED TO A MINIMUM POSITION. THE ELECTRIC HEATING COIL SHALL REMAIN ON UNTIL THE SPACE/ROOM TEMPERATURE IS SATISFIED. AFTER THE SPACE TEMPERATURE SETPOINT HAS BEEN SATISFIED, THE VAV BOX SHALL BE IN A DESIGNED CFM POSITION.

SEQUENCE OF OPERATIONS FOR THE HVAC-1'S OUTSIDE AIR (OA) DAMPER POSITION AND CO2 SENSOR

FOR BOTH COOLING AND HEATING MODES:

- A. UPON THE RISE OF THE CO2 LEVEL IN THE BREAK ROOM ABOVE 700 PPM (ADJ.), THE OA DAMPER POSITION SHALL BE SET TO THE MAXIMUM CFM POSITION AT 720 CFM
- B. AFTER THE CO2 LEVEL IN THE BREAK ROOM FALLS BELOW 700 PPM (ADJ.), THE OA DAMPER POSITION SHALL BE SET TO THE MINIMUM CFM POSITION AT 520 CFM.

SAFETIES:

- 1. THE ELECTRIC HEATING COIL SHALL NOT BE ENERGIZED OR SHUT OFF IF THERE IS LOW AIR FLOW OR NO AIR FLOW.

1 VARIABLE AIR VOLUME BOX WITH ELECTRIC RE-HEAT TERMINAL UNIT - TYPICAL
NTS

CHECKED BY: SRZ
DRAFTED BY: RPM
DESIGNED BY: J.L. MORRIS
BUREAU DIRECTOR:

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AFFIXED ON:
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STATE OF NEW YORK
ANDREW SEAN TAYLOR
LICENSED PROFESSIONAL ENGINEER
081132
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LOCATION OF PROJECT MANCHESTER MP 340.15	DATE: 07/30/2025
TITLE OF DRAWING MECHANICAL CONTROLS DETAILS	DRAWING NUMBER: M503

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MPC
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MPC
DESIGNED BY:
J.L. MORRIS
BUREAU DIRECTOR:

PLUMBING GENERAL NOTES:

- A. PROVIDE FOR THE PROPER FIELD FITTING OF WORK. PROVIDE FOR ANY FIELD MEASUREMENTS AS REQUIRED. CONTRACTOR SHALL BE RESPONSIBLE FOR FITTING THE NEW CONSTRUCTION AROUND EXISTING CONDITIONS. PROVIDE FOR THE REPAIR OF ANY EXISTING CONDITIONS DISTURBED OR DAMAGED DURING CONSTRUCTION.

B. PROVIDE FOR A SITE INVESTIGATION OF EXISTING PLUMBING AND BUILDING CONDITIONS DURING WALK THROUGH PRIOR TO PREPARATION OF BID AND COMMENCEMENT OF WORK.

C. PROVIDE FOR REVIEW OF THE CONTRACT DRAWINGS AND SPECIFICATIONS TO COORDINATE PLACEMENT AND INSTALLATION OF PLUMBING WORK IN COORDINATION WITH THE WORK OF OTHER TRADES. CONTRACTOR SHALL PROVIDE FOR THE FIELD COORDINATION & COMMUNICATION NECESSARY TO RESOLVE SITE DISCOVERED CONDITIONS WITH THE ELECTRICAL, MECHANICAL, AND GENERAL CONSTRUCTION CONTRACTORS. ADJUST THE LOCATIONS OF ALL PIPING, STACK, EQUIPMENT, AND CONNECTIONS TO ACCOMMODATE ACTUAL CONSTRUCTION CONDITIONS ENCOUNTERED;OBTAIN APPROVAL FROM THE ARCHITECT FOR ALL BUT MINOR CHANGES. WRITTEN SUGGESTIONS SHALL BE PROVIDED TO THE ARCHITECT AND ENGINEER PRIOR TO COMMENCING WITH WORK. THE PLUMBING CONSTRUCTION DRAWINGS ARE SCHEMATIC IN INTENT. PROVIDE FOR ALL MATERIALS, EQUIPMENT, AND LABOR NECESSARY FOR A COMPLETE INSTALLATION. ALL EQUIPMENT SHALL BE INSTALLED TO BE FULLY ACCESSIBLE FOR OPERATION AND MAINTENANCE IN ACCORDANCE WITH MANUFACTURER'S INSTALLATION REQUIREMENTS. PROVIDE VALVES, BACKFLOW DEVICES, AND WATER HAMMER ARRESTORS AT REMOVABLE CEILING TILES, BEHIND 16"x16" ACCESS DOORS, OR ACCESSIBLE FROM A STANDING POSITION ON THE FLOOR.

D. PROVIDE FOR ALL CUTTING, PATCHING, CORE DRILLS, ACCESS DOORS, AND FIRE STOPPING REQUIRED TO ACCOMPLISH WORK SHOWN. PATCH AND SEAL OPENINGS TO MATCH ADJACENT EXISTING WALLS, FLOORS, CEILINGS, ETC. UNLESS OTHERWISE INDICATED. CONCEAL ALL WORK IN FINISHED AREAS UNLESS OTHERWISE INDICATED OR DIRECTED BY THE ARCHITECT.

E. FIELD VERIFY ALL LOCATIONS, DIMENSIONS AND EXISTING CONDITIONS (PIPING, DUCTWORK, EQUIPMENT, STRUCTURAL ELEMENTS, ETC.) PRIOR TO COMMENCING WITH WORK. CONTRACTOR SHALL COORDINATE INSTALLATION OF EQUIPMENT AND PIPING WITH EXISTING CONDITIONS AND OTHER TRADES. PROVIDE FITTINGS, TRANSITIONS, OFFSETS, ELEVATION CHANGES, ETC. TO MINIMIZE CONFLICTS WITH EXISTING CONDITIONS.

F. PROVIDE ALL GAS, WATER, DRAINS, INDIRECT WASTE, ETC. CONNECTIONS TO MECHANICAL EQUIPMENT AS INDICATED ON THE PLANS. COORDINATE WORK WITH OTHER TRADES FOR FINAL CONNECTION POINTS.

G. PROVIDE ALL SUBMITTED EQUIPMENT AND SYSTEMS IN COMPLIANCE WITH THE MANUFACTURERS WRITTEN INSTALLATION INSTRUCTIONS AND SPECIFICATIONS.

H. ALL PHYSICAL ATTRIBUTES OF EQUIPMENT AND DEVICES ARE BASED ON THOSE MANUFACTURERS LISTED IN THE SPECIFICATIONS AND/OR THE EQUIPMENT SCHEDULES. PROVIDE FOR ALL CHANGES BROUGHT ABOUT BY THE USE OF ITEMS SUBMITTED BY OTHER MANUFACTURERS AT NO ADDITIONAL COST TO OWNER. THE ARCHITECT/ENGINEER HAS RESERVED THE RIGHT TO REJECT ITEMS BY OTHER MANUFACTURERS.

I. THE EXISTING BUILDING MATERIALS MAY CONTAIN ASBESTOS CONTAINING MATERIALS. REFER TO CONTRACT DRAWINGS AND PROJECT MANUAL FOR MORE INFORMATION.

J. PROVIDE FOR THE PROPER OFF-SITE DISPOSAL OF ALL CONSTRUCTION DEBRIS AND/OR EXCAVATED MATERIALS ASSOCIATED WITH WORK IN THIS TRADE IN COMPLIANCE WITH LOCAL, NEW YORK STATE AND FEDERAL LAWS AND REQUIREMENTS.

K. PROVIDE FOR THE JET FLUSHING AND MECHANICAL CLEANING OF ALL NEW AND EXISTING SANITARY SEWERS ASSOCIATED WITH THE SCOPE OF WORK UPON COMPLETION OF THE PROJECT. ALL NEW FLOOR DRAINS AND TRAPS SHALL BE CLEANED. CLEAN AND JET FLUSH BUILDING MAIN SANITARY SEWER BRANCH FROM THE BUILDING EXIT POINT TO THE EXTERIOR MANHOLE UPON COMPLETION OF THE PROJECT.

L. PROVIDE ALL MATERIALS, EQUIPMENT, LABOR, ETC. AS REQUIRED TO PERFORM THE CONTRACT WORK. ALL SYSTEMS AND EQUIPMENT SHALL BE COMPLETE AND OPERATIONAL.

M. PLUMBING EQUIPMENT IN PUBLIC SPACES SHALL BE FULLY HANDICAPPED ACCESSIBLE. EQUIPMENT FOR USE IN SPACES SPECIFICALLY DESIGNATED FOR HANDICAPPED USE SHALL BE DESIGNED FOR HANDICAPPED USE AND SHALL CONFORM TO THE AMERICANS WITH DISABILITIES ACT (CURRENT EDITION).
- N. PROVIDE ALL WORK OF THIS PROJECT IN COMPLIANCE WITH ALL LOCAL, PLUMBING CODE OF NEW YORK STATE 2020, FEDERAL CODES, APPLICABLE NFPA STANDARDS, AND THE NEW YORK STATE THRUWAY AUTHORITY WRITTEN STANDARDS.

O. OBTAIN ALL NECESSARY INSPECTIONS OF ROUGHED IN PIPING CONCEALED IN CHASES, WALLS, OR ABOVE CEILINGS BY ENGINEER PRIOR TO COMPLETION OF WALLS AND CEILINGS.

P. LOCATE PIPING TO PREVENT FREEZING. DO NOT INSTALL WATER PIPING IN EXTERIOR WALLS.

Q. THE DRAWINGS DO NOT INDICATE ALL OFFSETS, CHANGES IN ELEVATION, ETC., WHICH MAY BE REQUIRED. MAKE CHANGES IN THE LOCATIONS OF PIPING AND EQUIPMENT, ETC., TO ACCOMMODATE WORK, OBSTACLES, AND THE WORK OF OTHER CONTRACTORS. PROVIDE FOR ELBOWS, TEES, AND FITTINGS AS REQUIRED.

R. ALL PIPES PENETRATING RATED WALLS AND FLOOR DECKS SHALL BE FIRESTOPPED USING APPROVED, U.L. LISTED FIRE STOPPING MATERIAL. REFER TO THE ARCHITECTURAL DRAWINGS FOR FIRE RATED WALL AND FLOOR PENETRATION LOCATIONS; CONFIRM ALL LOCATIONS WITH ARCHITECTURAL PLANS. PATCH / REPAIR ALL ABANDONED PIPE PENETRATIONS THROUGH FLOOR DECKS AND WALLS TO MATCH ADJACENT EXISTING FINISHES.

S. PROVIDE ALL EQUIPMENT IN COMPLETE COMPLIANCE WITH MANUFACTURERS INSTALLATION INSTRUCTIONS, AND THE PROJECT SPECIFICATIONS.

T. PROVIDE CLEANOUTS AT THE BASE OF EACH SANITARY STACK, AND AT CHANGES IN DIRECTION AS REQUIRED BY CODE. WALL CLEANOUTS IN FINISHED SPACES SHALL BE CONCEALED BY CHROME OR APPROVED CLEANOUT COVER. FLOOR CLEANOUT LOCATIONS SHALL BE ACCESSIBLE AND TWO (2) FEET AWAY FROM WALLS AND OBSTRUCTIONS.

U. PROVIDE MINIMUM 16"x16" ACCESS PANELS FOR ALL VALVES, WATER HAMMER ARRESTORS, CLEANOUTS, ETC CONCEALED BEHIND WALLS AND ABOVE GYPSUM BOARD CEILINGS, WHERE OTHERWISE INACCESSIBLE. ACCESS DOORS SHALL BE FACTORY PRIMED AND FIELD PAINTED. PROVIDE DOORS WITH LOCKABLE TUMBLER. ACCESS PANELS SHALL BE FIRE RATED CONSTRUCTION TO MATCH THE WALL OR CEILING FIRE RATING WHERE APPLICABLE.

V. PROVIDE FOR TESTING OF ALL PLUMBING EQUIPMENT AND PIPING SYSTEMS FOR PROPER OPERATION. PROVIDE FOR TESTING OF ALL PIPING AND EQUIPMENT IN COMPLIANCE WITH THE PLUMBING CODE OF NEW YORK STATE 2020 AND IN ACCORDANCE WITH MANUFACTURERS REQUIREMENTS.

W. PROVIDE COMPLETE RECORD DRAWINGS DEPICTING THE FINAL INSTALLED LOCATIONS OF PIPING, EQUIPMENT, VALVES, CLEANOUTS AS-BUILT ON A CLEAN SET OF PLANS. PROVIDE FULL SIZE COPIES FOR THE OWNER, ARCHITECT AND ENGINEER. PROVIDE (3) COPIES OF THE OPERATION AND MAINTENANCE MANUALS TO OWNER INCLUDING ALL PRODUCTS AND MECHANICAL EQUIPMENT.


X. PROVIDE FOR ALL SPECIALTIES, INCLUDING HANGERS, SUPPORTS, CONTROLS, INSULATION, VALVES, AS REQUIRED FOR THE INSTALLATION.

Y. INSULATE ALL NEW COLD, HOT AND HOT WATER RECIRCULATION PIPING IN COMPLIANCE WITH THE ENERGY CONSERVATION CODE OF NEW YORK STATE (2020 VERSION). REPLACE INSULATION REMOVED OR DAMAGED DURING CONSTRUCTION.

Z. THE EXISTING PIPING CONDITIONS HAVE BEEN OBTAINED FROM THE ORIGINAL CONSTRUCTION DRAWINGS. ACTUAL AS BUILT PIPING CONDITIONS MAY VARY. THE CONTRACTOR SHALL FIELD VERIFY ALL EXISTING CONDITIONS AND REPORT ANY DISCREPANCIES TO ENGINEER IN WRITING PRIOR TO PROCEEDING WITH WORK.

AA. PROVIDE FOR PROTECTION OF PLUMBING WORK DURING CONSTRUCTION IN COMPLIANCE WITH CHAPTER 3 OF THE PLUMBING CODE OF NEW YORK STATE 2020.

AB. MINIMUM SLOPE FOR DRAINAGE PIPE WITHIN 5'-0" OF BUILDING IS ¼" PER FOOT FOR 2-½" DIAMETER AND LESS / ⅛" PER FOOT FOR 3" DIAMETER AND GREATER. MINIMUM SLOPE FOR DRAINAGE PIPE BEYOND 5'-0" OF BUILDING IS 1%.

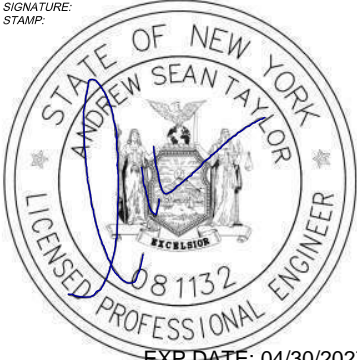ALTERED ON:	AFFIXED ON: 07/30/2025
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REVISIONS			
DATE	DESCRIPTION	BY	SYM.










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
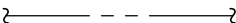
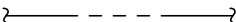








CONTRACTOR SHALL BE RESPONSIBLE FOR VERIFICATION OF ALL UNDERGROUND UTILITY LOCATIONS AND PROVIDE ALL PROTECTIVE MEASURES FOR EXCAVATION AND UNDERGROUND UTILITY WORK.


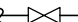





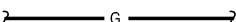


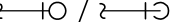
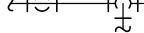




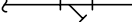


CALL:
DIG SAFELY: 811 OR 1-800-962-7962
A MINIMUM OF TWO (2) DAYS PRIOR TO COMMENCING WITH EXCAVATION.

TITLE OF PROJECT ADDITIONS TO MAINTAINACE SECTION	CONTRACT NUMBER: TAS 25-9A
LOCATION OF PROJECT MANCHESTER MP 340.15	DATE: 07/30/25
TITLE OF DRAWING PLUMBING NOTES	DRAWING NUMBER: PG100

DESIGNED BY: J.L. MORRIS
BUREAU DIRECTOR:
CHECKED BY: MPC
DRAFTED BY: MPC
GMU/AAW

PLUMBING SYMBOL LIST	
	POINT OF CONNECTION (NEW TO EXISTING)
	TERMINATION POINT OF DEMOLITION
	PLUMBING KEYED NOTE
	DEMOLITION KEYED NOTE
	REVISION KEYED NOTE
	SECTION: TOP CHARACTER INDICATES SECTION NUMBER, BOTTOM CHARACTER INDICATES DRAWING ON WHICH SECTION APPEARS
	FLOOR / CUT / PATCH (UNDERSLAB)

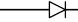PLUMBING SYMBOL LIST	
	COLD WATER PIPING (C)
	HOT WATER PIPING (H)
	RECIRCULATING HOT WATER PIPING (HWR)
	SANITARY OR WASTE PIPING (SAN)
	BELOW FLOOR SANITARY OR WASTE PIPING ((BF)SAN)
	VENT PIPING
	STORM SEWER PIPING (ST)
	NATURAL GAS PIPING (G)
	INDIRECT WASTE (IW)
	EXISTING PIPING TO REMAIN
	REMOVE EXISTING PIPING (REMOVAL PLANS)

PLUMBING SYMBOL LIST	
	BALL VALVE
	GATE VALVE
	CHECK VALVE
	BALANCING VALVE
	BRONZE STRAINER
	FLOOR DRAIN (FD)
	FLOOR CLEANOUT (FCO)
	FLOOR SINK (FS)
	ROOF DRAIN (RD)
	WALL HYDRANT (WH), HOSE BIBB (HB) (HS), OR HOSE END DRAIN VALVE
	ELBOW UP / ELBOW DN.
	DROP CONNECTION, RISE CONNECTION
	SHOWER HEAD - (FINAL LOCATION BY ARCHITECT - REFER TO ARCHITECT PLANS)
	DIRECTION OF FLOW
	CAP OR PLUG EXISTING PIPING AT MAIN
	LUBRICATED PLUG VALVE (GAS PIPING)
	PIPE REDUCER
	ANCHOR
	WATER HAMMER ARRESTOR

PLUMBING ABBREVIATIONS					
AFF	ABOVE FINISHED FLOOR	G	GAS	SAN	SANITARY SEWER
BFP	BACK FLOW PREVENTER	GC	GENERAL CONTRACTOR	SAN(BF)	BELOW FLOOR SANITARY
BLDG	BUILDING	HB	HOSE BIBB	SK	SINK
CO	CLEANOUT	HW.	HOT WATER	ST	STORM SEWER
CONC	CONCRETE	HWR	HOT WATER RETURN	TYP	TYPICAL
CW	COLD WATER	IW	INDIRECT WASTE	UR	URINAL
DN	DOWN	LAV	LAVATORY	V	VENT
DWG	DRAWING	MSS	MOP SERVICE SINK	VTR	VENT THRU ROOF
DWH	DOMESTIC WATER HEATER	NTS	NOT TO SCALE	WC	WATER CLOSET
ETR	EXISTING TO REMAIN	PC	PLUMBING CONTRACTOR	WCO	WALL CLEANOUT
FCO	FLOOR CLEANOUT	P	PROPANE	WH	WALL HYDRANT
FD	FLOOR DRAIN	RD	ROOF DRAIN	WHA	WATER HAMMER ARRESTOR
FIN.	FINISH/FINISHED	RM	ROOM		


FIXTURE CONNECTION SCHEDULE							
FIXTURE	FIXTURE TYPE(s)		WASTE	VENT	HOT WATER	COLD WATER	NOTES:
WATER CLOSET	WC-A	WC-B	4"	2"	-	1"	
URINAL	UR-A	UR-B	2"	2"	-	3/4"	
LAVATORY	LAV-A	LAV-B	1-1/2"	1-1/2"	1/2"	1/2"	
SHOWER	SHR-A		2"	2"	1/2"	1/2"	
SINK	SK-A		1-1/2"	1-1/2"	1/2"	1/2"	
WATER COOLER	EW-C		1-1/2"	1-1/2"	-	1/2"	
GENERAL NOTE: 1. REFER TO SPECIFICATION SECTION 224000 PLUMBING FIXTURES FOR PRODUCT SPECIFICATIONS. 2. THE DOMESTIC WATER PIPING AND COMPONENTS SHALL COMPLY WITH ANSI/NSF 61, NSF 62 ANNEX G AND NSF 372 FOR DRINKING WATER COMPONENTS. THE LEAD CONTENT OF DRINKING WATER PIPING AND COMPONENTS SHALL NOT EXCEED 0.25 PERCENT BY WEIGHTED AVERAGE. PLASTIC PIPING COMPONENTS SHALL BE MARKED WITH "NSF-PW."							

WATER HAMMER ARRESTOR			
NO.	FIXTURE UNIT RATING	SIZE	PDI SYMBOL
WHA-A	1-11	3/4"	A
GENERAL NOTE: 1. PROVIDE LIFETIME WARRANTY OR ACCESS PANEL.			

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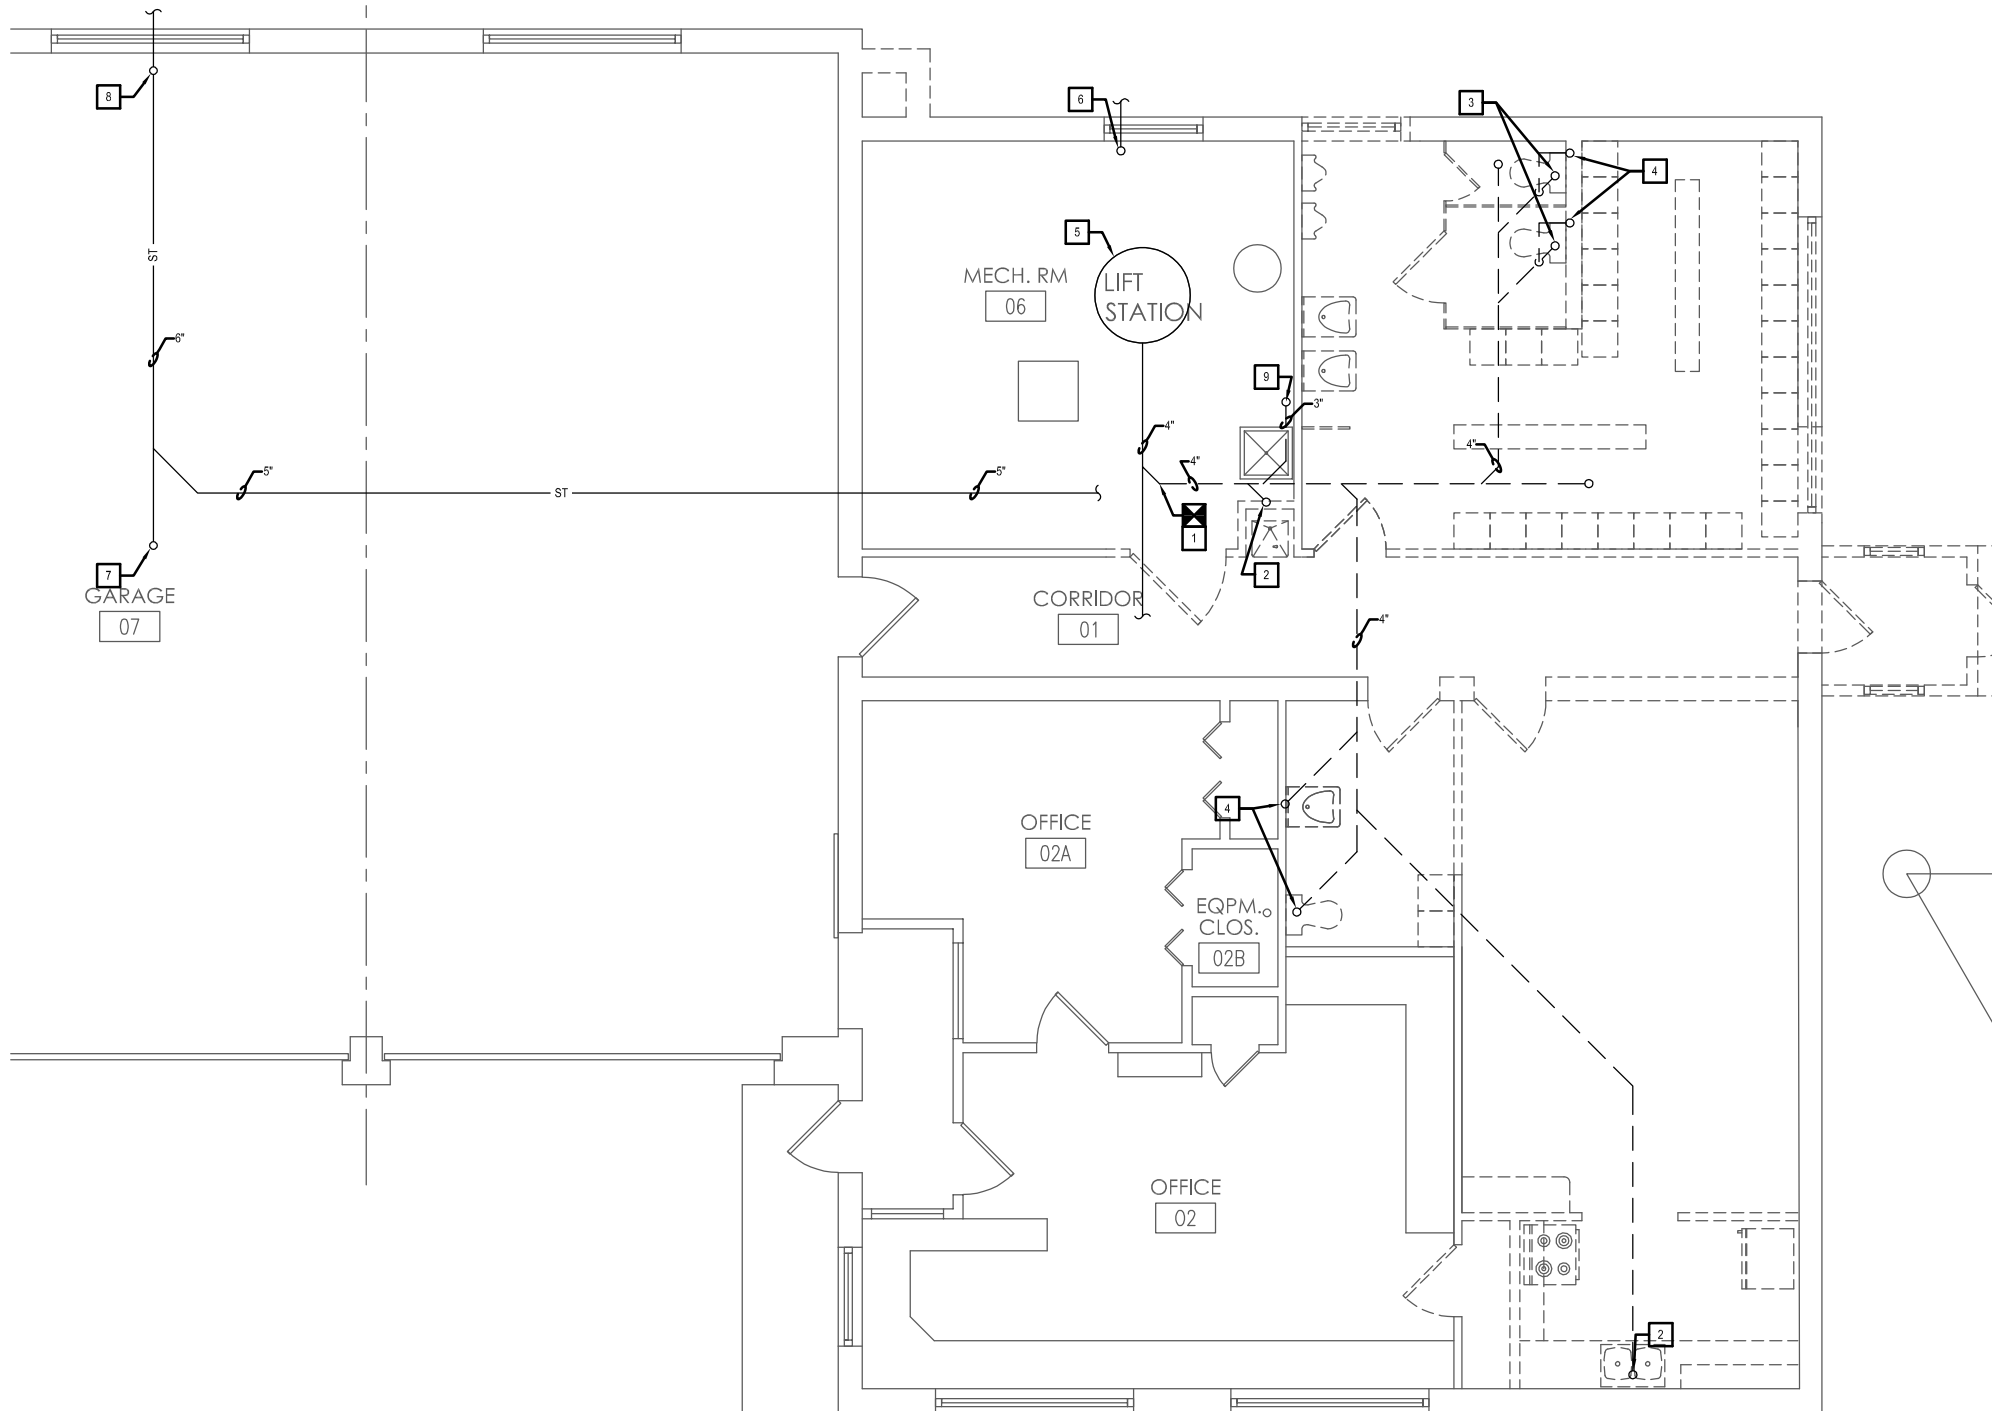
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TITLE OF PROJECT ADDITIONS TO MAINTAINACE SECTION	CONTRACT NUMBER: TAS 25-9A
LOCATION OF PROJECT MANCHESTER MP 340.15	DATE: 07/30/25
TITLE OF DRAWING PLUMBING LEGENDS, SCHEDULES & SYMBOLOGY	DRAWING NUMBER: PG101

KEYED NOTES: #

1. DISCONNECT AND REMOVE 4" SAN BACK TO POINT SHOWN AND CAP. REMAINING PIPING SHALL BE USED FOR CONNECTION TO NEW WORK.
2. REMOVE 2" SAN UP.
3. REMOVE 4" SAN UP.
4. REMOVE 2" VENT UP.
5. EXISTING SEWAGE GRINDER/ EJECTOR TO REMAIN.
6. EXISTING 2" WATER UP.
7. 6" ST UP.
8. 8" ST UP.
9. REMOVE 3" SAN UP.



1 PLUMBING – BELOW FLOOR PLAN – REMOVAL
SCALE: 1/16" = 1'-0"

DESIGNED BY: J.L. MORRIS	ALTERED ON:	AFFIXED ON: 07/30/2025
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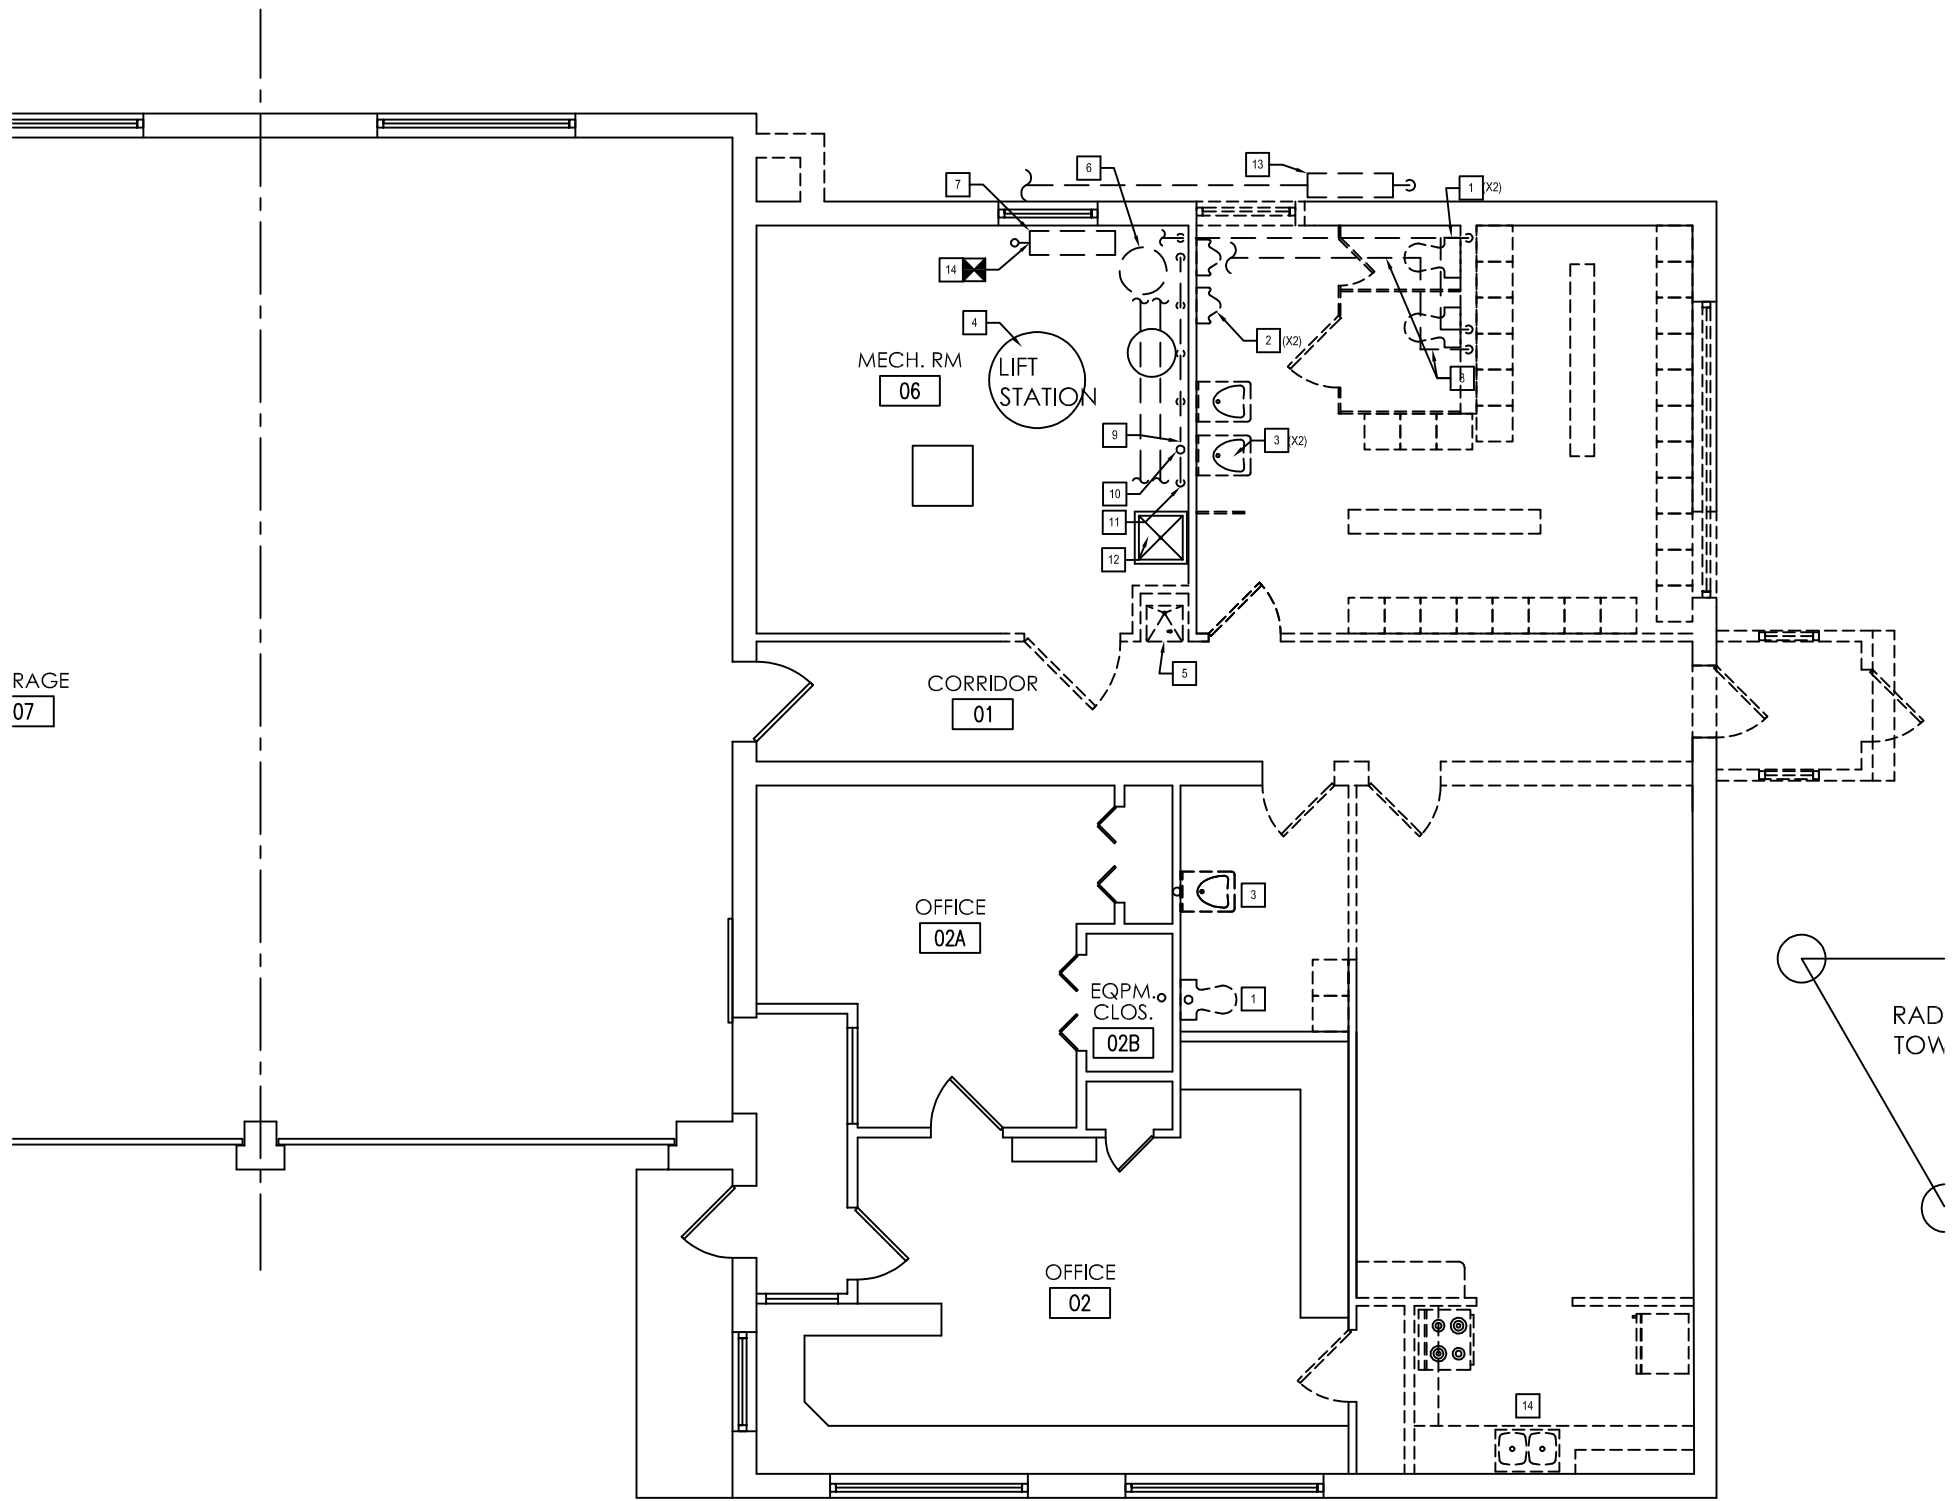


TITLE OF PROJECT ADDITIONS TO MAINTAINACE SECTION	CONTRACT NUMBER: TAS 25-9A
LOCATION OF PROJECT MANCHESTER MP 340.15	DATE: 07/30/25
TITLE OF DRAWING PLUMBING BELOW FLOOR REMOVAL PLAN	DRAWING NUMBER: PD100

KEYED NOTES: #

1. REMOVE FLOOR MOUNTED WATER CLOSET, 4" SAN, 2" VENT AND 1" CW BRANCH PIPING IN ITS ENTIRETY.
2. REMOVE WALL MOUNTED URINAL, CARRIER, 2" SAN, 2" VENT AND 1/2" CW PIPING IN ITS ENTIRETY.
3. REMOVE WALL MOUNTED LAVATORY, CARRIER, 1-1/2" SAN, 1-1/2" VENT, 1/2" CW AND 1/2" HW BRANCH PIPING IN ITS ENTIRETY.
4. EXISTING LIFT STATION TO REMAIN.
5. REMOVE WATER COOLER, 1-1/2" SAN, 1-1/2" VENT AND 1/2" CW BRANCH PIPING IN ITS ENTIRETY.
6. REMOVE GAS-FIRED WATER HEATER, 3/4" HW AND 3/4" CW BRANCH PIPING IN ITS ENTIRETY. DISCONNECTION BY OTHERS.
7. REMOVE RPZ AND 2" PIPING AND CAP ABOVE FLOOR.
8. REMOVE ALL CW PIPING BACK TO METER. REMOVE ALL HW PIPING BACK TO HOT WATER TANK.
9. DISCONNECT 2" SAN PIPING FROM 2" SAN PIPING.
10. REMOVE 2" VENT PIPING UP.
11. REMOVE 2" SAN PIPING DN.
12. REMOVE MOP SINK, FAUCET AND ALL ASSOCIATED BRANCH PIPING.
13. DISCONNECT AND REMOVE GAS PIPING FROM GAS METER IN ITS ENTIRETY. COORDINATE WITH NATIONAL FUEL GAS FOR METER REMOVAL.
14. REMOVE DROP-IN SINK, 2" SAN, 1-1/2" VENT, 1/2" CW AND 1/2" HW BRANCH PIPING IN ITS ENTIRETY.

RAGE
07



1 PLUMBING – FLOOR PLAN – REMOVAL
SCALE: 1/16" = 1'-0"

DESIGNED BY: J.L. MORRIS	ALTERED ON:	AFFIXED ON: 07/30/2025
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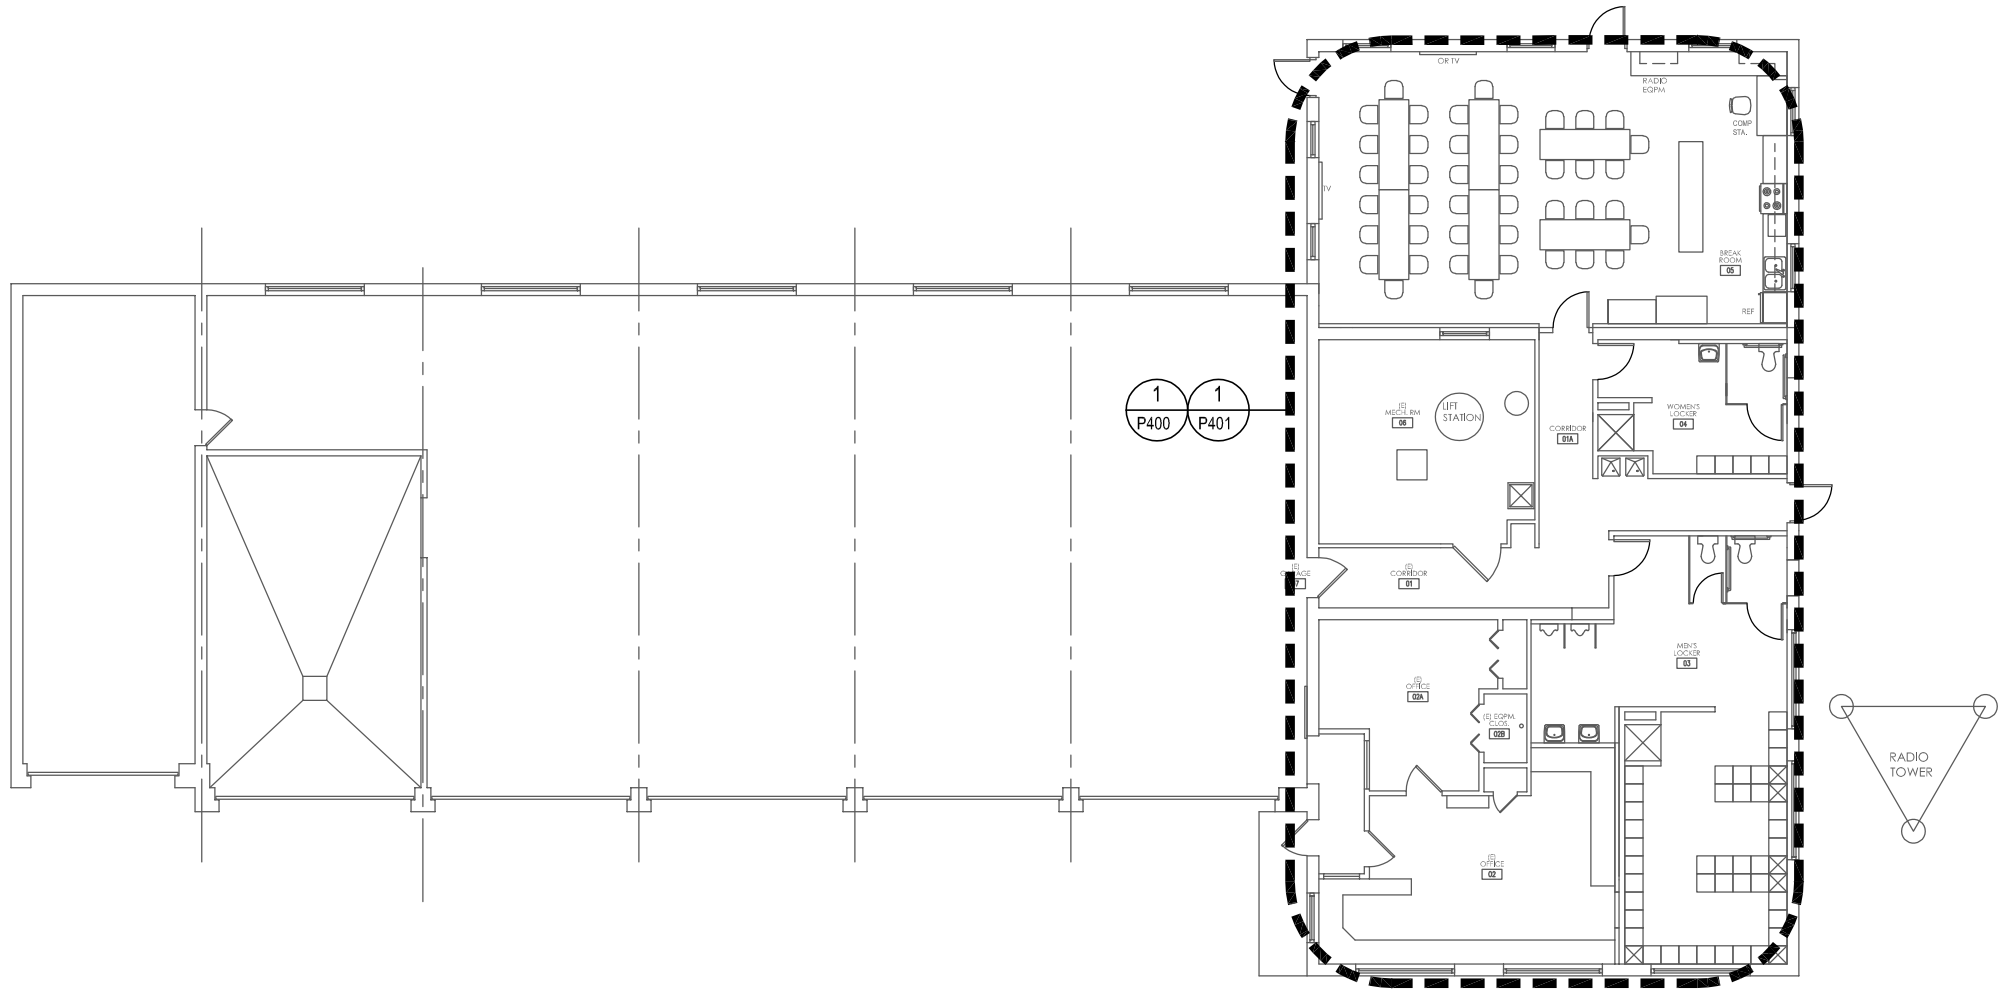
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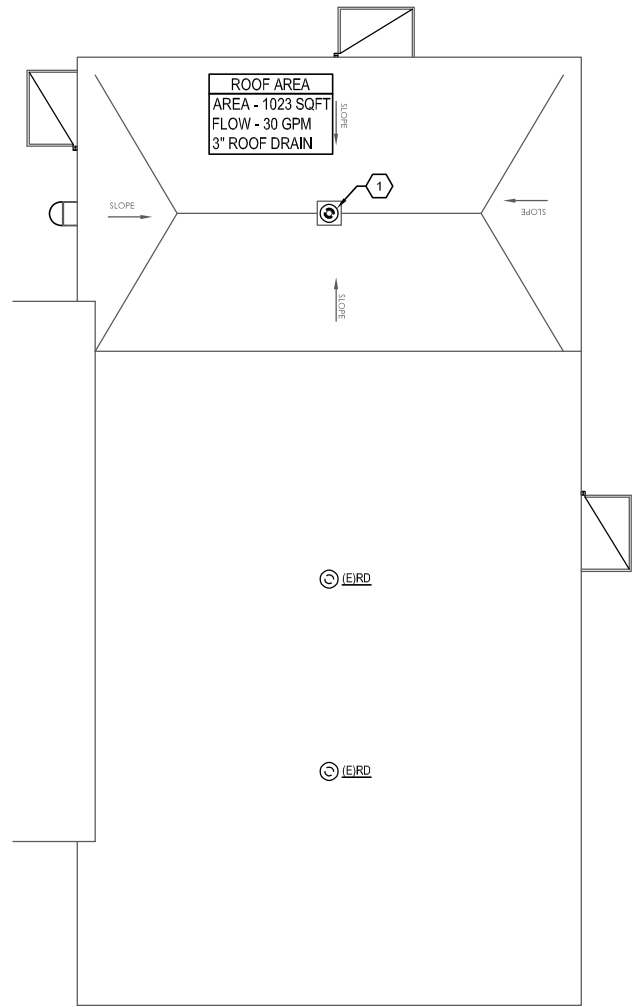
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DATE	DESCRIPTION	BY	SYM.

NEW YORK
STATE OF
OPPORTUNITY.

TITLE OF PROJECT ADDITIONS TO MAINTAINACE SECTION	CONTRACT NUMBER: TAS 25-9A
LOCATION OF PROJECT MANCHESTER MP 340.15	DATE: 07/30/25
TITLE OF DRAWING PLUMBING REMOVAL PLAN	DRAWING NUMBER: PD101



1 PLUMBING – OVERALL FLOOR PLAN
SCALE: 1/16" = 1'-0"



2 PLUMBING – PARTIAL ROOF PLAN
SCALE: 1/16" = 1'-0"

KEYED NOTES: #

1. PROVIDE 3" ROOF DRAIN.

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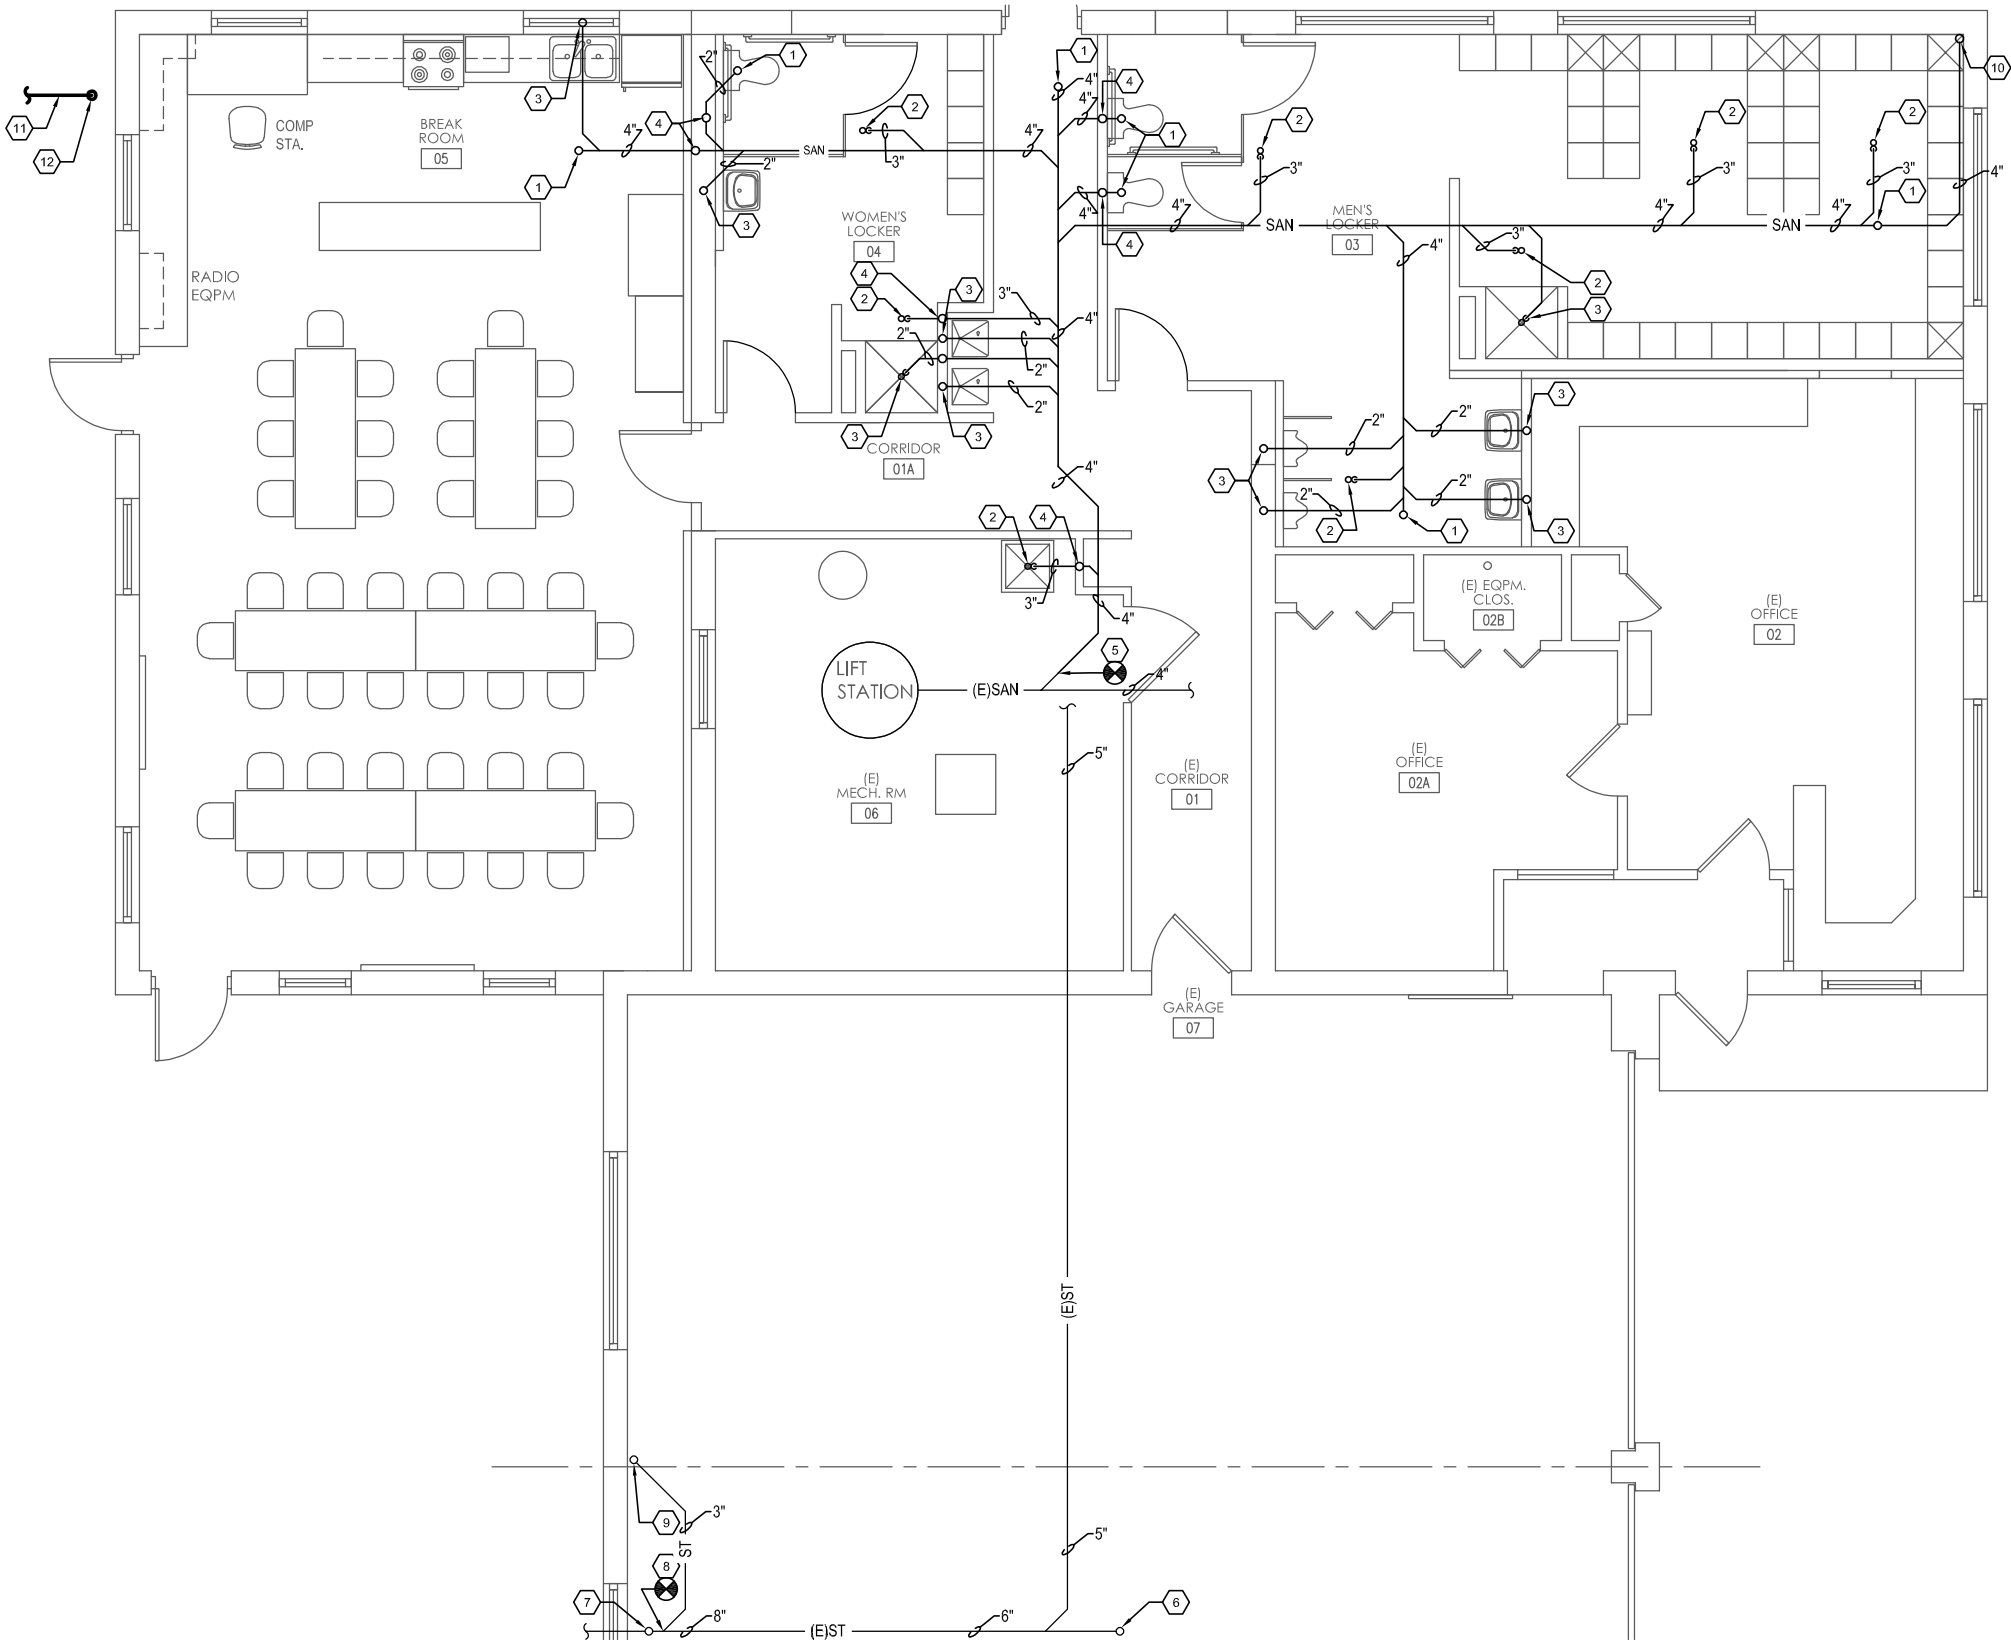
REVISIONS			
DATE	DESCRIPTION	BY	SYM.



TITLE OF PROJECT ADDITIONS TO MAINTAINACE SECTION	CONTRACT NUMBER: TAS 25-9A
LOCATION OF PROJECT MANCHESTER MP 340.15	DATE: 07/30/25
TITLE OF DRAWING PLUMBING FLOOR PLANS	DRAWING NUMBER: P101

KEYED NOTES: #

1. 4" SAN UP.
2. 3" SAN UP.
3. 2" SAN UP.
4. 2" VENT UP.
5. CONNECT 4" SAN TO EXISTING 4" SAN. CONFIRM ELEVATION OF SANITARY PIPING BEFORE NEW WORK BEGINS.
6. EXISTING 6" ST UP.
7. EXISTING 8" ST UP.
8. CONNECT 4" ST TO EXISTING 8" ST.
9. 3" ST UP.
10. 4" VENT UP.
11. COORDINATE WITH NATIONAL FUEL GAS FOR SERVICE RELOCATION.
12. GAS SERVICE PIPING UP TO METER.



1 PLUMBING – ENLARGED BELOW FLOOR PLAN
SCALE: 1/8" = 1'-0"

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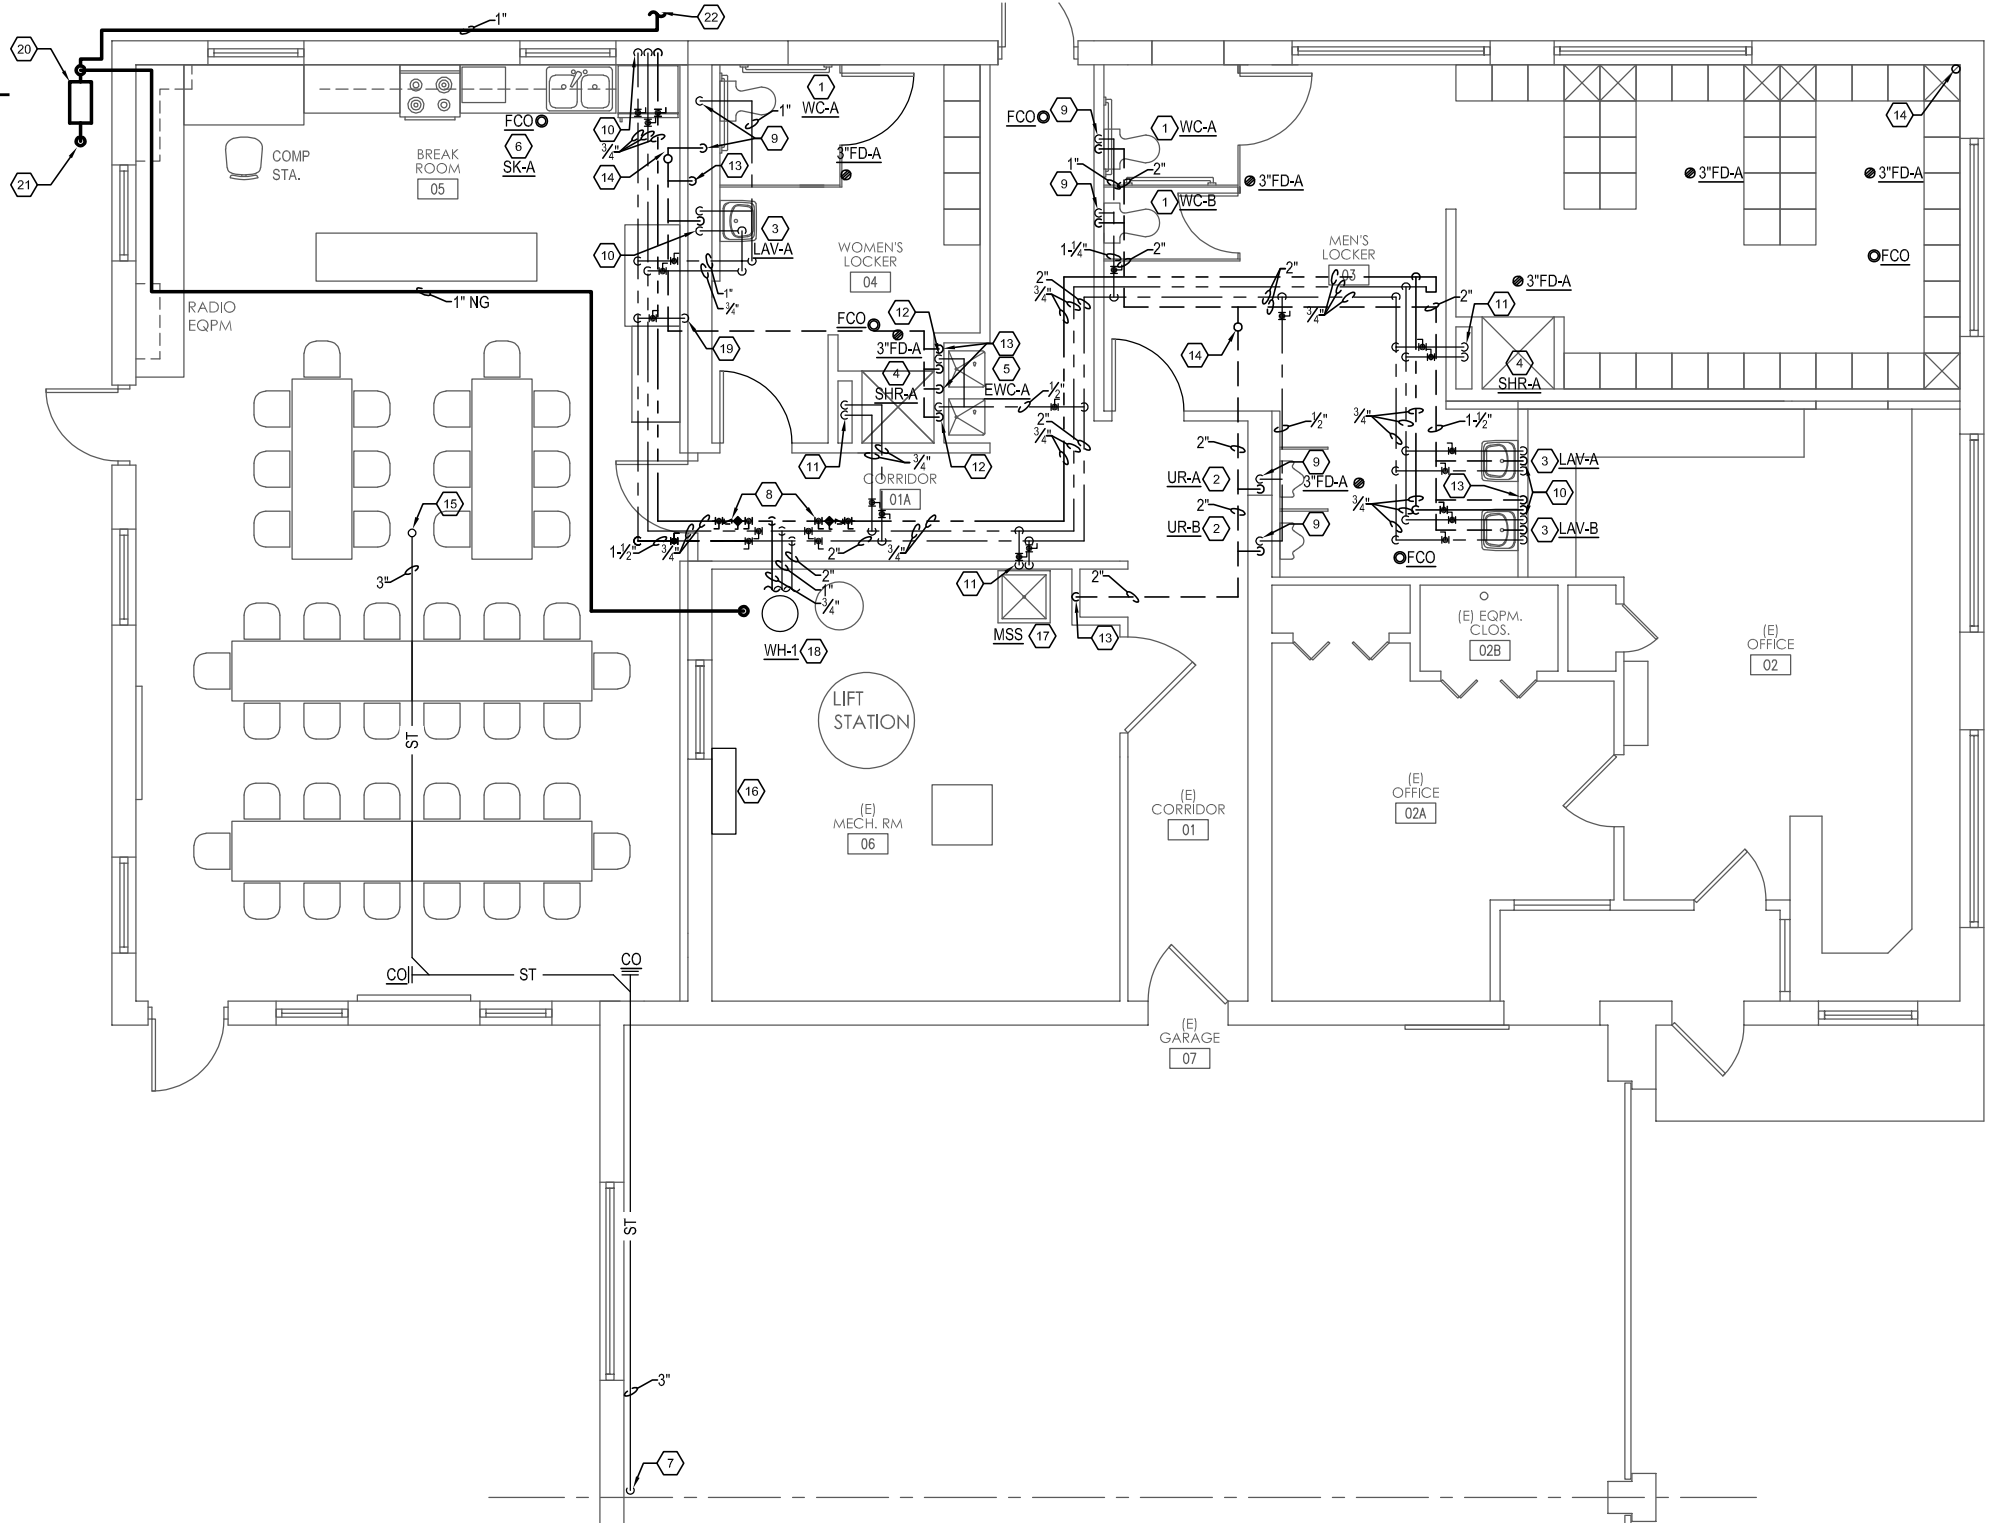
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DATE	DESCRIPTION	BY	SYM.



TITLE OF PROJECT ADDITIONS TO MAINTAINACE SECTION	CONTRACT NUMBER: TAS 25-9A
LOCATION OF PROJECT MANCHESTER MP 340.15	DATE: 07/30/25
TITLE OF DRAWING PLUMBING ENLARGED FLOOR PLAN	DRAWING NUMBER: P400

KEYED NOTES: #

1. PROVIDE WATER CLOSET AND ALL ASSOCIATED CW, SAN AND VENT BRANCH PIPING.
2. PROVIDE WALL MOUNTED URINAL, CARRIER AND ALL ASSOCIATED CW, SAN AND VENT BRANCH PIPING.
3. PROVIDE WALL MOUNTED LAVATORY, CARRIER AND ALL CW, HW, SAN AND VENT BRACH PIPING.
4. PROVIDE SHOWER BASE, MIXING VALVE, HEAD AND ALL ASSOCIATED CW, HW, SAN AND VENT BRANCH PIPING.
5. PROVIDE ELECTRIC WATER COOLER, CARRIER AND ALL ASSOCIATED CW, SAN AND VENT PIPING.
6. PROVIDE DROP-IN DOUBLE BASIN SINK AND ALL ASSOCIATED CW, HW, SAN AND VENT BRANCH PIPING.
7. 3" ST DN, PROVIDE CLEANOUT AT BASE.
8. PROVIDE BALL, CHECK AND MEMORY STOP BALANCING VALVES ON DOMESTIC HOT WATER RECIRCULATION PIPING, 1 GPM.
9. 1" CW AND 2" VENT DN.
10. 1/2" CW, 1/2" HW AND 1/2" HWR DN.
11. 1/2" CW AND 1/2" HW DN.
12. 1/2" CW AND 1-1/2" VENT DN.
13. 2" VENT DN.
14. 4" VENT THRU ROOF.
15. 3" ST UP.
16. NEW 2" BACKFLOW PREVENTOR. EXISTING METER TO BE REUSED.
17. PROVIDE MOP SINK AND ALL ASSOCIATED CW, HW, SAN AND VENT PIPING.
18. PROVIDE ELECTRIC DOMESTIC WATER HEATER, CIRCULATION PUMP, EXPANSION TANK AND ALL ASSOCIATED BRANCH CW, HW AND HWR PIPING.
19. 1/2" CW DOWN FOR ICE MACHINE.
20. COORDINATE WITH NATIONAL FUEL GAS FOR RELOCATED SERVICE AND NEW METER.
21. GAS SERVICE PIPING FROM BELOW GRADE.
22. PROVIDE 1" GAS PIPING TO MECHANICAL SYSTEM AIR HANDLING UNIT. RUN PIPING ON EXTERIOR OF BUILDING, 18 INCHES ABOVE GRADE. PAINT WITH PRIME COAT AND TWO FINISH COATS OF PAINT. CLEAN PIPING BEFORE PAINTING. PROVIDE SHUT-OFF VALVE, UNION, DIRT LEG, AND FLEXIBLE CONNECTION. COORDINATE WITH MC FOR EXACT LOCATION AND REQUIREMENTS.



1 PLUMBING – FIRST FLOOR PLAN
SCALE: 1/8" = 1'-0"

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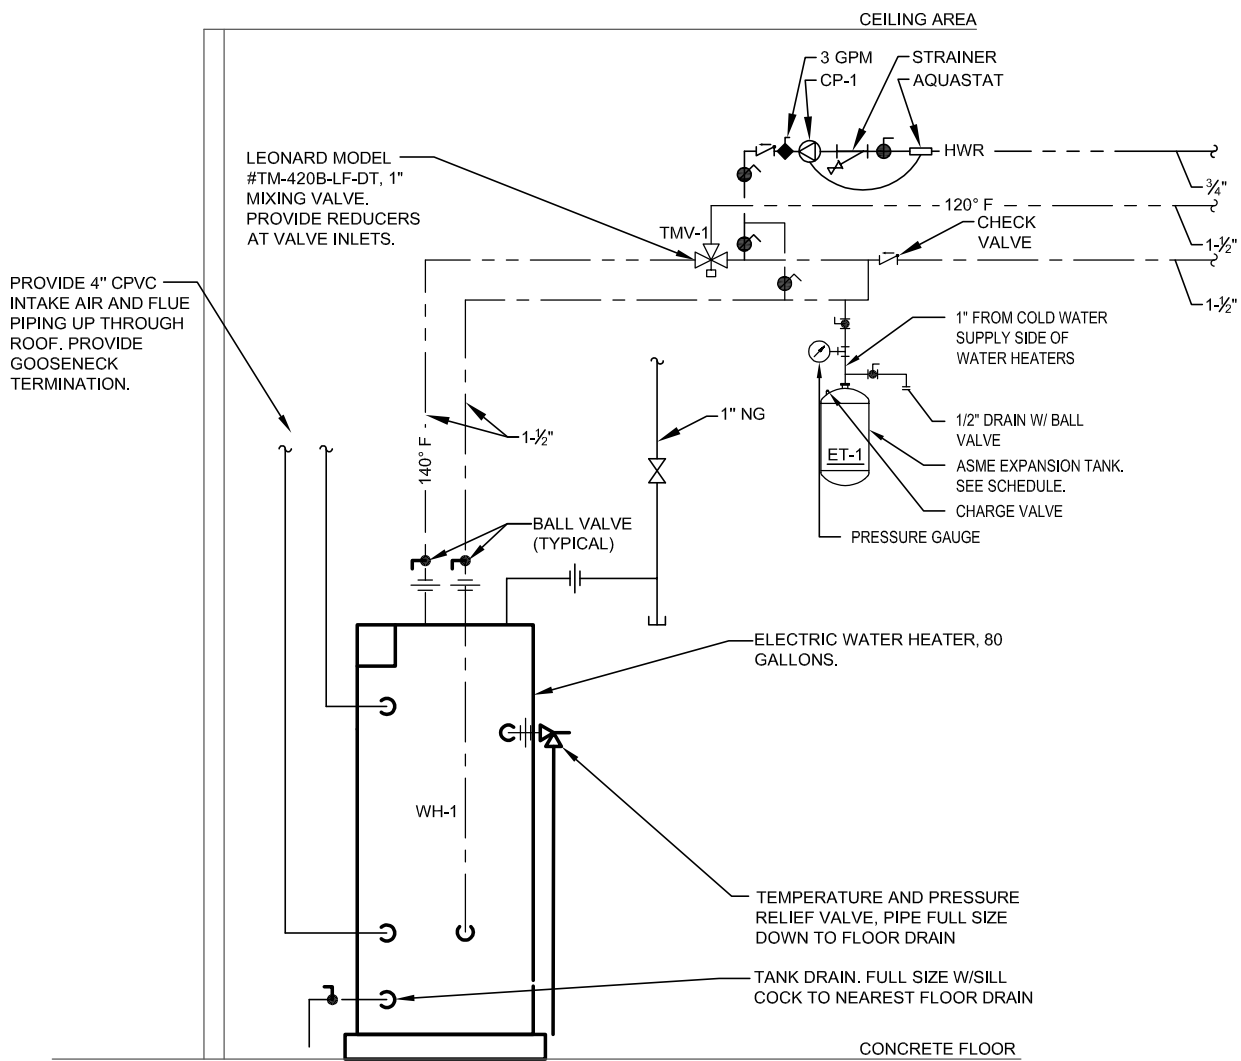
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LOCATION OF PROJECT MANCHESTER MP 340.15	DATE: 07/30/25
TITLE OF DRAWING PLUMBING ENLARGED FLOOR PLAN	DRAWING NUMBER: P401

DESIGNED BY: J.L. MORRIS
CHECKED BY: MEC
DRAFTED BY: MEC
CHECKED BY: MEC
DRAFTED BY: MEC
CHECKED BY: MEC
DRAFTED BY: MEC



1 ELECTRIC DOMESTIC WATER HEATER (WH-1)
SCALE: NOT TO SCALE

NATURAL GAS WATER HEATER SCHEDULE (WH)

PLAN DESIGNATION	MANUFACTURER MODEL NO.	LOCATION	STORAGE TEMP (F)	RECOVERY (GPH)	TEMP. RISE (°F)	NG INPUT (BTU/HR)	EFFICIENCY (%)	TANK SIZE (GAL.)	NOTES
WH-1	AO SMITH MODEL - BTH-150(A)	MECH/ CUST	140	173	100	100,000	98	100	1, 2, 3 & 4

- NOTES:
1. PROVIDE WATER HEATERS IN ACCORDANCE WITH MANUFACTURER'S WRITTEN INSTALLATION INSTRUCTIONS WITH THE REQUIRED CLEARANCES. REFER TO SPECIFICATION SECTION 223400.
 2. ASME TANK CERTIFIED FOR 160psi WITH ASME RELIEF VALVE (125 PSIG).
 3. PROVIDE 4" HIGH HOUSEKEEPING PAD FOR WATER HEATER.
 4. PROVIDE CONDENSATE NEUTRALIZATION KIT.

PUMP SCHEDULE

PLAN DESIGNATION	TYPE	MANUFACTURER MODEL No.	LOCATION	FLOW RATE (GPM)	HEAD (FT.)	ELECTRICAL DATA			NOTES
						HP	RPM	VOLTS/PH/Hz	
CP-1	HOT WATER RECIRCULATION PUMP (110°F) ADDITION	GRUNDFOS MODEL UP-26-99-BFC	MECH/ CUST --	8	28.0	1/6	3 SPEED	120 / 1 / 60	1 & 2

- NOTES:
1. LEAD-FREE BRONZE BODY WITH BRONZE FITTINGS (FOR POTABLE WATER APPLICATION).
 2. PROVIDE COMBINATION AQUASTAT AND AUTO TIMER CLOCK KIT. - (GRUNDFOS UP TIMER AND AQUASTAT)

EXPANSION TANK SCHEDULE (ET)

PLAN DESIGNATION	ASSOCIATED SYSTEM	TANK VOLUME (GAL.)	ACCEPTANCE VOLUME (GAL.)	MAX. OPERATING PRESSURE	FILL PRESSURE	RELIEF VALVE SETTING	WEIGHT (LBS.)	MODEL No.
ET-1	DOMESTIC HOT WATER SYSTEM WH-1	5	3.3	150 psig	40 psig	125 psig	28	WATTS REGULATOR MODEL DETA-12 ASME RATED

- GENERAL NOTES:
- A. UNIT TYPE: PRESSURIZED VERTICAL EXPANSION TANK (DIAPHRAGM TYPE).
 - B. ASME CODE LABELED.
 - C. ADJUST FILL PRESSURE TO EQUAL ACTUAL STATIC SUPPLY PRESSURE OF WATER.
 - D. LOCATE ON COLD WATER SUPPLY TO WATER HEATER, DOWNSTREAM OF CHECK VALVE.

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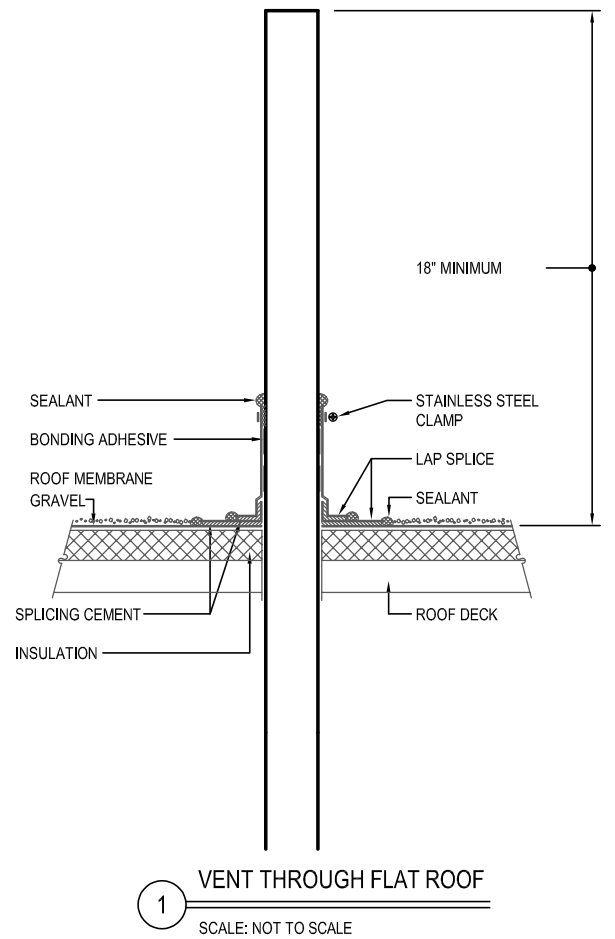
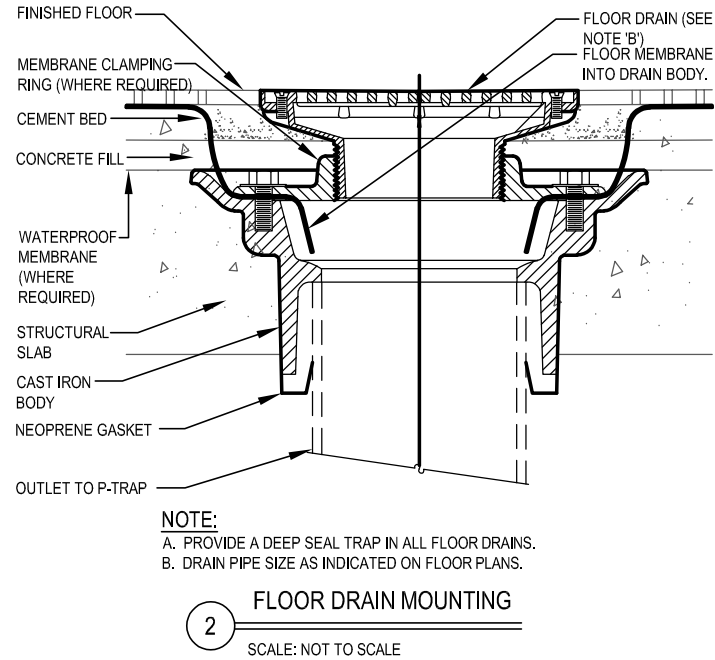
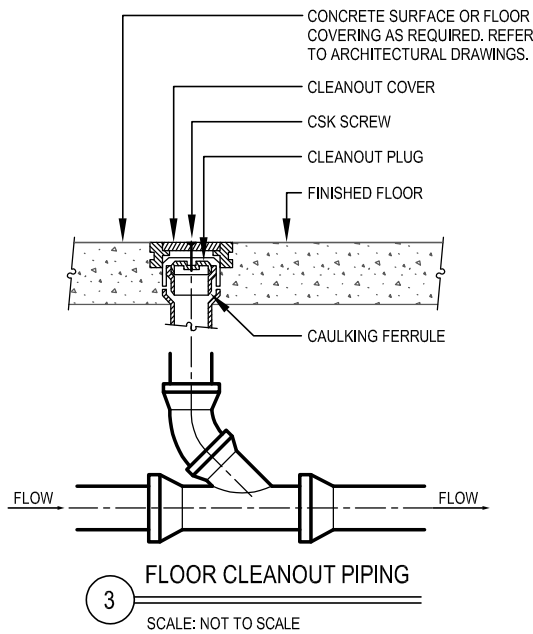
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TITLE OF PROJECT ADDITIONS TO MAINTAINACE SECTION	CONTRACT NUMBER: TAS 25-9A
LOCATION OF PROJECT MANCHESTER MP 340.15	DATE: 07/30/25
TITLE OF DRAWING PLUMBING DETAILS & SCHEDULES	DRAWING NUMBER: P501

DESIGNED BY: J.L. MORRIS
CHECKED BY: GM/VAW
DRAFTED BY: MPC
CHECKED BY: GM/VAW
DRAFTED BY: MPC



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LOCATION OF PROJECT MANCHESTER MP 340.15	DATE: 07/30/25
TITLE OF DRAWING PLUMBING DETAILS	DRAWING NUMBER: P502

CHECKED BY: DRAFTED BY: DESIGNED BY: J.L. MORRIS BUREAU DIRECTOR:



ELECTRICAL ABBREVIATIONS LIST

AFF	ABOVE FINISHED FLOOR	NIC	NOT IN CONTRACT
AFG	ABOVE FINISHED GRADE	OC	OVER THE COUNTER
BMS	BUILDING MANAGEMENT SYSTEM	PTZ	PAN, TILT, ZOOM
C	CONDUIT	PVC	POLYVINYL CHLORIDE CONDUIT
cd	CANDELLA	REC	RECESSED
CKT	CIRCUIT	SM	SURFACE MOUNTED
DISC	DISCONNECT	SPD	SURGE PROTECTIVE DEVICE
EWC	ELECTRIC WATER COOLER	SWBD	SWITCHBOARD
EMT	ELECTRICAL METALLIC TUBING	TVSS	TRANSIENT VOLTAGE SURGE SUPPRESSION
ETR	EXISTING TO REMAIN	UC	UNDER COUNTER
FBO	FURNISHED BY OTHERS	UF	UNDERFLOOR
GFI	GROUND FAULT INTERRUPTER	UG	UNDERGROUND
GRC	GALVANIZED RIGID CONDUIT	UTP	CATEGORY 6A UNSHIELDED TWISTED PAIR
IG	ISOLATED GROUND	VFD	VARIABLE FREQUENCY DRIVE
MC	MOMENTARY CONTACT	W	WATTS
MDP	MAIN DISTRIBUTION PANEL	WG	WIRE GUARD
MTD	MOUNTED	WP	WATERPROOF (OR) WEATHERPROOF
NEC	NATIONAL ELECTRICAL CODE	XFMR	TRANSFORMER
NEMA	NATIONAL ELECTRICAL MANUFACTURERS ASSOCIATION		
NL	NIGHT LIGHT		

ELECTRICAL GENERAL NOTES

- A. CONTRACTOR IS RESPONSIBLE FOR APPROPRIATE FIELD VERIFICATION AND SCOPE OF WORK. CONTRACTOR SHALL PERFORM FIELD MEASUREMENTS AS REQUIRED AND BE RESPONSIBLE FOR PLANNING THE NEW CONSTRUCTION.
- B. CONTRACTOR IS RESPONSIBLE FOR SITE INVESTIGATION PRIOR TO START OF WORK TO REVEAL EXISTING CONDITIONS
- C. IT IS THE CONTRACTORS RESPONSIBILITY TO EXAMINE ALL DRAWINGS AND SPECIFICATIONS AND COORDINATE WORK WITH ALL OTHER DISCIPLINES.
- D. CONTRACTOR IS RESPONSIBLE FOR ALL CUTTING, PATCHING AND REPAIRING OF MATERIALS AND FINISHES THAT ARE DISTURBED BY THEIR RESPECTIVE DISCIPLINES.
- E. CONTRACTOR SHALL COORDINATE WITH THE MECHANICAL CONTRACTOR FOR ALL POWER CONNECTIONS AND FINAL EQUIPMENT.
- F. CONTRACTOR SHALL PERFORM WORK ACCORDING TO CURRENT VERSION OF NEC, NFPA AND ALL APPLICABLE LOCAL, STATE AND FEDERAL CODES, INCLUDING CITY ORDINANCES AND OGS REQUIREMENTS.
- G. CONTRACTOR SHALL COORDINATE ELECTRICAL WORK WITH AVAILABLE AS-BUILT INFORMATION.

BRANCH WIRING

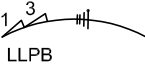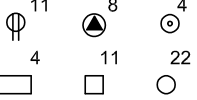	BRANCH CIRCUIT TO PANELBOARD, WHEN SHOWN, LETTERING INDICATES PANELBOARD DESIGNATIONS. QUANTITY OF ARROWHEADS INDICATE QUANTITY OF BRANCH CIRCUITS. PROTECT EACH BRANCH CIRCUIT WITH A 20 AMPERE, 1-POLE OVERCURRENT DEVICE UNLESS OTHER SIZE INDICATED. TYPICAL DESIGNATION, (2#12,1#12G-3/4"C,20A-1P.) NUMERAL INDICATES CIRCUIT NUMBER.
	ON BRANCH CIRCUITRY WHERE ONLY THE CIRCUIT NUMBER IS SHOWN, CIRCUIT WIRING DEVICES OR LUMINAIRES WITH THE SAME NUMBER TO THE CIRCUIT INDICATED WITH A HOMERUN TO EACH NUMBERED GROUP. CONNECT TO A 20A-1P CIRCUIT BREAKER, OR AS NOTED. NUMERAL INDICATES PANELBOARD CIRCUIT NUMBER.

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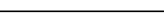

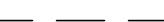
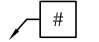

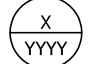
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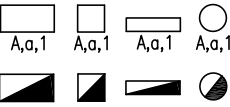



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


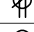
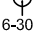







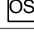
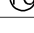



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


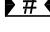

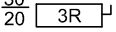

ELECTRICAL SYMBOL LEGEND

GENERAL	
	EXISTING WIRING OR EQUIPMENT (LIGHT SOLID).
	NEW WIRING OR EQUIPMENT, THIS PROJECT (HEAVY SOLID).
	EXISTING WIRING OR EQUIPMENT TO BE REMOVED, THIS PROJECT (DASHED)
	DEMOLITION KEYED DRAWING NOTE.
	NEW CONSTRUCTION KEYED DRAWING NOTE.
	DETAIL CALL OUT. "X" INDICATES DETAIL NUMBER WITHIN IDENTIFIED SHEET, "Y" INDICATES SHEET NUMBER.

LIGHTING	
	LIGHTING FIXTURE. UPPER CASE LETTER INDICATES FIXTURE TYPE AS DESCRIBED IN LUMINAIRE SCHEDULE. LOWER CASE LETTER(S) INDICATE SWITCHING. NUMBER INDICATES CIRCUIT NUMBER OF POWER SOURCE. HATCHING INDICATES AN EMERGENCY POWERED LIGHT FIXTURE.
	EMERGENCY LIGHTING UNIT CONNECTED TO UNSWITCHED LIGHTING CIRCUIT WITHIN SPACE. REFER TO LIGHTING FIXTURE SCHEDULE FOR ADDITIONAL INFORMATION.
	EXIT SIGN, ARROW(S) INDICATE DIRECTIONAL CHEVRONS. REFER TO LIGHTING FIXTURE SCHEDULE FOR ADDITIONAL INFORMATION.
	OUTDOOR WALL MOUNT FIXTURE WITH INTEGRAL PHOTOCELL CONTROL. REFER TO LIGHTING FIXTURE SCHEDULE FOR ADDITIONAL INFORMATION.

DEVICES	
	DUPLEX RECEPTACLE - UPPER CASE LETTERS INDICATE TYPE AS FOLLOWS: IG - ISOLATED GROUND AF - ARC FLASH TR - TAMPER RESISTANT SM - SURFACE MOUNTED OC - ABOVE COUNTER WP - WEATHER PROOF TVSS - TRANSIENT VOLTAGE SURGE SUPPRESSION USB - USB RECEPTACLE
	QUAD RECEPTACLE
	SWITCHED DUPLEX RECEPTACLE
	DUPLEX RECEPTACLE, GFCI TYPE.
	SPECIAL PURPOSE RECEPTACLE, TAG INDICATES NEMA CONFIGURATION.
	PUSHBUTTON-KEYED NOTES INDICATE TYPE AND FUNCTION
	TELEPHONE OUTLET, INTERCOMMUNICATION SYSTEM. "WM" INDICATES WALL MOUNTED OUTLET.
	DATA COMMUNICATIONS SYSTEM OUTLET
	TELEPHONE AND DATA OUTLET, INTERCOMMUNICATION SYSTEM
	CABLE TELEVISION OUTLET AND POWER LOCATION. REFER TO DETAIL FOR ADDITIONAL INFORMATION.
	AC LIGHTING SWITCH,UPPER CASE LETTER(S) OR NUMBER INDICATE TYPE AS FOLLOWS: 3 = THREE WAY 4 = FOUR WAY K = KEYED T = TIMER L = ILLUMINATED P= PILOT D = DIMMER LOWER CASE LETTER(S) SIGNIFY SWITCHING DESIGNATIONS. QUANTITY OF LOWER CASE LETTERS EQUALS QUANTITY OF GANGED SWITCHES.
	OCCUPANCY SENSOR, CEILING MOUNTED.
	OCCUPANCY SENSOR, WALL MOUNTED.
	PHOTOCELL.
	FIRE ALARM SYSTEM, 120V SMOKE DETECTOR; PHOTOELECTRIC TYPE UNLESS INDICATED OTHERWISE. CO = COMBINATION SMOKE DETECTOR/CARBON MONOXIDE ALARM

DISTRIBUTION AND MOTOR EQUIPMENT

	NEW BRANCH CIRCUIT PANELBOARD. REFER TO PANEL BOARD SCHEDULE.		ELECTRICAL CONNECTION. CONTRACTOR SHALL PROVIDE A COMPLETE CONNECTION INCLUDING ALL REQUIRED FITTINGS AND ACCESSORIES.
	EXISTING BRANCH CIRCUIT PANELBOARD. REFER TO PANEL BOARD SCHEDULE.		ELECTRICAL CONNECTION IDENTIFICATION TAG ASSOCIATED WITH ELECTRICAL CONNECTION SYMBOL. REFER TO ASSOCIATED ITEM NUMBER WITHIN THE EQUIPMENT CONNECTION SCHEDULE FOR ADDITIONAL INFORMATION REGARDING ELECTRICAL CONNECTION.
	ELECTRICAL MOTOR - NIC		
	DISCONNECT SWITCH, 3R INDICATES WEATHERPROOF (NEMA 3R) 30 — INDICATES SWITCH AMPERE RATING 20 — INDICATES FUSE SIZE - INDICATES NON FUSED		EQUIPMENT IDENTIFICATION TAG ASSOCIATED WITH ELECTRICAL CONNECTION SYMBOL. REFER TO EQUIPMENT CONNECTION SCHEDULE.

NOTE: ABBREVIATIONS AND SYMBOLS ON THIS DRAWING ARE FOR REFERENCE ONLY, AND MAY NOT BE USED IN THE FOLLOWING DOCUMENTS.

REVISIONS			
DATE	DESCRIPTION	BY	SYM.



TITLE OF PROJECT ADDITIONS TO MAINTAINACE SECTION	CONTRACT NUMBER: TAS 25-9A
LOCATION OF PROJECT MANCHESTER MP 340.15	DATE: 07/30/2025
TITLE OF DRAWING ELECTRICAL SYMBOLS, ABBREVIATIONS, & NOTES	DRAWING NUMBER: EG100

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DRAFTED BY:

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
BUREAU DIRECTOR: J.L. MORRIS

LIGHTING FIXTURE SCHEDULE					
TYPE	DESCRIPTION	LENS	DRIVER	LAMPS	FIXTURE WATTAGE
A	2X4 RECESSED LED FLAT PANEL LIGHTING FIXTURE FOR USE MOUNTED IN GRID CEILING. NARROW ALUMINUM BEZEL TIGHTLY HELD TO CODE GUAGE STEEL BACK PLATE WITH SEAMLESS CORNERS AND INTEGRAL GRID CLIPS. SELECTABLE LUMEN OUTPUT AND CCT. PROVIDE SURFACE MOUNTING ACCESSORIES FOR MECHANICAL SPACES AND MOUNT TO WEB TRUSSES. DLC LISTED. AS MANUFACTURED BY COOPER METALUX, 24FPS SERIES, CATALOG NUMBER 24FPSL2SCT3 OR APPROVED EQUAL.	WHITE FROST SCRATCH RESISTANT LENS.	ELECTRONIC DIMMING DRIVER.	LED, 3534 LUMENS, 3500K CCT	30
EM	LED ARCHITECTURAL BUG EYE EMERGENCY LIGHT FIXTURE WITH TEST SWITCH AND INDICATOR LAMP. INJECTION MOLDED, COLOR STABLE, HIGH IMPACT UL 94-5V RATED PLYCARBONATE HOUSING AND MOUNTING PLATE. DESIGNER WHITE TEXTURED FINISH. SEALED LEAD CALCIUM MAINTANANCE FREE, LONG LIFE, FULL RECHARGE TIME BATTERY. AS MANUFACTURED BY COOPER SURE LITES CATALOG NUMBER CU2-LED OR APPROVED EQUAL.	POLYCARBONATE	ELECTRONIC	LED	1
W	SLIM LOW PROFILE LED WALL PACK LIGHT FIXTURE. ONE-PIECE DIE-CAST ALUMINUM HINGED REMOVABLE DOOR AND BACK BOX. EXTERNAL FIN DESIGN FOR HEAT EXTRACTION AND ONE-PIECE SILICONE GASKET BETWEEN DOOR AND BACKBOX. INTEGRAL PHOTOCCELL. DLC LISTED, WET LOCATION LISTED AND IP66 RATED. AS MANUFACTURED BY COOPER LUMARK, XTOR SERIES, CATALOG NUMBER XTOR3BWPC1 OR APPROVED EQUAL.	IMPACT RESISTANT TEMPERED GLASS	ELECTRONIC	LED, 2710 LUMENS, 4000K CCT	26
X	COMMERCIAL POLYCARBONATE EXIT SIGN, SINGLE AND DOUBLE FACE. WHITE POLYCARBONATE HOUSING WITH RED LETTERING, UNIVERSAL MOUNT AND SELF DIAGNOSIS FEATURE. UL 924 COMPLIANT. AS MANUFACTURED BY COOPER SURE-LITES , LPX SERIES, CATALOG NUMBER LPX7SD90 OR APPROVED EQUAL.	N/A	INTEGRAL LED DRIVER	LED	1

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
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TITLE OF PROJECT ADDITIONS TO MAINTAINACE SECTION	CONTRACT NUMBER: TAS 25-9A
LOCATION OF PROJECT MANCHESTER MP 340.15	DATE: 07/30/2025
TITLE OF DRAWING ELECTRICAL SCHEDULES	DRAWING NUMBER: EG800

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DESIGNED BY:

BUREAU DIRECTOR: J.L. MORRIS

EQUIPMENT CONNECTION SCHEDULE

EQUIPMENT CONNECTION SCHEDULE																				
KEY	DISCONNECT TYPE			NEMA TYPE							STARTER TYPE				CONTROLS					
	A	- NON-FUSED SAFETY SWITCH		12	-	NEMA 12 (INDOOR, OIL TIGHT)			MAG	-	MAGNETIC			1	- START/STOP PUSH BUTTON W/ PILOT LIGHT IN COVER					
	B	- FUSED SAFETY SWITCH		3R	-	NEMA 3R (RAIN PROOF)			COMB	-	COMBINATION			2	- H-O-A SWITCH W/ PILOT LIGHT IN COVER					
	C	- MOTOR SWITCH		7	-	NEMA 7 (EXPLOSION PROOF)			MAN	-	MANUAL			3	- AUXILLARY CONTACTS					
	D	- MOTOR SWITCH W/ THERMAL OVERLOAD		4	-	NEMA 4 (WATERTIGHT)			RED	-	REDUCED VOLTAGE			FURNISHED BY						
E	- CORD AND PLUG		4X	-	NEMA 4X (CORROSION/WATERTIGHT)			VFD	-	VARIABLE FREQUENCY DRIVE			GC		- GENERAL CONTRACTOR					
				1	-	NEMA 1 (INDOOR, DUST TIGHT)			OTH	-	OTHER (SEE NOTES)			MECH		- DIVISION 23				
											VSC	-	VARIABLE SPEED CONTROL			PLUMB		- DIVISION 22		
															ELEC		- DIVISION 26			
ITEM NO	DESIGNATION	DESCRIPTION	LOCATION	HP	KW	AMPS	VOLTS	PH	PANEL		BREAKER SIZE (EC TO PROVIDE)	WIRE	GND	CONDUIT SIZE	DISCONNECT			NOTES		
															TYPE	NEMA TYPE	SIZE (AMPS)		FURNISHED BY	
1	CP-1	CONDENSATE PUMP	MECH. ROOM 06	1/6			120	1	PD2		20/1	2#12	#12	3/4"	C	1	20	ELEC		
2	HVAC-1	OUTDOOR AIR HANDLER	AT GRADE			45	208	3	PD2		60/3	3#4	#10	1"	A	3R	60	ELEC		
3	VAV-01	VARIABLE AIR VOLUME	BREAK ROOM 05			9	208	1			20/1	2#12	#12	3/4"	C	1	20	ELEC		
4	VAV-02	VARIABLE AIR VOLUME	BREAK ROOM 05			6	208	1			20/1	2#12	#12	3/4"	C	1	20	ELEC		
5	VAV-03	VARIABLE AIR VOLUME	BREAK ROOM 05			6	208	1			20/1	2#12	#12	3/4"	C	1	20	ELEC		
6	VAV-04	VARIABLE AIR VOLUME	BREAK ROOM 05			36.1	208	1			40/1	2#4	#10	1"	C	1	20	ELEC		
7	VAV-05	VARIABLE AIR VOLUME	BREAK ROOM 05			9	208	1			20/1	2#12	#12	3/4"	C	1	20	ELEC		
8	VAV-06	VARIABLE AIR VOLUME	BREAK ROOM 05			9	208	1			20/1	2#12	#12	3/4"	C	1	20	ELEC		
9	WH-1	WATER HEATER	MECH. ROOM 06			5	120	1	PD2		20/1	2#12	#12	3/4"	C	1	20	ELEC		
10	HOOD	RANGE HOOD	BREAK ROOM 05			7.5	120	1	PD2		20/1	2#12	#12	3/4"	C	1	20	ELEC		
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
GENERAL CONSTRUCTION NOTES:

- A. IT IS THE CONTRACTORS RESPONSIBILITY TO EXAMINE ALL DRAWINGS AND SPECIFICATIONS AND COORDINATE WORK WITH ALL OTHER DISCIPLINES.
- B. CONTRACTOR SHALL COORDINATE WITH THE MECHANICAL CONTRACTOR FOR ALL POWER CONNECTIONS AND FINAL EQUIPMENT. REFER TO EQUIPMENT CONNECTION SCHEDULE.
- C. ALL CIRCUITS INDICATED SHALL BE POWERED FROM AND TERMINATED AT EXISTING TO REMAIN PANELS.
- D. REUSE EXISTING LIGHTING CIRCUITS.
- E. ALL NEW CIRCUIT BREAKERS SHALL MATCH THE INTERRUPTING CURRENT RATING OF EXISTING CIRCUIT BREAKER PANELS.

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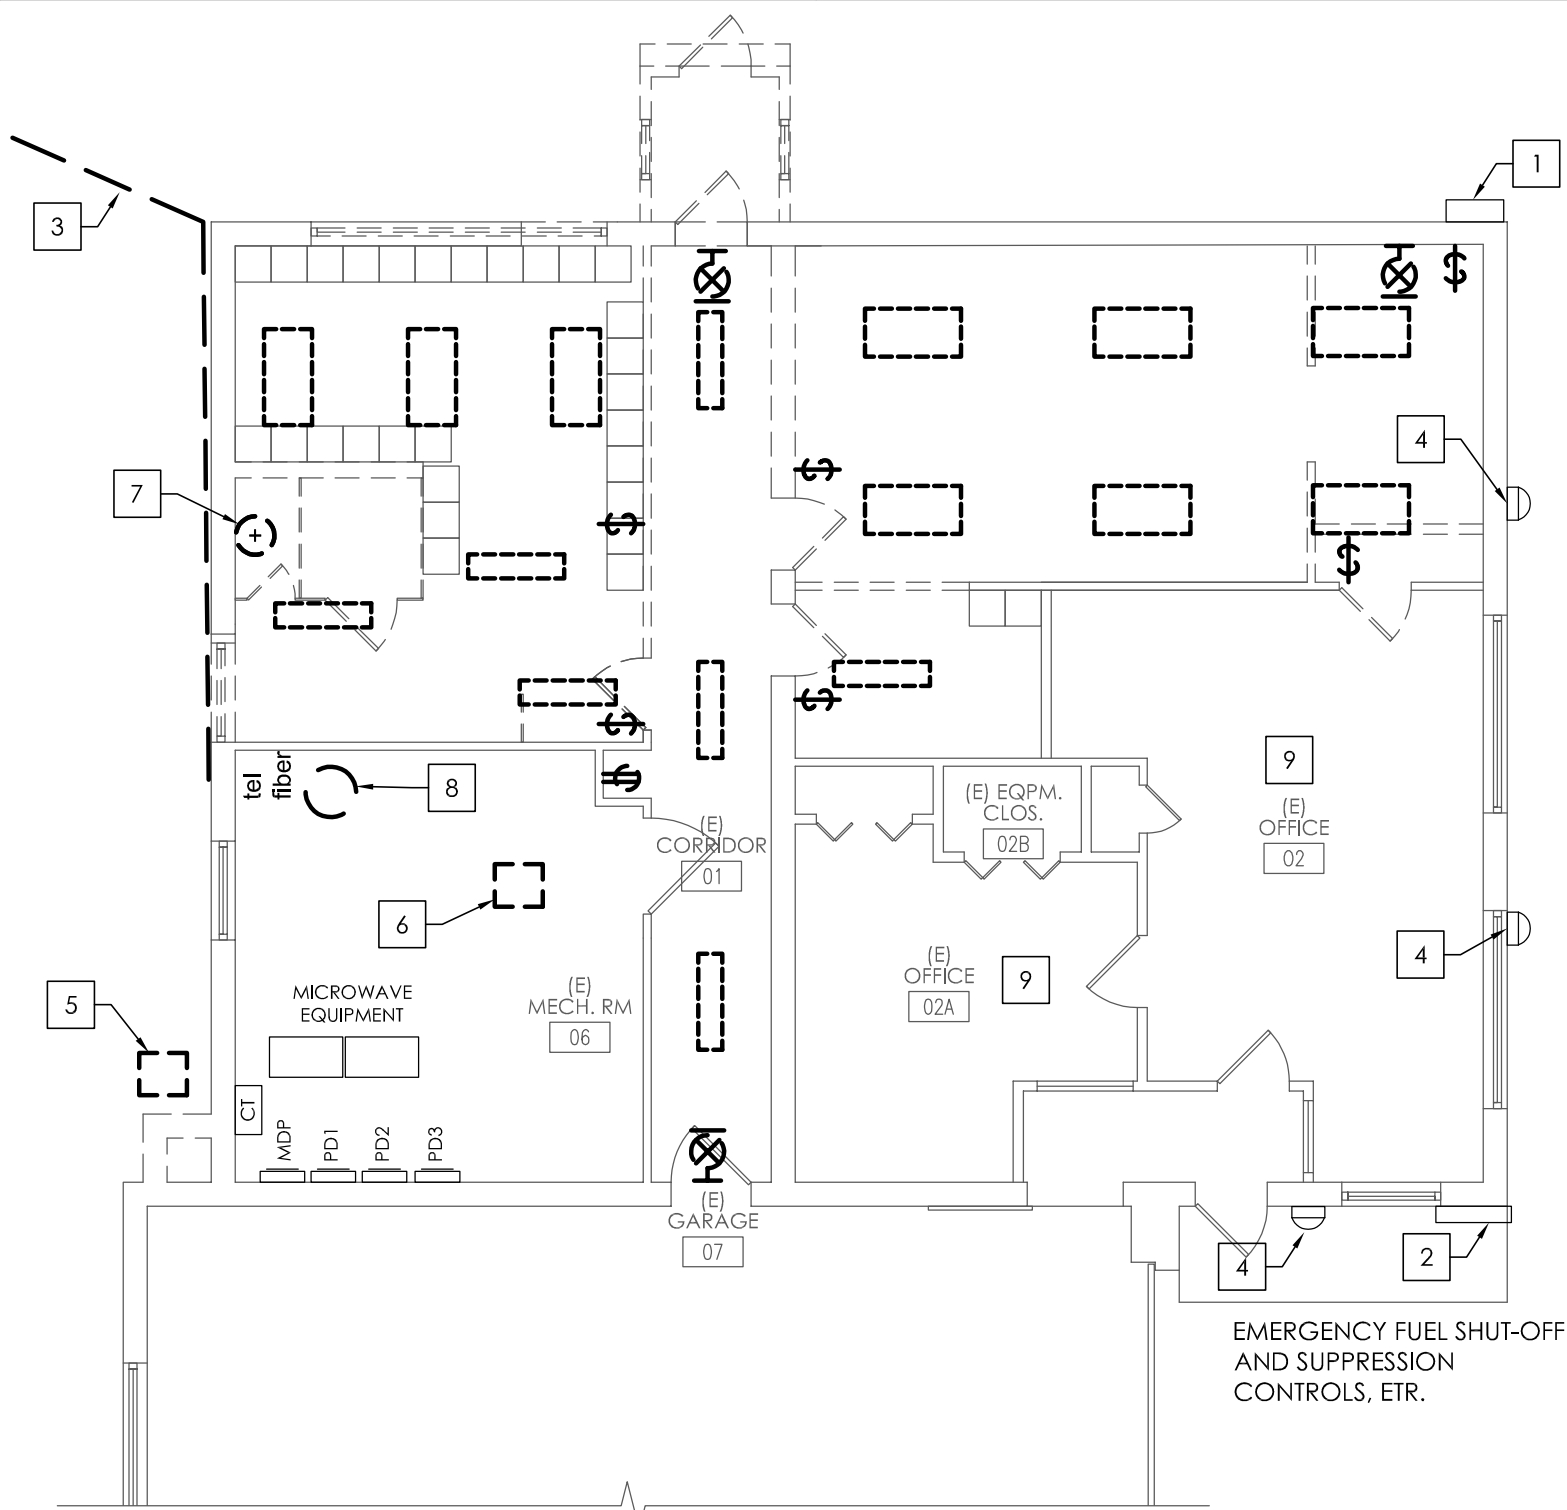
TITLE OF PROJECT ADDITIONS TO MAINTAINACE SECTION	CONTRACT NUMBER: TAS 25-9A
LOCATION OF PROJECT MANCHESTER MP 340.15	DATE: 07/30/2025
TITLE OF DRAWING ELECTRICAL SCHEDULES	DRAWING NUMBER: EG801

GENERAL DEMOLITION NOTES:

- A. REMOVE ALL LIGHTING FIXTURES AND CONTROLS ALONG WITH PATHWAY AND WIRING BACK TO SOURCE. REUSE EXISTING CIRCUITS IN ETR PANELBOARDS FOR NEW LOCATIONS. MAINTAIN ALL DOWNSTREAM DEVICES.
- B. REMOVE ALL WIRING DEVICES ALONG WITH PATHWAY AND WIRING BACK TO SOURCE. REUSE EXISTING CIRCUITS IN ETR PANELBOARDS FOR NEW DEVICES. MAINTAIN ALL DOWNSTREAM DEVICES.
- C. COORDINATE WITH OWNER IT DEPARTMENT TO REMOVE, STORE, AND RELOCATE DATA NETWORK EQUIPMENT IF INSIDE CONSTRUCTION AREA.
- D. REMOVE ALL ELECTRICAL CONNECTIONS ALONG WITH PATHWAY AND WIRING BACK TO SOURCE FOR ALL MECHANICAL EQUIPMENT BEING REMOVED. COORDINATE REMOVALS WITH MECHANICAL CONTRACTOR. MAINTAIN ALL DOWNSTREAM DEVICES. REUSE EXISTING CIRCUITS FOR NEW EQUIPMENT.
- E. DO NOT DISTURB EMERGENCY FUEL SHUT-OFF AND SUPPRESSION SYSTEM CONTROLS.
- F. DO NOT DISTURB THE AUTHORITY'S FIBER OPTIC NETWORK TRUNK COMPONENTS.
- G. PROVIDE TEMPORARY SERVICE TO BUILDING AS REQUIRED.
- H. PROVIDE TEMPORARY POWER AND LIGHTING FOR CONSTRUCTION AREAS.

KEYED DEMOLITION NOTES: #

- 1. EXISTING FIBER OPTIC PULL BOX TO REMAIN. MAINTAIN FACILITY NETWORK CONNECTION AND EXISTING FIBER BACKBONE CABLING IN PLACE THROUGHOUT CONSTRUCTION.
- 2. EXISTING TO REMAIN EMERGENCY FUEL SHUT-OFF AND SUPPRESSION SYSTEM CONTROLS. MAINTAIN OPERATION OF SYSTEM THROUGHOUT CONSTRUCTION.
- 3. DISCONNECT EXISTING SERVICE LATERAL BACK TO SERVICE POLE. COORDINATE ALL ASPECTS OF INSTALLATION WITH UTILITY PRIOR TO PERFORMING WORK.
- 4. DISCONNECT AND REMOVE EXTERIOR LIGHT FIXTURE. EXISTING CABLING TO REMAIN FOR REUSE.
- 5. DISCONNECT AND REMOVE CABLING TO CONDENSING UNIT. REMOVE ALL CONDUIT, CABLE AND ASSOCIATED HARDWARE BACK TO SOURCE.
- 6. DISCONNECT AND REMOVE CABLING TO FURNACE. REMOVE ALL CONDUIT, CABLE AND ASSOCIATED HARDWARE BACK TO SOURCE.
- 7. DISCONNECT AND REMOVE CABLING TO EXHAUST FAN. REMOVE ALL CONDUIT, CABLE AND ASSOCIATED HARDWARE BACK TO SOURCE.
- 8. DISCONNECT AND REMOVE CABLING TO WATER HEATER. REMOVE ALL CONDUIT, CABLE AND ASSOCIATED HARDWARE BACK TO SOURCE.
- 9. DISCONNECT AND REMOVE TEMPORARY SUPPORT LIGHTING AND CEILING MOUNTED DEVICES. EXISTING CABLING TO REMAIN FOR REUSE. DEVICES TO BE REINSTALLED. SEE DRAWING E102 FOR MORE INFORMATION.



1 FIRST FLOOR ELECTRICAL DEMOLITION PLAN
SCALE: 1/8"=1'-0"

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TITLE OF PROJECT ADDITIONS TO MAINTAINACE SECTION	CONTRACT NUMBER: TAS 25-9A
LOCATION OF PROJECT MANCHESTER MP 340.15	DATE: 07/30/2025
TITLE OF DRAWING FIRST FLOOR ELECTRICAL DEMOLITION PLAN	DRAWING NUMBER: ED101

1. PROVIDE NEW SERVICE LATERAL, SECURE TO BUILDING WITH STAINLESS STEEL HARDWARE. COORDINATE ADDITIONAL REQUIREMENTS WITH UTILITY. THE CONTRACTOR SHALL PAY ALL ADDITIONAL COSTS TO THE UTILITY COMPANY FOR CONNECTIONS. (PROPOSED ROUTING SHOWN)
2. DISCONNECT POWER TO EXISTING OVERHEAD DOOR OPERATOR TO ALLOW REPLACEMENT BY OTHERS. RECONNECT EXISTING POWER TO NEW DOOR OPERATOR AFTER INSTALLATION. EXTEND EXISTING CONDUIT AND CABLING AS REQUIRED. COORDINATE WITH OWNER AND ARCHITECT PRIOR TO PERFORMING WORK.


SCALE: 1/16"=1'-0"

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TITLE OF PROJECT ADDITIONS TO MAINTAINANCE SECTION	CONTRACT NUMBER: TAS 25-9A
LOCATION OF PROJECT MANCHESTER MP 340.15	DATE: 07/30/2025
TITLE OF DRAWING FIRST FLOOR ELECTRICAL PLAN	DRAWING NUMBER: E101



1 FIRST FLOOR ELECTRICAL PLAN
SCALE: 1/8"=1'-0"

GENERAL CONSTRUCTION NOTES:

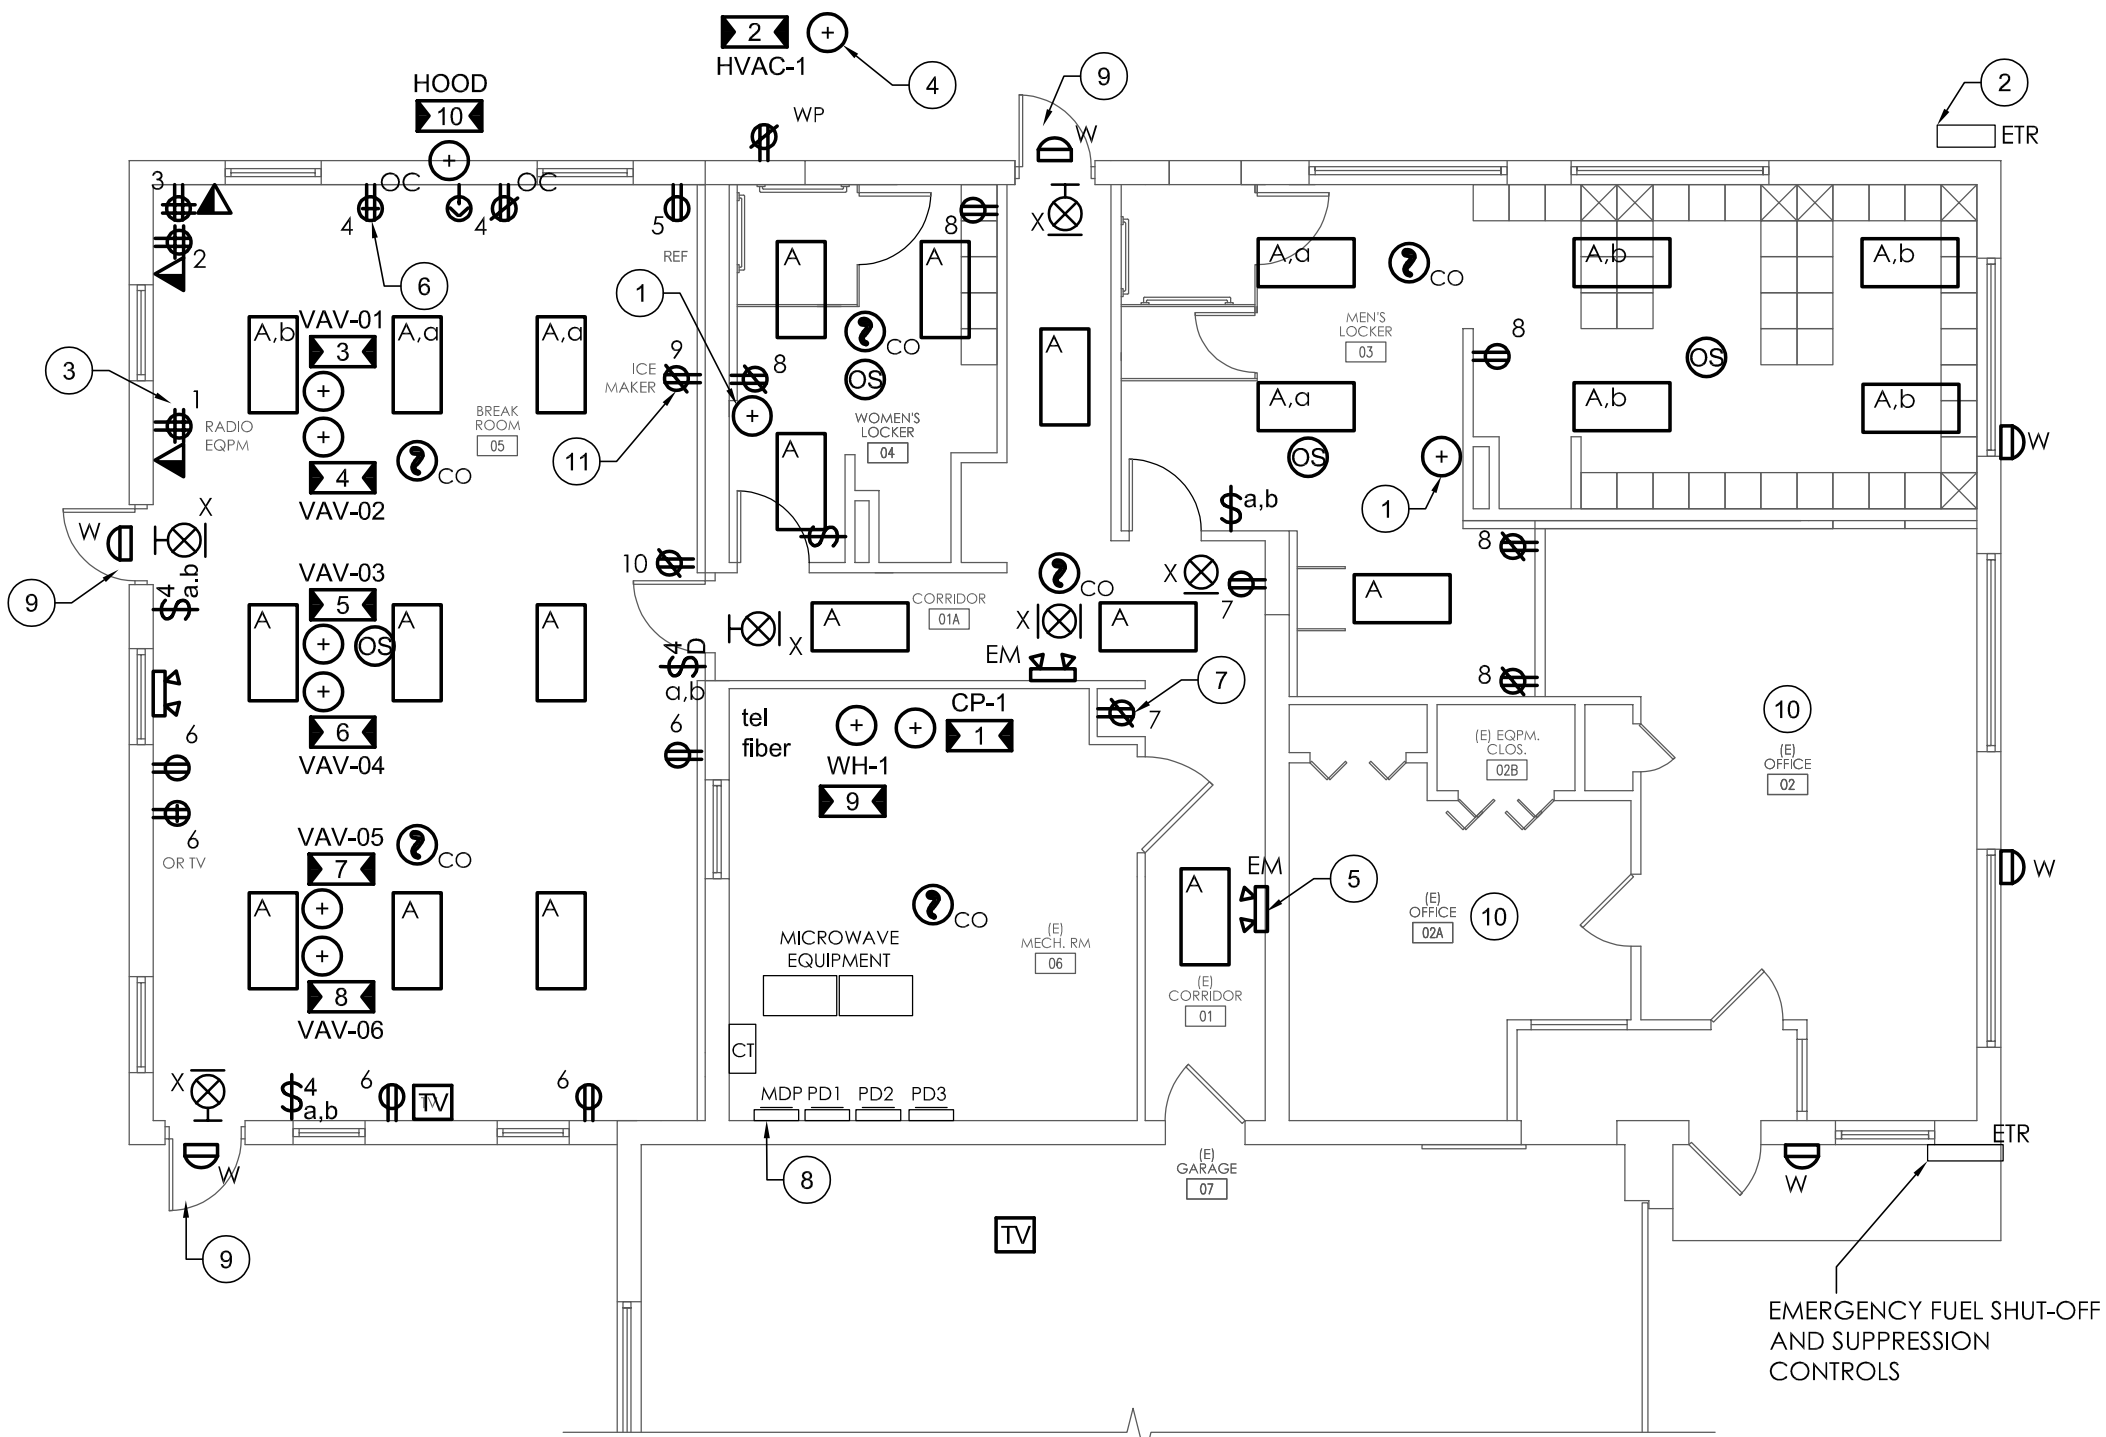- IT IS THE CONTRACTORS RESPONSIBILITY TO EXAMINE ALL DRAWINGS AND SPECIFICATIONS AND COORDINATE WORK WITH ALL OTHER DISCIPLINES.
- CONTRACTOR SHALL COORDINATE WITH THE MECHANICAL CONTRACTOR FOR ALL POWER CONNECTIONS AND FINAL EQUIPMENT. REFER TO EQUIPMENT CONNECTION SCHEDULE.
- ALL CIRCUITS INDICATED SHALL BE POWERED FROM AND TERMINATED AT EXISTING TO REMAIN PANELS.
- REUSE EXISTING LIGHTING CIRCUITS.
- ALL NEW CIRCUIT BREAKER SHALL MATCH THE INTERRUPTING CURRENT RATING OF EXISTING CIRCUIT BREAKER PANELS.
- WIRE ALL SMOKE/CARBON MONOXIDE DETECTORS TOGETHER WITH (2) # 12, #12 GND. IN 3/4" CONDUIT. INSTALL A DEDICATED 20/1 BREAKER FOR CIRCUIT IN AVAILABLE PANEL SPACE.

KEYED CONSTRUCTION NOTES:

- PROVIDE CONNECTION TO HAND DRYER BY OTHERS FROM PANEL PD2.
- DO NOT DISTURB FIBER OPTIC PULL BOX OR UNDERGROUND CONDUITS.
- RELOCATE RADIO AND TEL/DATA EQUIPMENT FROM EXISTING BREAK ROOM. REROUTE AND RECONNECT EXISTING CABLING AS REQUIRED.
- PROVIDE CONNECTIONS TO HVAC EQUIPMENT BY OTHERS. COORDINATE PENETRATION AND EXACT LOCATION WITH DIV. 23.
- MOUNT EMERGENCY LIGHT FIXTURE AT 7' A.F.F. TIE INTO UNSWITCHED PORTION OF LIGHTING CIRCUIT FEEDING THE AREA THE EM LIGHT IS INSTALLED. TYPICAL FOR ALL EM LIGHT FIXTURES.
- RECEPTACLE FOR USE WITH MICROWAVE. COORDINATE LOCATION OF DEVICE WITH REQUIREMENTS OF MICROWAVE MANUFACTURER.
- RECEPTACLE FOR USE WITH WATER COOLER. COORDINATE LOCATION OF DEVICE WITH REQUIREMENTS OF WATER COOLER MANUFACTURER.
- DISCONNECT AND REMOVE EXISTING 400 AMP MAIN BREAKER. REPLACE WITH A 600 AMP MAIN BREAKER. BREAKER TO BE SERVICE ENTRANCE RATED. COORDINATE NEW BREAKER INTERRUPTING CURRENT WITH EXISTING PANEL.
- INCORPORATE EXTERIOR DOOR IN TO EXISTING LENEL ACCESS CONTROL SYSTEM. PROVIDE IDENTICAL HARDWARE AS EXISTING EXTERIOR DOORS. PROVIDE POWER AND CONTROL CABLING AS REQUIRED.
- REINSTALL TEMPORARY SUPPORT LIGHTS AND CEILING MOUNTED DEVICES THAT WERE DISCONNECTED DURING DEMOLITION. RECONNECT EXISTING CABLING AS REQUIRED.
- RECEPTACLE FOR USE WITH ICE MAKER. PROVIDE A DEDICATED CIRCUIT.

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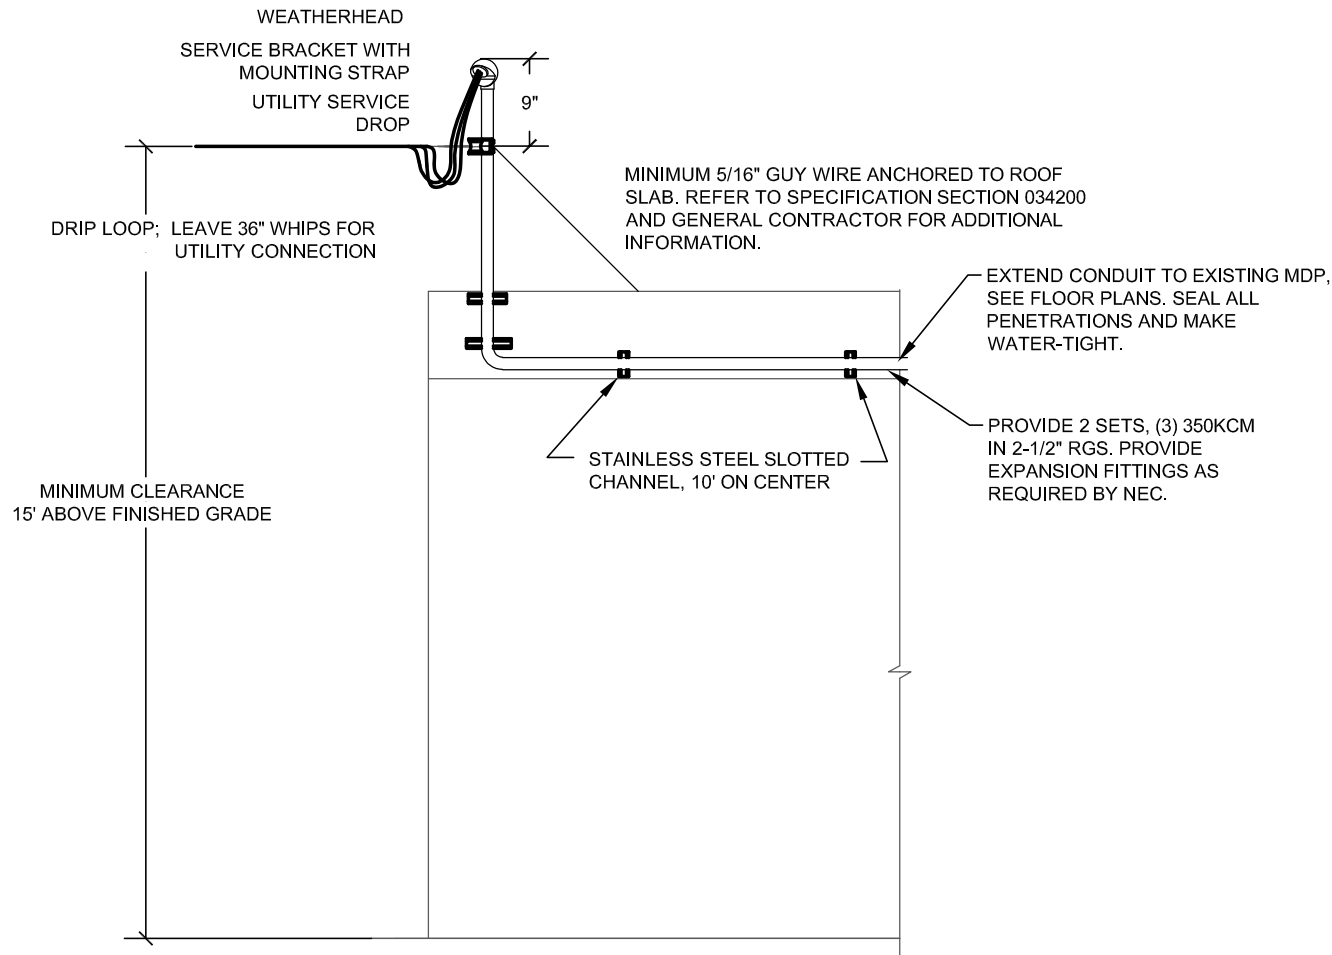
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DATE	DESCRIPTION	BY	SYM.

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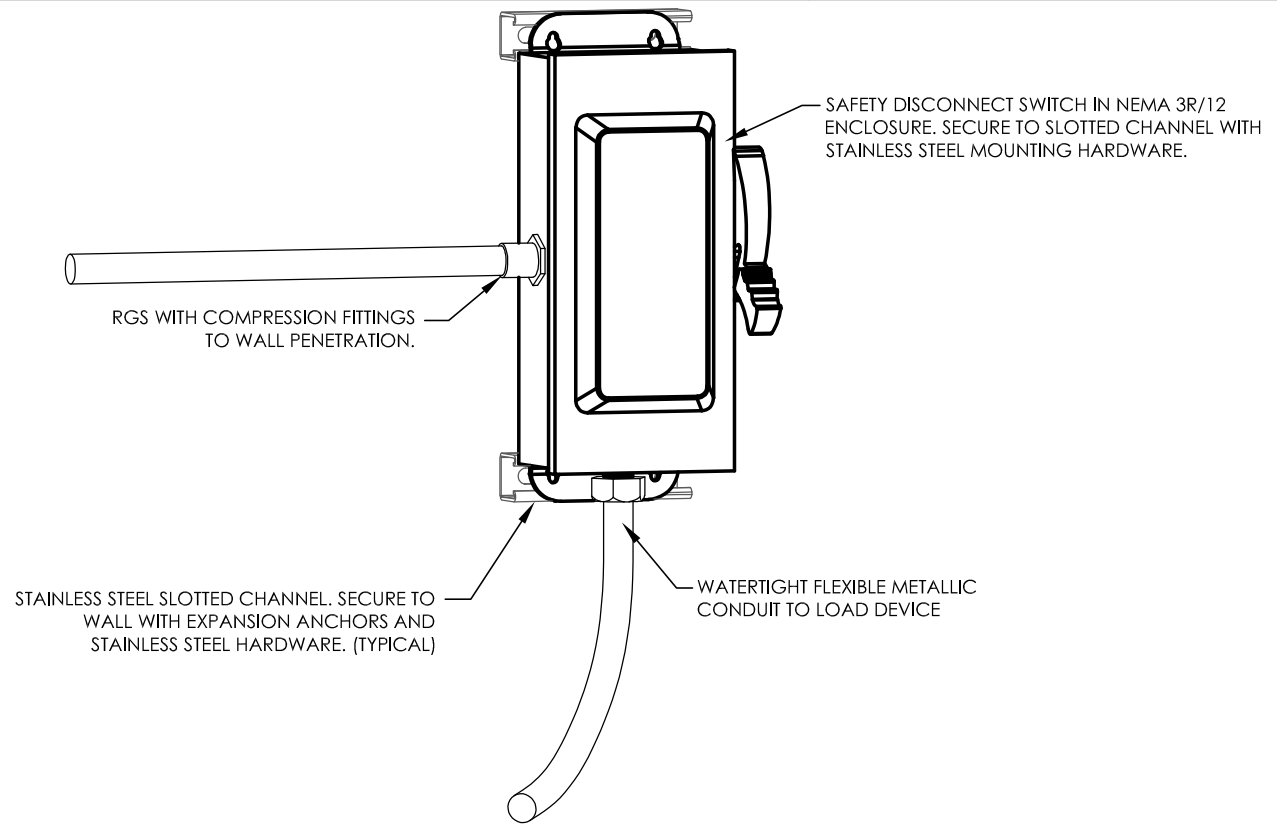
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TITLE OF PROJECT ADDITIONS TO MAINTAINACE SECTION	CONTRACT NUMBER: TAS 25-9A
LOCATION OF PROJECT MANCHESTER MP 340.15	DATE: 07/30/2025
TITLE OF DRAWING FIRST FLOOR ELECTRICAL PLAN	DRAWING NUMBER: E102

CHECKED BY: DRAFTED BY: DESIGNED BY: J.L. MORRIS BUREAU DIRECTOR:



1 SERVICE LATERAL INSTALLATION DETAIL
SCALE: N.T.S.



DETAIL GENERAL NOTES:

- A. REFER TO FLOOR PLANS AND SCHEDULES FOR EXACT LOCATIONS AND DISCONNECT RATINGS.
- B. COORDINATE WITH DIVISION 23 FOR ADDITIONAL WIRING REQUIREMENTS.
- C. SECURE BRANCH CIRCUIT CONDUITS TO WALL WITHIN 12" OF ENCLOSURE AND AT 36" INTERVALS TO PENETRATION DEVICE.
- D. MOUNT ON WALL 36" AFG TO BOTTOM OF ENCLOSURE.

2 OUTDOOR SAFETY SWITCH DETAIL
NTS

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TITLE OF PROJECT ADDITIONS TO MAINTAINACE SECTION	CONTRACT NUMBER: TAS 25-9A
LOCATION OF PROJECT MANCHESTER MP 340.15	DATE: 07/30/2025
TITLE OF DRAWING ELECTRICAL DETAILS	DRAWING NUMBER: E501