

## **BUFFALO DIVISION PLANS FOR**


1R MILL AND INLAY, SAFETY IMPROVEMENTS

AND MISCELLANEOUS WORK ON I-90 5511929 - MP 418.98 - I-90 OVER WEHRLE DR. 5511919 - MP 418.73 - I-90 OVER ELLICOTT CREEK 5512160 - MP 417.27 - EXIT 49 RAMP OVER I-90 5030279 - MP 416.94 - I-90 OVER NY ROUTE 78 (TRANSIT RD.)

**FROM** MILEPOST 416.90 TO 419.40

**ERIE COUNTY** 

TAB 25-31 D214980 58 SHEETS BIN's 5030279 5511919 5511929 5512160 CIN 417.6301XX

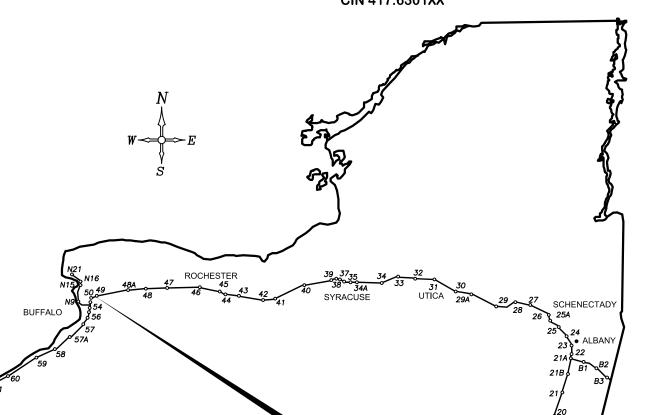

## CONTRACTOR'S NAME: AWARD DATE: COMPLETION DATE: FINAL ACCEPTANCE DATE: INSPECTION FIRM'S NAME: RESIDENT ENG./EIC: .. FINAL COST TOTAL: FISCAL SHARE

CINS:

417.6301XX - MP 417.63

Matthew M. Latko

SITE OF WORK-

KINGSTON

09/05/2025

## TYPE OF CONSTRUCTION:

1R PAVEMENT RESURFACING, SAFETY IMPROVEMENTS, AND MISC. WORK

## STANDARD SHEETS:

THE LATEST REVISIONS OF THE STANDARD SHEETS MAINTAINED BY NYSDOT, WHICH ARE CURRENT AS OF THE STANDARD SPECIFICATIONS ADOPTION DATE SHOWN ON THE PROPOSAL COVER SHALL BE CONSIDERED TO BE IN EFFECT. ALL PAY ITEMS AND WORK CONTAINED IN THE CONTRACT AND ANY ADDITIONAL PAY ITEMS AND WORK ENCOUNTERED DURING THE COURSE OF THE CONTRACT SHALL BE SUBJECT TO THE APPLICABLE STANDARD SHEET(S) UNLESS OTHERWISE SPECIFIED IN THE CONTRACT DOCUMENTS

THE LATEST REVISIONS OF THE NYSTA STANDARD SHEETS MAINTAINED BY THE AUTHORITY, WHICH ARE CURRENT ON THE DATE OF ADVERTISEMENT FOR BIDS, SHALL BE CONSIDERED TO BE IN EFFECT. ALL PAY ITEMS AND WORK CONTAINED IN THE CONTRACT AND ANY ADDITIONAL PAY ITEMS AND WORK ENCOUNTERED DURING THE COURSE OF THE CONTRACT SHALL BE SUBJECT TO THE APPLICABLE STANDARD SHEET(S) LISTED ON DWG. SS-1 UNLESS OTHERWISE SPECIFIED IN THE CONTRACT DOCUMENTS.

## NOTES:

ALL WORK CONTEMPLATED UNDER THIS CONTRACT IS TO BE COVERED BY AND IN CONFORMITY WITH THE STANDARD SPECIFICATIONS (US CUSTOMARY) REFERENCED IN THE CONTRACT "PROPOSAL" EXCEPT AS MODIFIED BY THESE PLANS OR CHANGES SET FORTH IN THE CONTRACT "PROPOSAL".

> UDIG NEW YORK ACILITIES PROTECTION ORGANIZATION **CALL 811**

**TAB 25-31** 

D'XING DITCH CROSSING
EHW EXTREME HIGH WATER EL ELEVATION ELEV ELEVATION
ELW EXTREME LOW WATER ES END SECTION HW HEADWALL INV INVERT MH MANHOLE MHW MEAN HIGH WATER OHW ORDINARY HIGH WATER OLW ORDINARY LOW WATER RCP REINFORCED CONCRETE PIPE
SICPP SMOOTH INTERIOR CORRUGATED POLYETHYLENE PIPE TB TOP OF BANK (STREAM) TC TOP OF CURB TG TOP OF GRATE VCP VITRIFIED CLAY PIPE

ST				D	DAM						
ST											
_	W SIDEWALK			K	CUL VE						
_		TEMPORARY EASEMENT									
T	0 TEMPORARY	OCCUPANCY		Х	TO BE						
U/	G UNDERGROUN	D			BE DE						
W	W   WING WALL				IS MAI						
	STANDARD Symbol (Plans)	ITEM PAYMENT UNIT: ESTIMATE OF QUANTITIES SHEET	NOME	/ALENT NCLATURE: S/PROPOS/							
	н	-	INCHE	S							
	,	LF	LINEA	R FEET							
	mi	MI	MILES								
	f†²	SF	SQUAR	E FEET							
	YD <sup>2</sup>	SY	SQUAF	RE YARD							
	AC	AC	ACRES	5							
	YD3	CY	CUBIC	YARD							
	GAL	GAL	GALLO	N	·						
	lb	LB	POUND								
	TON	TON	TON								

	ALIGNMENT		TOPOGRAPHY (MISCELLANEOUS)		UTILITIES
ABBR.	DESCRIPTION	ABBR.	DESCRIPTION	ABBR.	DESCRIPTION
AH	AHEAD	ABUT	ABUTMENT	E	ELECTRIC
ΑZ	AZIMUTH	AOBE	AS ORDERED BY ENGINEER	EMH	ELECTRIC MANHOLE
BK	BACK	ASPH	ASPHALT	G	GAS
Æ	BASELINE	BDY	BOUNDARY	GP	GUY POLE
BRG	BEARING	BLDG	BUILDING	GSB	GAS SERVICE BOX (HOUSE LINE)
Ç	CENTERLINE	ВМ	BENCH MARK	GV	GAS VALVE (MAIN LINE)
CS	CURVE TO SPIRAL	cc	CENTER TO CENTER	HYD	HYDRANT
е	SUPERELEVATION RATE (CROSS SLOPE)	CONC	CONCRETE	LP	LIGHT POLE
EQ	EQUALITY	CONST	CONSTRUCTION	LPG	LOW PRESSURE GAS
EXT	EXTERNAL	CR	COUNTY ROAD	PP	POWER POLE
HCL	HORIZONTAL CONTROL LINE	D	DEED DISTANCE	SA	SANITARY SEWER
HSD	HEADLIGHT SIGHT DISTANCE	DM	DIRECT MEASUREMENT	SMH	SANITARY MANHOLE
L	LENGTH OF CIRCULAR CURVE	DWY	DRIVEWAY	ST	STORM SEWER
LS	LENGTH OF SPIRAL	EP	EDGE OF PAVEMENT	Ť	TELEPHONE
LVC	LENGTH OF VERTICAL CURVE	ES	EDGE OF SHOULDER	TCB	TRAFFIC CONTROL BOX
E	CENTER CORRECTION OF VERTICAL CURVE	FEE	FEE ACQUISITION	TELBOX	TELEPHONE BOX
₩	MAIN LINE	FEE WO/A	FEE ACQUISITION WITHOUT ACCESS	TEL P	TELEPHONE POLE
PC	POINT OF CURVATURE	FP FP	FENCE POST	TMH	TELEPHONE MANHOLE
PI	POINT OF INTERSECTION	FD	FOUNDATION	CTV	CABLE TELEVISION
POL	POINT ON LINE	FL	FENCE LINE	W	WATER
PSD	PASSING SIGHT DISTANCE	GAR	GARAGE	WSB	WATER SERVICE BOX (HOUSE LINE)
PT	POINT OF TANGENT	GR	GRAVEL	WV	WATER VALVE (MAIN LINE)
PVC	POINT OF VERTICAL CURVE	HO	HOUSE		
PVI	POINT OF VERTICAL INTERSECTION	HWY	HIGHWAY		SUBSURFACE EXPLORATION
PVT	POINT OF VERTICAL TANGENT	IP	IRON PIN OR IRON PIPE	ABBR.	DESCRIPTION
R	RADIUS	MB	MAILBOX		
SC	SPIRAL TO CURVE	MON	MONUMENT	REP	LACE ABBREVIATION "AB" WITH:
SSD	STOPPING SIGHT DISTANCE	N&W	NAIL AND WASHER	AH	HAND AUGER
ST	SPIRAL TO TANGENT	0G	ORIGINAL GROUND	CP	CONE PENTROMETER
STA	STATION	0/H	OVERHEAD	DA	21/4 INCHES CASED DRILL HOLE
T	TANGENT LENGTH	U/II	PARCEL	DM	DRILLING MUD
TGL	THEORETICAL GRADE LINE	PAV'T	PAVEMENT	DN	4 INCHES CASED DRILL HOLE
TS	TANGENT TO SPIRAL	PE	PERMANENT EASEMENT	FH	HOLLOW FLIGHT AUGER
VC	VERTICAL CURVE	PED POLE	PEDESTRIAN POLE	PA	POWER AUGER
٧C			PROPERTY LINE	PH	PROBE
	TOPOGRAPHY (DRAINAGE)	POR P	PORCH	PT	PERCOLATION TEST HOLE
ADDD	DECEDITION	RR	RAILROAD	RP	1 INCH SAMPLER (RETRACTABLE PLUG)
ABBR.	DESCRIPTION	RTE	ROUTE	- '''	TO BE DEFINED AT THE TIME OF EXPLORATION
BB	BOTTOM OF BANK (STREAM)	$\overline{}$	RIGHT OF WAY	SP	SEISMIC POINT
BC	BOTTOM OF CURB	ROW		TP	TEST PIT
В0	BOTTOM OF OPENING	RW	RETAINING WALL		ATION "C" IN CATEGORIES:
CAP	CORRUGATED ALUMINUM PIPE	SH	STATE HIGHWAY SHOULDER		DN, AND FH WITH:
CB	CATCH BASIN	SHLDR SPK	SPIKE		
CIP	CAST IRON PIPE	$\overline{}$	STREET	В	BRIDGE
© STRM	CENTERLINE OF STREAM	ST		С	CUT
CMP	CORRUGATED METAL PIPE	STK	STAKE	D	DAM
CP	CONCRETE PIPE	STY	STORY SIDE WALK	F	FILL
CSP	CORRUGATED STEEL PIPE	SW		K	CULVERT
CULV	CULVERT	TE	TEMPORARY EASEMENT	W	WALL
DIA	DIAMETER	TO	TEMPORARY OCCUPANCY	Х	TO BE USED IF ONE OF THE ABOVE CANNOT BE DEFINED AT THE TIME THE EXPLORATION
DMH	DRAINAGE MANHOLE	U/G	UNDERGROUND		BE DEFINED AT THE TIME THE EXPLORATION  IS MADE
DS	DRAINAGE STRUCTURE PIPE	<u> </u>	WING WALL		19 MUDE
D'XING	DITCH CROSSING				

	INDEX	TOTAL NUMBER OF SH	HEETS 58				
SHEET NUMBER	DESCRIPTION		DRAWING NUMBER				
1	TITLE SHEET		COVER				
2	INDEX AND ABBREVIATIONS		INDEX				
3-4	LEGEND, LINE AND POINT SYMBOLOGY		LEG-1 TO LEG-2				
5-12	TYPICAL SECTIONS		TYP-1 TO TYP-8				
13	PROJECT MILEPOST DIAGRAM		PMD-1				
14	STANDARD SHEET		SS-1				
15-16	GENERAL NOTES		GNN-1 TO GNN-2				
17-18	TRAFFIC CONTROL NOTES		TCN-1 TO TCN-2				
19-21	MISCELLANEOUS TABLES		MST-1 TO MST-3				
22-31	MISCELLANEOUS DETAILS		DTL-1 TO DTL-6				
32-41	WORK ZONE TRAFFIC CONTROL DETAILS		WZD-1 TO WZD-4A				
42-44	DRAINAGE TABLES		DRT-1 TO DRT-3				
45-46	CULVERT DETAILS		CUL-1 TO CUL-2				
47-58	GENERAL PLANS		GNP-1 TO GNP-12				

NEW YORK STATE Authority

TITLE OF PROJECT
1R MILL AND INLAY, SAFETY IMPROVEMENTS,
AND MISC. WORK

INDEX AND ABBREVIATION

LOCATION OF PROJECT MP 416.90 TO MP 419.40

TITLE OF DRAWING

TAB 25-31

08/20/25

INDEX



STYLE	NAME	DESCRIPTION	STYLE	NAME	DESCRIPTION	STYLE	NAME	DESCRIPTION		TWZBT_P	BARRIER, TEMPORARY
	AC	CONTROL (CENTERLINE)	~~~~~	LABL	AREA, BRUSH LINE	сz	RCZ_P	CLEAR ZONE		TWZBTWL_F	BARRIER, TEMPORARY, W/ WARNING LIGHTS
	AD_P	DETOUR		LAHR	AREA, HEDGE ROW	$-\!$	RG	GUIDE RAIL, MISCELLANEOUS		TWZCD_P	CHANNELIZING DEVICE
	AT_P	TRANSITION CONTROL	~~~~~~~	LAPB	AREA, PLANTING BED		RGB	GUIDE RAIL, BOX BEAM	111111111	TWZPMRC_P	PAVEMENT MARKING REMOVAL OR COVERING
	BRIDGE		(XXXX)	LAWA	AREA, WOODED AREA OUTLINE		RGBM	GUIDE RAIL, BOX BEAM, MEDIAN		UTILITIE	•
	BR	RAIL		LAWE	AREA, WATERS EDGE	——————————————————————————————————————	RGC	GUIDE RAIL, CABLE	STYLE	NAME	DESCRIPTION
	BSHT	SHEET PILING		LCUT_P	CUT LIMIT		RGCB	GUIDE RAIL, CONCRETE BARRIER	c	UC	CONDUIT, UNDERGROUND
3 0 0 0	CONTRO			LFILL_P	FILL LIMIT	0 0	RGP_P	GUIDE POST	—— ]c[——	UCH	CONDUIT, HANGING
R	СВ	BASELINE		LFNC	FENCE	——————————————————————————————————————	RGW	GUIDE RAIL, W BEAM	oc	UCO	CONDUIT, OVERHEAD
<u> </u>	CBPR	BASELINE, PROJECTION	****	LTRC	TREE ROW, CONIFEROUS		RGWM	GUIDE RAIL, W BEAM, MEDIAN	—— E ——	UE	ELECTRIC LINE, UNDERGROUND
	DRAINAG		00000000000	LTRD	TREE ROW, DECIDUOUS		RPB	PARKING BUMPER	—— ]£[ ——	UEH	ELECTRIC LINE, HANGING
ST	DCP	CULVERT PIPE	I I I	LWH	WALL, H PILE		RRC	RAIL ROAD, CATENARY	——— OE ———	UE0	ELECTRIC LINE, OVERHEAD
				LWR	WALL, RETAINING		RRER	RAIL ROAD, 3RD RAIL		UET0	ELECTRIC TRANSMISSION, OVERHEAD
	DCP_P	CULVERT PIPE (DIR)		LWS	WALL, STONE	-1-1-1-1-1-1-1			<del>* * * * *</del>	UESS	ELECTRIC, SUBSTATIONS
	DDG_P	DITCH, GRASS LINED		OW MAPE	ļ	<del>                                      </del>	RRPLS_P	RAIL, PHOTO, LARGE SCALE	—— F0 ——	UF0	FIBER OPTIC, UNDERGROUND
* *	DDP_P	DITCH, PAVED INVERT					RRPSS	RAIL, PHOTO, SMALL SCALE	——]F0[——	UFOH	FIBER OPTIC, HANGING
	55/ 2/	DITON, TAVED INTENT		MDL	DEED LINE		DDC			UF00	FIBER OPTIC, OVERHEAD
***	DDS_P	DITCH, STONE LINED	- — PE —	MEE	EASEMENT, EXISTING		RRS	RUMBLE STRIP	G	UG	GAS, UNDERGROUND
	DFL_P	FLOW LINE	- —— PE —— -	MEP_P	EASEMENT, PERMANENT	<del>                                      </del>	RRSLS_P		——— ]c[ ———	UGH	GAS, HANGING
	DSSD	SLOTTED DRAIN	- ——APE—— -	MEPA_P	EASEMENT, PERMANENT, APPROX.		RRSSS	RAIL, SURVEY, SMALL SCALE	OG	UG0	GAS, OVERHEAD
	DUD_P	UNDERDRAIN	- — TE — -	MET_P	EASEMENT, TEMPORARY		SIGNS	1		UIC	INFORM CABLE, UNDERGROUND
	IVIRONME		- ——ATE—— -	META_P	EASEMENT. TEMPORARY, APPROX.	<del>•                                    </del>	SBLB	BILLBOARDS	——— ] <i>IC</i> [———	UICH	INFORM CABLE, HANGING
	EBLHS	BALE, STRAW	—— FEE ——	MF_P	FEE ACQUISITION, W/ ACCESS	Φ Φ	SM	MULTIPLE POST	o	UO	OIL LINE, UNDERGROUND
			——— AFEE ———	MFA_P	FEE ACQUISITION, APPROXIMATE	©====================================	SS0	STRUCTURE, OVERHEAD	<u> </u>	UOH	OIL LINE, HANGING
	ECT	CURTAIN, TURBIDITY		MFS_P	FEE ACQUISITION, SHAPE	0	SSOC	STRUCTURE, OVHD. CANTILEVER	<b>.</b>	UPBP	POLE, BRACE, PUSH BRACE
	EDMC	DAM, COFFER	FEE W/OA	MFW0A_P	FEE ACQUISITION, W/O ACCESS		STRIPIN	IG	<b></b>	UPGW	POLE, GUY WIRE
	EDMEC_P	DAM, EARTHEN CHECK		МНА	HISTORICAL, ACQUISITION		STB*	BROKEN LINE	SA	USA	SANITARY SEWER, UNDERGROUND
	EDMGSC P	DAM, GRAVEL BAG/SAND BAG CHECK	- —— HB —— -	мнв	HIGHWAY BOUNDARY		STDB*	DOUBLE BROKEN LINE	]SA[	USAH	SANITARY SEWER, HANGING
		BAIN, STATE BAS SAID BAS SILEST	- ——— AHB ——— -	мнва	HIGHWAY BOUNDARY, APPROX.		STDL*	DOTTED LINE LONG		USAF	SANITARY SEWER, FORCE MAIN, UGND
	EDMPC_P	DAM, PREFABRICATED CHECK		MHBW	HWY BOUNDARY, FACE OF WALL		STDS*	DOTTED LINE SHORT	]SAF[	USAFH	SANITARY SEWER, FORCE MAIN, HANG
	EDMSC_P	DAM, STONE CHECK		MHBWOA	HIGHWAY BOUNDARY, W/O ACCESS		STFB*	FULL BARRIER LINE		UT	TELEPHONE, UNDERGROUND
	EDM3C_F	DAM, STONE CHECK		мјс	JURISDICTION, CITY		STH*	HATCH LINE		UTH	TELEPHONE, HANGING
<b>+</b>	EFNS	FENCE, SILT		MJCY	JURISDICTION, COUNTY		STPB*	PARTIAL BARRIER LINE		UTO	TELEPHONE, OVERHEAD
- × × -	EFNSV	FENCE, SILT & VEGETATION		MJHD	JURISDICTION, HISTORIC DISTRICT		STRCT	ROUNDABOUT, CAT TRACKS		UTV	CABLE TV. UNDERGROUND
×~	EFNV	FENCE, VEGETATION		MJLL	JURIS., (GREAT, MILITARY) LOT LINE	****	STRYL	ROUNDABOUT, YIELD LINE		UTVH	CABLE TV, HANGING
AA	EWAA_P	WETLAND, ADJACENT AREA		MJN	JURISDICTION, NATION		STSB	STOP BAR		UTVO	CABLE TV, HANGING
FW-	EWF	WETLAND, FEDERAL		мјрв	JURISDICTION, PUBLIC LANDS		STSE*	SOLID, EDGE		UUU	UNKNOWN, UNDERGROUND
FW SW	EWFS	WETLAND, FEDERAL AND STATE		MJS	JURISDICTION, STATE				\u0	UUH	UNKNOWN, UNDERGROUND  UNKNOWN, HANGING
SW	EWM	WETLAND, MITIGATION AREA		MJT	JURISDICTION, TOWN		STXL	X WALK, LADDER LINE	****		*
SW	EWS	WETLAND, STATE		MJV	JURISDICTION, VILLAGE	$   \    \    \    \    \    \    \    $	STXLB	X WALK, LADDER BAR LINE		UUO	UNKNOWN, OVERHEAD
				MPL	PROPERTY LOT LINE			* = W (WHITE) OR Y (YELLOW)		UW	WATER LINE, UNDERGROUND
				MPLA	PROPERTY LOT LINE, APPROXIMATE	TRAI	FFIC CO		]w[	UWH	WATER LINE, HANGING
1. THE LEGEND ILLUSTRATES MAPP	ING FEATURES	S (EXISTING AND PROPOSED).		MSL	SUB LOT LINE	<b>→</b>	TCSW	SIGNAL, SPAN WIRE	OW	UWO	WATER LINE, OVERHEAD
2. FEATURES ARE SHOWN AS EITHE	R LINEAR (RO	ADWAY GUIDERAIL, ROADWAY SIDEWALK,		MISL	SUD LUI LINE			·	I		
UTILITY LINES, ETC.) OR POINT	(SIGN, UTILIT	Y POLE, ETC.).									
<ol> <li>FEATURES SHOWN ON THE LEGEN CORRESPONDING PROPOSED FEATURE</li> </ol>		NG FEATURES ALSO HAVE									
4. PROPOSED FEATURE SYMBOLOGY	IS_IDENTICAL	TO EXISTING FEATURE SYMBOLOGY EXCLUD	DING								
LINE WEIGHT. LINE WEIGHT FOR DRAWINGS).	R PROPOSED F	EATURES IS THICKER (0.015 in ON B SIZE									
								Course Course	/   Th	TITLE OF PROJE	CONTRACT N

ROADWAY

DESCRIPTION

NAME

STYLE

LANDSCAPE

NAME

DESCRIPTION

STYLE

5. MAPPING FEATURES NOT INCLUDED ON THE LEGEND SHEET DO NOT HAVE A UNIQUE SYMBOLOGY (SUCH AS THE PAVEMENT EDGE, PAVEMENT EDGE OF TRAVEL WAY) AND SHOULD BE LABELED ON THE PLANS.

ALIGNMENT

DESCRIPTION

NAME

STYLE

6. FEATURES SHOWN AT THE HEAVIER WEIGHT ARE PROPOSED ONLY AND DO NOT HAVE CORRESPONDING EXISTING FEATURES.

NEW Thruway	TITLE OF PROJECT  1R MILL AND INLAY, SAFETY IMPROVEMENTS,  AND MISC, WORK	CONTRACT NUMBER:
STATE Authority	LOCATION OF PROJECT MP 416.90 TO MP 419.40	DATE:
· · ·	TITLE OF DRAWING	08/20/25
	LINE 0/4/DOL00/	DRAWING NUMBER:
	LINE SYMBOLOGY	LEG-1

TRAFFIC WORK ZONE

TWZBT\_P BARRIER, TEMPORARY

_																		
			ALIGNMENT			DRAINAGE			ITS		[	ROW MAPPING			SIGNS			UTILITIES
	CELL	NAME	DESCRIPTION	CELL	NAME	DESCRIPTION	CELL	NAME	DESCRIPTION	CELL	NAME	DESCRIPTION	CELL	NAME	DESCRIPTION	CELL	NAME	DESCRIPTION
_	*	ACC	CENTER OF CURVATURE	+	DINV	INVERT	Φ	IANT_P	ANTENNAS	<b>①</b>	MDL1P	DEED LINE, TYPE 1	<b>+</b>	S	SINGLE POST		UEB	ELECTRIC, BOX
ONS	+	ACOGO	COGO		DS	STRUCTURE, RECTANGULAR		IASCTS	ACCOU. SPEED/COUNT SNSR.S	2	MDL2P	DEED LINE, TYPE 2	þ	S_P	SINGLE POST, PROPOSED	E	UEM	ELECTRIC, METER
SAWR	0	ACS	CURVE TO SPIRAL	+	DSI	STRUCTURE, INVERT	P	ICABPAD	CABINET & PAD	3	MDL3P	DEED LINE, TYPE 3	i H	SB_P	BACK TO BACK, PROPOSED	Ø	UEMH	ELECTRIC, MANHOLE
Ĕ	Δ	ADPI_P	DETOUR, POINT OF INTERSECT.			1		ICCTV	CCTV SITE	4	MDL4P	DEED LINE, TYPE 4		SDEL	DELINEATORS	<del>-</del>	UEPT	ELECTRIC, POLE, TRANS.
조	0	ADPL_P	DETOUR, POINT ON LINE		DSM	STRUCTURE, MANHOLE	)@@(	ICDPD	CDPD TRANSCEIVER	5	MDL5P	DEED LINE, TYPE 5	<b></b>	SPM	PARKING METER	G	UGM	GAS, METER
ED B	0	AEQN	EQUATION	8	DSMTXX_P	STRUCTURE, MANHOLE, TYPE "XX"	*	ICELLT	CELL PHONE TOWER	0	MEEP	EASEMENT, EXISTING	RFM	SRM	REFERENCE MARKERS	<u>©</u>	UGMH	GAS, MANHOLE
H HECK	A	AEQNAHD	EQUATION AHEAD		DSR	"XX" = 48, 60, 72, 96 STRUCTURE, ROUND	€ 3	ICJB	CONDUIT JACK OR BORING	<b>(A)</b>	MEPAP_P	EASEMENT, PERM., APPROX.		SRSC3	SHLD, CTY, 123 DIG.	<b>-</b> �-	UGLM	GAS, LINE MARKER
	B	AEQNBK	EQUATION BACK		Bolt	STRUCTURE, RECT., WITH CURB		ICNTLCAB	CONTROLLER CABINET	0	MEPP_P	EASEMENT, PERM., BACK LINE	Ŏ	SRSC4	SHLD, CTY, 4 DIG.	FP	UGP	GAS/FUEL PUMP
	0	AEVT	EVENT STATION	2000	DST"X"CB_	P TYPE "X"  "X" = F, G, N, O, P, R		ICPB	COMMUNICATION PULL BOX	0	MEPSP_P	EASEMENT, PERM., SHAPE	0	SRSCT2	SHLD, CTY TOUR, 1-2 DIG.	⋈	UGV	GAS, VALVE
	0	APC	POINT OF CURVATURE	5000	el .	STRUCTURE, RECT., TYPE "X"		ICTD	CONDUIT TURNING DOWN	♦	MFAP_P	FEE ACQUISITION, APPROX.		SRSCT4	SHLD, CTY TOUR, 3-4 DIG.	<b>©</b>	UGVT	GAS, VENT
	0	APCC	POINT OF COMPOUND CURVATURE		DST"X"_P	"X" = I, K, L, M, O, P, U	<u> </u>	ICTU	CONDUIT TURNING UP	<b>♦</b>	MFP_P	FEE ACQUISITION, BACK LINE		SRSI	SHLD, INTERSTATE	⊙ю	ULP	LIGHTING, POLE
Z		API	POINT OF INTERSECTION		EN	VIRONMENTAL	)¢(	ICVTRT	COMM. VEH. ROAD TRANSCEIVER	•	MFSP_P	FEE ACQUISITION, SHAPE	₩	SRSN2	SHLD, NATIONAL, 2 DIG.	Ф	ULPM	LIGHTING, POLE, MEDIAN
N QU	Δ	APOB	POINT OF BEGINNING			1	+	IDEFAULT	DEFAULT	<b>X</b>	МНВАР	HIGHWAY BNDRY., APPROX.		SRSN3	SHLD, NATIONAL, 3 DIG.	<b>@</b>	ULPP	LIGHTING, POLE, PED.
JILLIA	$\odot$	APOC	POINT OF CURVATURE	CULV	EI0P_P	STR., INLET, OUTLET PROT.	EZ	IEZR	E-ZPASS READER	•	мнвср	HISTORICAL, BLDG. CORNERS	0	SRSS2	SHLD, STATE, 2 DIG.		UMFC	MISC. FILLER CAP
<u>,</u>	۵	AP0E	POINT OF END	<b>ĞB</b>	EIPGB_P	STR., INLET PROT., GRAVEL BAG	EZ-T	IEZTR	TRANSMITTAL READER	*	мнвр	HIGHWAY BNDRY, PT.	0	SRSS3	SHLD, STATE, 3 DIG.		UOLM	OIL, LINE MARKER
<u> </u>	0	APOL	POINT ON LINE	<b>±</b>			□ xc	IFOXCAB	FIBER OPTIC X-CONNECT CABINET	<b>⊘</b>	МЈСР	PT., JURIS. CITY	$\Diamond$	SRSS4	SHLD, STATE, 4 DIG.	-0-	UP	POLE, WITH UTILITY
DRAF	0	APOS	POINT ON SPIRAL	(H/S)	EIPHS_P	STR., INLET PROT., HAY/STRAW	•	IFUSSPL	FUSION SPLICE	•	MPBC	PT., BUILDING CORNER		TRA	FFIC CONTROL	0	UPD	POLE, DEAD (NO UTILITY)
	0	APOT	POINT ON TANGENT	PRFB	EIPP_P	STR., INLET PROT., PREFAB.	<del>\$\$</del>	IHARADV	HAR ADVISORY SIGN	<b></b>	MPCC	PT., CROSS CUT		тсву	BOX, JUNCTION	ф	UPL	POLE, WITH LIGHT
	Δ	APOVC	POINT ON VERTICAL CURVE	<b>±</b>			一位	IHARST	HAR SITE	¥	MPDH	PT., DRILL HOLE		TCBP	BOX, PULL BOX	<u></u>	USMH	SANITARY SEWER MANHOLE
	Δ	APOVT	POINT ON VERTICAL TANGENT	(SF)	EIPSF_P	STR., INLET PROT., SILT FENCE	⊠ LC	ILC	LOAD CENTER	*	MPF	PT., FENCE LOCATION		TCBS	BOX, SPLICE	P	UTB	TELEPHONE, BOOTH
SK	Υ	APORC	POINT ON REVERSE CURVE		ERCB	RISER, CONCRETE BOX	-8-	IMECSPL	MECHANICAL SPLICE	0	MPIP	PT., IRON PIPE		TCMC	MICROCOMPUTER CABINET	\$-	UTLM	TELEPHONE, LINE MARKER
WRON	0	APT	POINT OF TANGENCY		ETRS_P	TRAP, SEDIMENT	(CM	IMSCS	PORT. SPEED & COUNT SENSOR	$\odot$	MPIR	PT., IRON ROD	· ·	TCPP	PED POLE	<b>(7)</b>	UTMH	TELEPHONE, MANHOLE
H GA	(1)	APVC	POINT OF VERTICAL CURVATURE	+	EWFG	WETLAND FLAG	(CM	IMSCTS	MICRO SPEED & COUNT SENSOR		мРМ	PT., MONUMENT	<u></u> →	TCSH	SIGNAL HEADS	<b>-</b> \$	UTVLM	CABLE TV, LINE MARKER
Ā  <b> </b>	Δ	APVCC	POINT OF VERT. CMPND CURVE	'	1		-`M´:	IMT	MICROWAVE TRANSCEIVER	$\blacksquare$	МРММ	PT., MONUMENT, MISC.	-	TCSP	SIGNAL POLE	0	UTVPB	CABLE TV, PULL BOX
 M	<b>(A)</b>	APVI	POINT OF VERT. INTERSECTION		. GE	EOTECHNICAL	O VMS	IOVHVMS	PERM. OVERHEAD VMS	Ø	MPN	PT., NAIL		<u> </u>			UUB	UNKNOWN, BOX
CKED	Δ	APVRC	POINT OF VERT. REVERSE CURVE	•	GDH	DRILL HOLE	PADD	IPASCS	PORT. ACCOU. SPD & CNT. SENSOR	*	MPRS	PT., RAILROAD SPIKE		IRAF	FIC WORK ZONE	×	UUJB	UNKNOWN, JUNCTION BOX
품	(1)	APVT	POINT OF VERTICAL TANGENCY		1	LANDSCAPE		IPEDS	PEDESTRIAN SIGNAL HEAD	斑	MPSP	PT., SPIKE	<u>::</u>	TWZAP_P	ARROW PANEL	8	UUMH	UNKNOWN, MANHOLE
	<b></b>	ASC	SPIRAL TO CURVE	+	LELS	ELEVATION. SPOT	<b>\Q</b>	IPSS	PAVEMENT SURFACE SENSOR	*	MPST	PT., STAKE	<u>                                     </u>	TWZAPC_P	ARROW PANEL, CAUTION MODE		UUPB	UNKNOWN, PULL BOX
	$\triangle$	ASPI	SPIRAL POINT OF INTERSECTION	6	LFP	FLAG POLE	PVMS	IPVMS	PERM. VMS	⊗	MPTW	PT., TREE W/ WIRE	•••	TWZAPT_P	ARROW PANEL, TRAILER OR SUPPORT		UUVL	UNKNOWN, VALVE
	0	ASTS	SPIRAL TO SPIRAL		LMB	MAILBOX	M.	IRM	RAMP METER	+	MPWL	PT., WALL LOCATION		TWZBCD_P	BARRICADE (TYPE III)	<b>T</b>	UUVT	UNKNOWN, VENT
	$\otimes$	AST	SPIRAL TO TANGENT		LPB	PAPER BOX	A RWIS	IRWIS	RDWY WEATHER INFO. SENSOR		R0	W ACQUISITION	ш	TWZCMS_P	CHANGEABLE MESSAGE SIGN (PVMS)	0	UUW	UNKNOWN, WELL
SUIN	$\otimes$	ATS	TANGENT TO SPIRAL	0	LPST	POST, SINGLE	図   図	ISP	SOLAR PANEL	₩}	MES D T	FEE ACQUISITION		TWZFLG_P		₫	UWFH	WATER, FIRE HYDRANT
IAN	۵	AVEVT	VERTICAL EVENT POINT	<b>(13)</b>	LRB	ROCK, BOULDER	- <u>- (3)</u> :	ISST	SPREAD SPECT. TRANSCEIVER	FEE	WII 3_I _ I	TEL ACQUISITION	T T	TWZFT_P	FLAG TREE  IMPACT ATTENUATOR /	W	UWM	WATER, METER
=	0	AVHIGH	VERTICAL HIGH POINT	米	LSHC	SHRUB, CONIFEROUS	ΤC	ITDB	TELEPHONE DEMARCATION BLK	MI	MEPS_P_T	EASEMENT, PERMANENT		TWZIA_P	CRASH CUSHION (TEMPORARY)		UWMH	WATER, MANHOLE
	0	AVLOW	VERTICAL LOW POINT	0	LSHD	SHRUB, DECIDUOUS	O TP	ITP	SUBSURFACE TEMP. PROBE	(MI)	METS P T	EASEMENT. TEMPORARY		TWZLUM_P		<u>+</u>	UWV	WATER, VALVE
SIGN			BRIDGE		LTC	TREE, CONIFEROUS	)Ó(	IVTRT	VEHICLE TO RDWY TRANSCEIVER	<u> </u>	ME 132121	ENGLINETY TEMPORATOR	<del></del>	TWZSDT_P	SYMBOL, DIRECTION OF TRAFFIC  SYMBOL, DIRECTION OF TEMPORARY	<u> </u>	UWW	WATER, WELL
		BSC	BRIDGE, SCUPPER	(0)	LTD	TREE, DECIDUOUS	WIM	IWIMD	WEIGHT IN MOTION DETECTOR	M1 To	METS_P_T	OCCUPANCY, TEMPORARY	<u></u>	TWZSDTD_	TRAFFIC DETOUR			
			CONTROL	Ö	LTS	TREE, STUMP		IWVR	WIRELESS VIDEO REPEATER	(M1) (P1)	MFS_P_T	FEE ACQUISITION W/O ACCESS		TWZSGN_P	SIGN (TEMPORARY) SIGNAL, TRAFFIC OR PEDESTRIAN			
	^	000		Ø	LTW_P	TREE, WELL OR WALL	(V)-(	IWVRC	WIRELESS VIDEO RECEIVER	FEE WO/A			0-	TWZSIG_P	(TEMPORARY)			
		CBP	BASELINE, POINT	+	LUKP	UNKNOWN POINT	- ``\\\\``	IWVTT	WIRELESS VIDEO TRANSMITTER			ROADWAY	2	TWZWL_P	WARNING LIGHT			
ONSK	0	CBPOL	BASELINE, POINT ON LINE	1. THE	LEGEND IL	LUSTRATES MAPPING FEATURES (E)	- ISTING A	ND PROPOSED).		0	RES_P	ELEVATION, SPOT		TWZWVA D	WORK VEHICLE WORK VEHICLE WITH TRUCK			
SAWR	<u>Φ</u>	CBSP	BASELINE, SPUR POINT	2. FEA	ATURES ARE	SHOWN AS EITHER LINEAR (ROADWA	Y GUIDER	RAIL, ROADWAY			RGA	GUIDE RAIL, ANCHOR		TWZWVA_P	MOUNTED ATTENUATOR			
E	⟨₹	CBTP	BASELINE, TIE POINT	UTII	LITY LINES,	, ETC.) OR POINT (SIGN, UTILITY PO	LE, ETC.	).		0	RGP	GUIDE POST, SINGLE						
R. KE	<u> </u>	СРВМ	BENCHMARK  BOINT HORIZ BHOTOCRAMMETRY			WN ON THE LEGEND AS EXISTING F PROPOSED FEATURES.	EATURES	ALSO HAVE	·									
RVISC	<b>₩</b>	CPH CPSM	POINT, HORIZ. PHOTOGRAMMETRY POINT, SURVEY MARKER, PERM.			TURE SYMBOLOGY IS IDENTICAL TO											TITLE OF PROJE	ет СС
SUPE	<b>9</b>					E WEIGHT. LINE WEIGHT FOR PROF SIZE DRAWINGS).	USED FE	ATUKES IS THI	IUNER					5	YORK Thruway	ļ	1R MILL AND	O INLAY, SAFETY IMPROVEMENTS, AND MISC. WORK
ž.	Ψ	CPSV	POINT, VERT., PHOTOGRAMMETRY	S MAP	PPING FFATI	IRES NOT INCLUDED ON THE LEGEN	SHEET	DO NOT HAVE	A LINTOLIE					_	— ŞTATE Authority		LOCATION OF PE	ROJECT MP 416.90 TO MP 419.40

5. MAPPING FEATURES NOT INCLUDED ON THE LEGEND SHEET DO NOT HAVE A UNIQUE SYMBOLOGY (SUCH AS THE PAVEMENT EDGE, PAVEMENT EDGE OF TRAVEL WAY) AND SHOULD BE LABELED ON THE PLANS.

6. FEATURES SHOWN AT THE HEAVIER WEIGHT ARE PROPOSED ONLY AND DO NOT HAVE CORRESPONDING EXISTING FEATURES.

Thruway Authority

Thruway Authority

Title of PROJECT 1R MILL AND INILAY, SAFETY IMPROVEMENTS, AND MISC. WORK

LOCATION OF PROJECT MP 419.40

TITLE OF DRAWING


TOWNTRACT NUMBER: TAB 25-31


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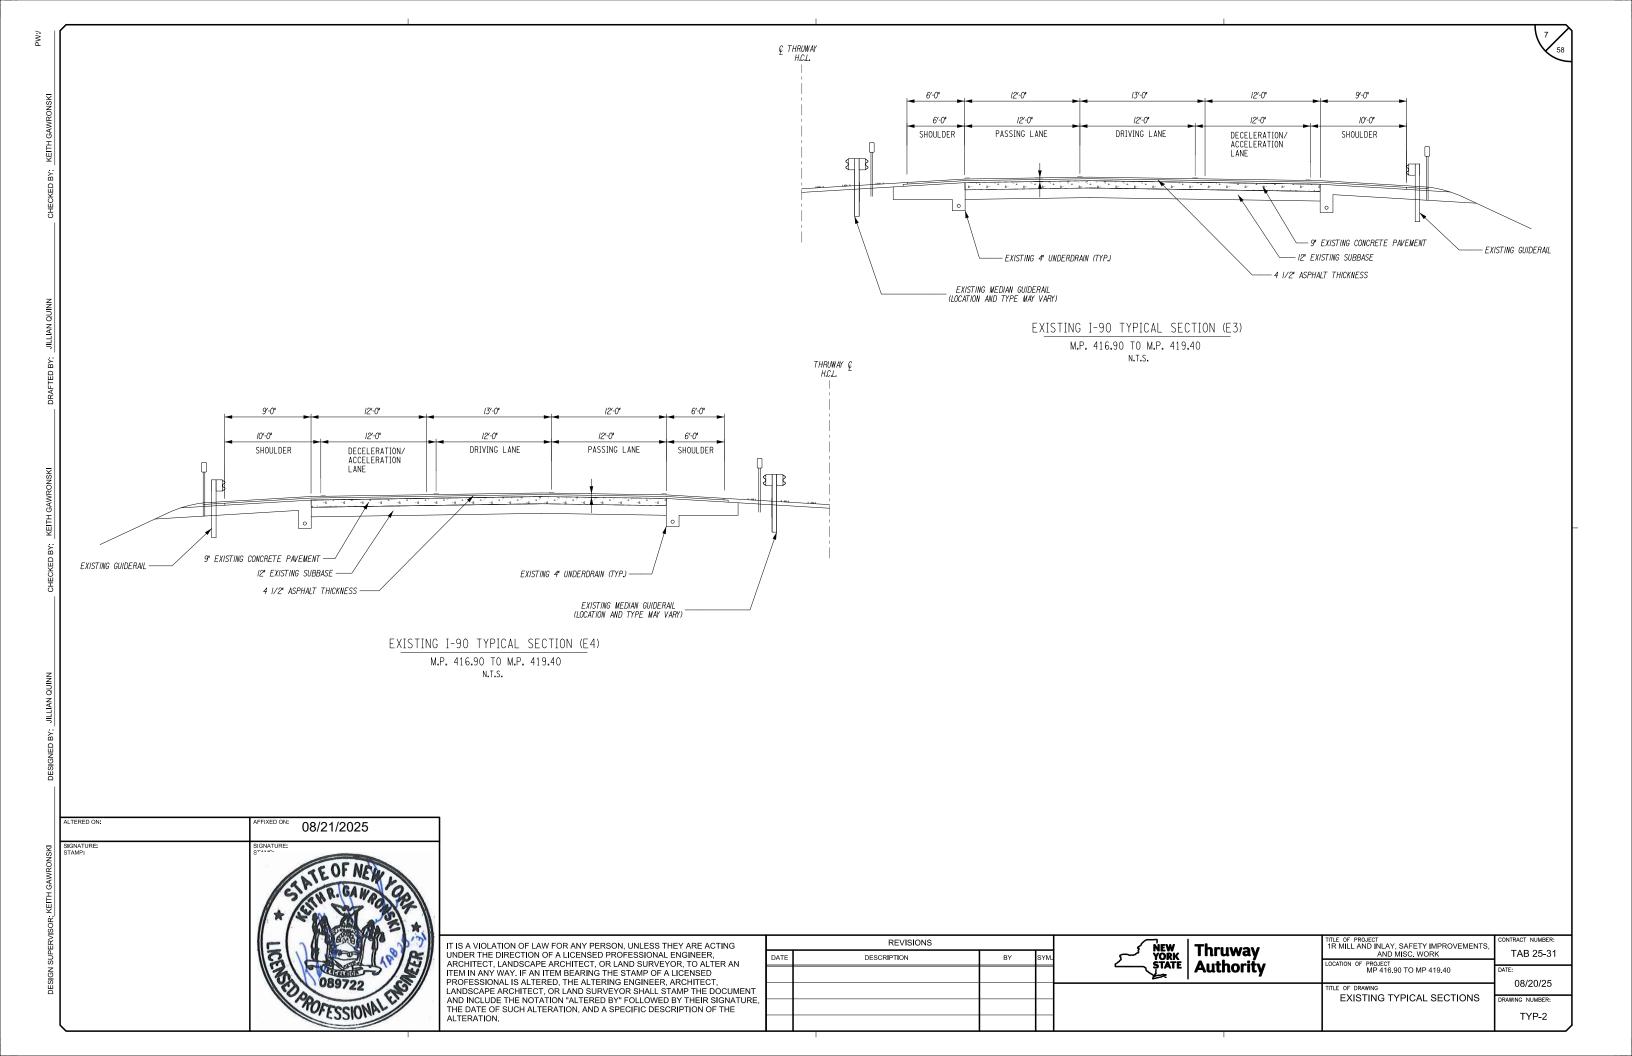
08/20/25

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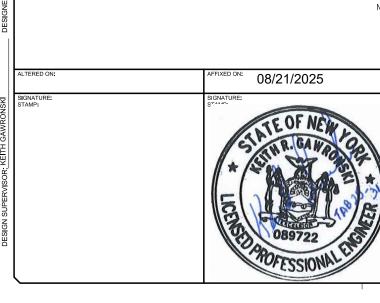
LEG-2






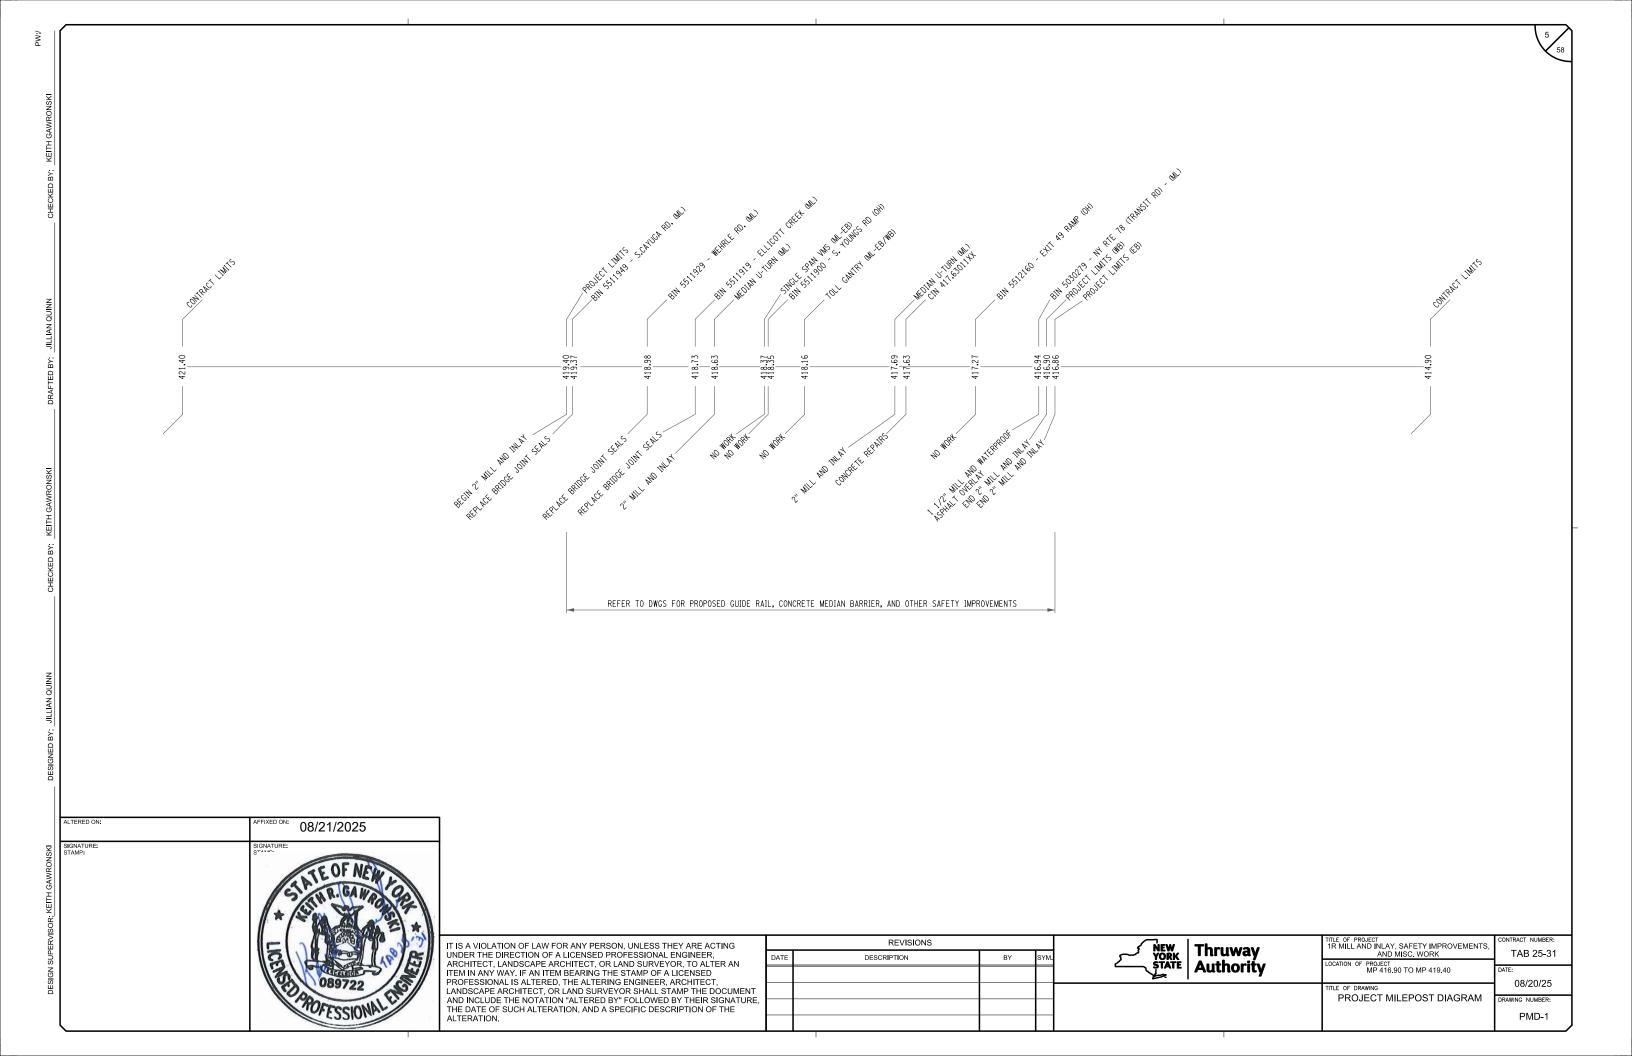


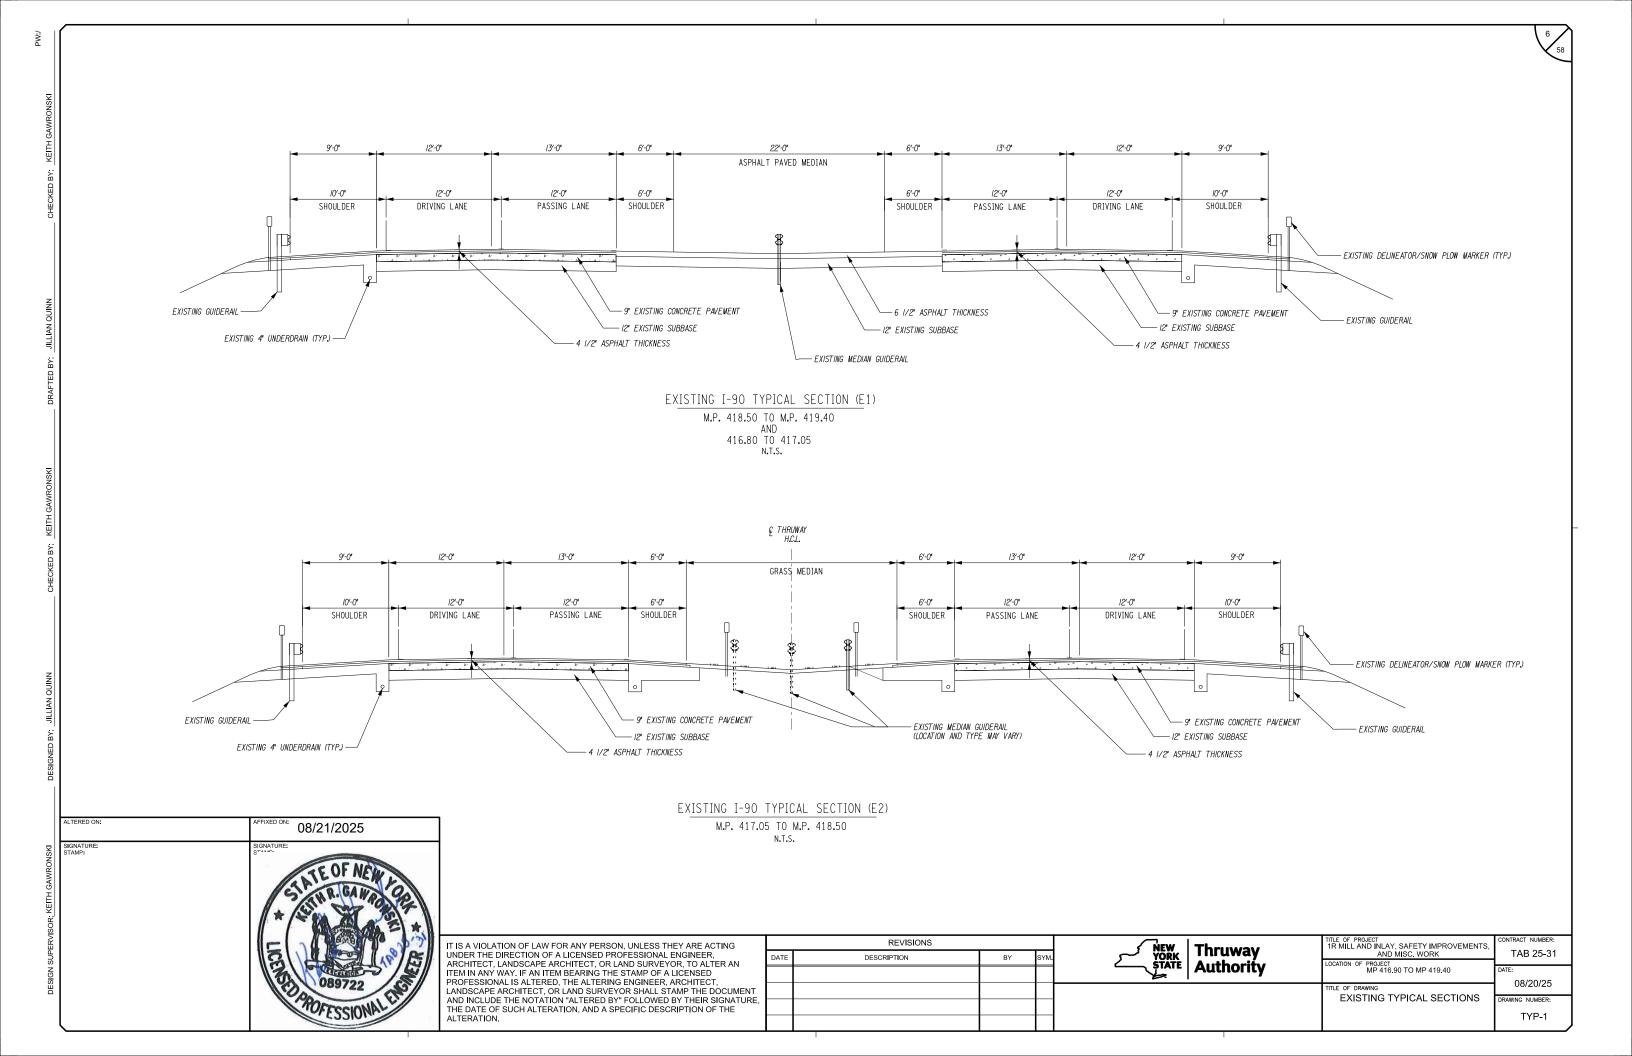




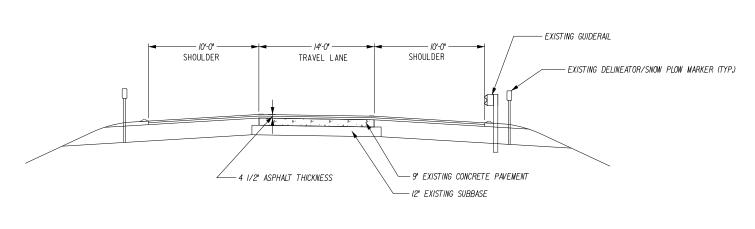


EXISTING I-90 TYPICAL SECTION
EXIT 49 WB OFF RAMP
N.T.S.

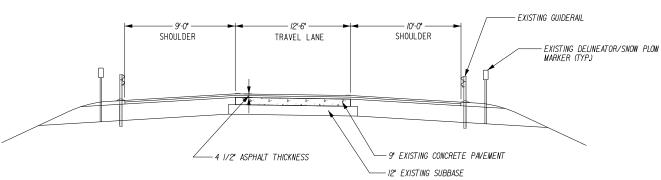

EXISTING I-90 TYPICAL SECTION
EXIT 49 EB ON RAMP
N.T.S.

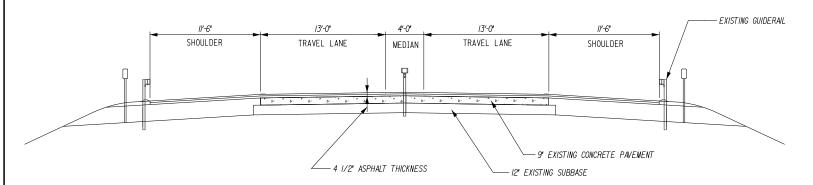

EXISTING I-90 TYPICAL SECTION
EXIT 49 WB ON AND OFF RAMP
N.T.S.

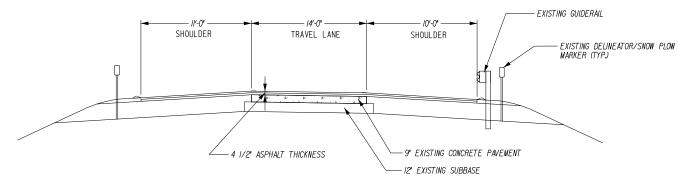

EXISTING I-90 TYPICAL SECTION
EXIT 49 EB OFF RAMP
N.T.S.

IT IS A VIOLATION OF LAW FOR ANY PERSON, UNLESS THEY ARE ACTING UNDER THE DIRECTION OF A LICENSED PROFESSIONAL ENGINEER, ARCHITECT, LANDSCAPE ARCHITECT, OR LAND SURVEYOR, TO ALTER AN ITEM IN ANY WAY. IF AN ITEM BEARING THE STAMP OF A LICENSED	
PROFESSIONAL IS ALTERED, THE ALTERING ENGINEER, ARCHITECT, LANDSCAPE ARCHITECT, OR LAND SURVEYOR SHALL STAMP THE DOCUMENT AND INCLUDE THE NOTATION "ALTERED BY" FOLLOWED BY THEIR SIGNATURE, THE DATE OF SUCH ALTERATION, AND A SPECIFIC DESCRIPTION OF THE	l
ALTERATION.	Γ

DATE	REVISIONS  DESCRIPTION	BY	SYM.	NEW Thruway STATE Authority	TITLE OF PROJECT 1R MILL AND INLAY, SAFETY IMPROVEMENTS, AND MISC. WORK	TAB 25-31
				STATE   Authority	MP 416.90 TO MP 419.40  TITLE OF DRAWING	DATE: 08/20/25
					EXISTING TYPICAL SECTIONS	DRAWING NUMBER:




6'-0" 12'-0" 12'-0" 10'-0" SHOULDER > PASSING LANE DRIVING LANE SHOULDER — EXISTING CONCRETE BARRIER (TYP) 12" SUBBASE - 2" TOP COURSE 8" BASE COURSE — — 3" BINDER COURSE EXISTING UNDERDRAIN (TYP.) EXISTING I-90 TYPICAL SECTION (E1)

TOLL GANTRY

M.P. 416.90 TO M.P. 419.40

N.T.S.

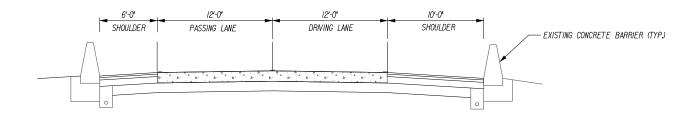

## EXISTING I-90 TYPICAL SECTION (E1)

TOLL GANTRY M.P. 416.90 TO M.P. 419.40 N.T.S.

1. NO WORK TO BE DONE TO GANTRY CONCRETE PAVEMENT SEE GENERAL PLANS FOR DETAILS. REFER TO SPECIAL NOTES IN THE PROPOSAL FOR WORKING NEAR AND UNDER TOLL GANTRIES.

	ALTERED ON:	AFFIXED ON: 08/21/2025
DESIGN SUPERVISOR: KEITH GAWRONSKI	SIGNATURE: STAMP:	SIGNATURE: STATE OF NEW COMPANY OF THE OF THE OF NEW COMPANY OF THE OF T

IT IS A VIOLATION OF LAW FOR ANY PERSON, UNLESS THEY ARE ACTING UNDER THE DIRECTION OF A LICENSED PROFESSIONAL ENGINEER, ARCHITECT, LANDSCAPE ARCHITECT, OR LAND SURVEYOR, TO ALTER AN ITEM IN ANY WAY. IF AN ITEM BEARING THE STAMP OF A LICENSED PROFESSIONAL IS ALTERED, THE ALTERING ENGINEER, ARCHITECT, LANDSCAPE ARCHITECT, OR LAND SURVEYOR SHALL STAMP THE DOCUMENT AND INCLUDE THE NOTATION "ALTERED BY" FOLLOWED BY THEIR SIGNATURE, THE DATE OF SUCH ALTERATION, AND A SPECIFIC DESCRIPTION OF THE ALTERATION.

	REVISIONS			NEW Thruway	TITLE OF PROJECT 1R MILL AND INLAY, SAFETY IMPROVEMENTS,	CONTRACT NUMBER:
DATE	DESCRIPTION	BY	SYM.	1 IURN I	AND MISC. WORK	TAB 25-31
				<b>STATE</b> Authority	MP 416.90 TO MP 419.40	DATE:
					TITLE OF DRAWING	08/20/25
					EXISTING TYPICAL SECTIONS	DRAWING NUMBER:
						TYP-4

LIMITS OF ITEM 404.0952 AND ITEM 490.15 LIMITS OF ITEM 404.0952 AND ITEM 490.15 22'-0" ASPHALT PAVED MEDIAN 9'-0" 12'-0" 13'-0" 13'-0" 12'-0" 9'-0" UNDERLYING PCC PAVEMENT LANE CONFIGURATION 10'-0" 12'-0" 12'-0" 6'-0" 6'-0" 12'-0" 12'-0" 10'-0" PASSING LANE DRIVING LANE SHOULDER SHOULDER DRIVING LANE SHOULDER SHOULDER PASSING LANE - EXISTING DELINEATOR/SNOW PLOW MARKER (TYP.) ITEM 635.04030225 ITEM 685.17070025 BROKEN WHITE ITEM 635.04030225 ITEM 685.17070025 BROKEN WHITE EXISTING GUIDERAIL PROPOSED MEDIAN HPB0 ITEM 606.2801 2" ITEM 490.15 2" ITEM 404.0952 EXISTING GUIDERAIL EXISTING MIARDS TO REMAIN 2" ITEM 490.15 2" ITEM 404.0952 ITEM 407.01040009 ITEM 407.01040009 LOCATION MAY VARY (SEE GENERAL PLANS) EXISTING 4" UNDERDRAIN (TYP.) -— EXISTING MIARDS TO REMAIN ITEM 635.04030225 ITEM 685.17070025 SOLID WHITE ITEM 635.04030225 ITEM 635.04030225 ITEM 635.04030225 ITEM 685.17080025 SOLID YELLOW ITEM 685.17080025 SOLID YELLOW ITEM 685.17070025 SOLID WHITE

> PROPOSED I-90 MAINLINE TYPICAL SECTION (P1) ONE COURSE MILL AND INLAY NO SHOULDERS M.P. 418.50 TO M.P. 419.40 (WESTBOUND) M.P. 418.50 TO M.P. 419.40 (EASTBOUND) N.T.S.

## - ITEM 404.0952, ITEM 490.15, ITEM 407.01040009

ALTERED ON:	AFFIXED ON: 08/21/2025
SIGNATURE: STAMP:	SIGNATURE: STATE OF NEW CORP.  THE OF NEW CORP.

203.02	UNCLASSIFIED EXCAVATION	CY
203.24000025	SHOULDER BACKUP MATERIAL	TON
404.0952	9.5 F2 TOP COURSE ASPHALT, 50 SERIES COMPACTION	TON
407.01040009	NON-TRACKING TACK COAT	GAL
418.7603	ASPHALT PAVEMENT JOINT ADHESIVE	LF
490.15	PRODUCTION COLD MILL SURFACE PLANING OF BITUMINOUS CONCRETE	SY
606.2801	HPBO (MOD.) CORRUGATED MEDIAN BARRIER	LF
619.0901	TEMPORARY PAVEMENT MARKING STRIPES (TRAFFIC PAINT)	LF
627.50140008	SAWCUTTING PAVEMENT	LF
635.0403225	RECESS DIAMOND GRINDING FOR INLAID PAVEMENT MARKINGS	LF
649.01	MILLED IN AUDIBLE ROADWAY DELINEATION (MIARDS)	LF
685.11060025	WHITE EPOXY REFLECTORIZED PAVEMENT STRIPES 6' x 20 MILS	LF
685.12060025	YELLOW EPOXY REFLECTORIZED PAVEMENT STRIPES 6' x 20 MILS	LF
685.17070025	WHITE HIGHLY REFLECTORIZED TRIPLE DROP EPOXY PAVEMENT STRIPES 6" x 20 MILS	LF
685,17080025	YELLOW HIGHLY REFLECTORIZED TRIPLE DROP EPOXY PAVEMENT STRIPES 6" x 20 MILS	LF

ITEM

1. CROSS SLOPES MAY VARY NORMAL CROWN TO FULL SUPERELEVATION (BOTH BANKED LEFT AND RIGHT), THE PROPOSED TRAVEL LANE AND SHOULDER CROSS SLOPE SHALL MATCH THE EXISTING CROSS SLOPE IN ALL CASES.

2. TEMPORARY PAVEMENT MARKING STRIPES (TRAFFIC PAINT) ARE REQUIRED WHEN PERMANENT STRIPING LANES ARE REMOVED AND WILL BE INSTALLED PRIOR TO OPENING TRAVEL LANES TO TRAFFIC. PAYMENT UNDER 619.0901. REFER TO STANDARD SHEET TA 685-04.

3. ALL DEBRIS ON MILLED SURFACE SHALL BE REMOVED IN ACCORDANCE WITH SECTION 490-COLD MILLING OF THE NYSDOT STANDARD SPECIFICATIONS.

4. THE CONTRACTOR SHALL ALIGN THE PROPOSED LONGITUDINAL JOINTS WITH EXISTING LONGITUDINAL JOINTS. SEE DTL-9 FOR DETAIL ON CONSTRUCTION OF LONGITUDINAL JOINTS.

5. PLACE TACK COAT ON ALL EXPOSED SURFACES WHICH WILL BE IN CONTACT WITH NEW ASPHALT, COST TO BE PAID FOR UNDER ITEM 407.01040009, FOR APPLICATION RATES, SEE TABLE 407-1 OF NYSDOT SPECIAL SPECIFICATION.

6. ITEM 418.7603, ASPHALT JOINT ADHESIVE, SHALL BE PLACED ON CENTERLINE JOINT AND INTERFACE BETWEEN DRIVING AND RAMP LANES.

7. PERMANENT PAVEMENT STRIPES ARE TO BE REPLACED IN KIND AFTER ALL MILL AND INLAY OPERATIONS ARE COMPLETED, COST TO BE PAID FOR UNDER ITEMS 685.17070025 AND 685.17080025. RAMP STRIPES SHALL BE PAID UNDER 685.11060025 AND 685.12060025. ALL PAVEMENT MARKINGS SHALL BE INSTALLED PER NYSTA STANDARD SHEET TA 685-01.


TAB 25-31


08/20/25


TYP-5

IT IS A VIOLATION OF LAW FOR ANY PERSON, UNLESS THEY ARE ACTING		REVISIONS				TITLE OF PROJECT 1R MILL AND INLAY, SAFETY IMPROVEMENTS,
UNDER THE DIRECTION OF A LICENSED PROFESSIONAL ENGINEER, ARCHITECT, LANDSCAPE ARCHITECT, OR LAND SURVEYOR, TO ALTER AN	DATE	DESCRIPTION	BY	SYM.	NEW Thruway STATE Authority	AND MISC. WORK
ITEM IN ANY WAY. IF AN ITEM BEARING THE STAMP OF A LICENSED					STATE Authority	MP 416.90 TO MP 419.40
PROFESSIONAL IS ALTERED, THE ALTERING ENGINEER, ARCHITECT, LANDSCAPE ARCHITECT, OR LAND SURVEYOR SHALL STAMP THE DOCUMENT						TITLE OF DRAWING
AND INCLUDE THE NOTATION "ALTERED BY" FOLLOWED BY THEIR SIGNATURE, THE DATE OF SUCH ALTERATION, AND A SPECIFIC DESCRIPTION OF THE						PROPOSED TYPICAL SECTIONS
ALTERATION.						



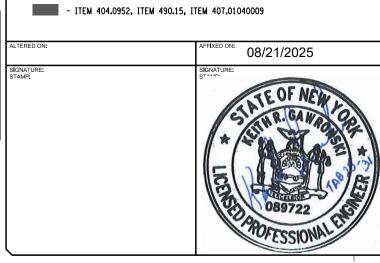

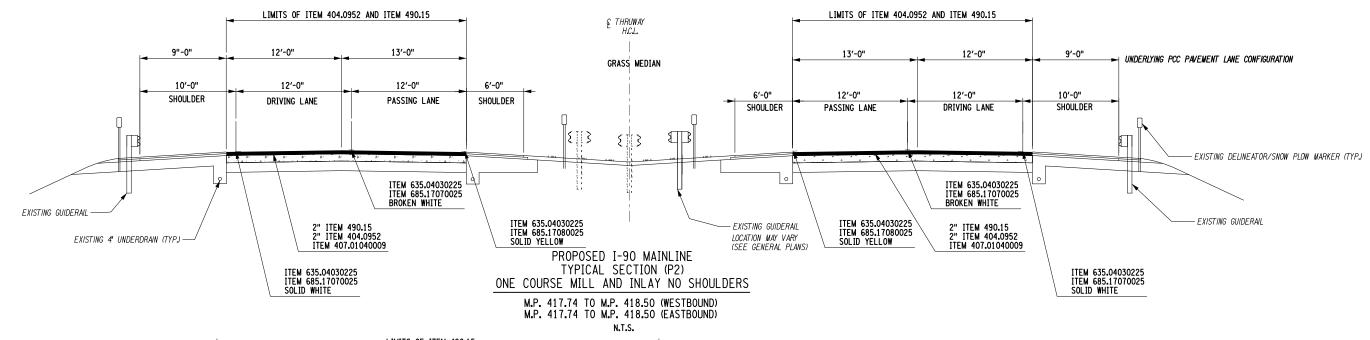

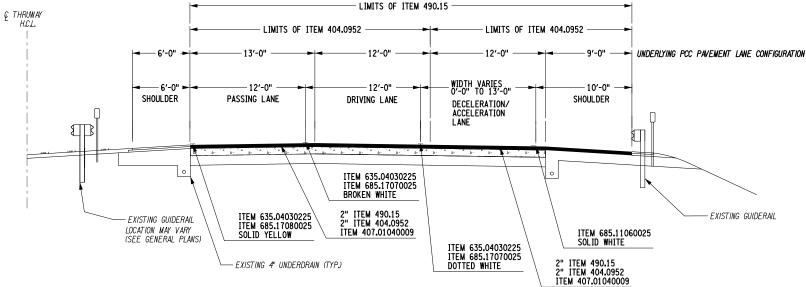

## PROPOSED I-90 MAINLINE TYPICAL SECTION (P3) ONE COURSE MILL AND INLAY WITH RAMP LANE AND SHOULDER

M.P. 417.40 TO M.P. 417.60 (EASTBOUND) M.P. 417.12 TO M.P. 417.30 (WESTBOUND) M.P. 417.56 TO M.P. 417.74 (WESTBOUND)


## N.T.S. SHOWN DIRECTION OF TRAVEL

	ITEM	DESCRIPTION	UNIT
	404.0952	9.5 F2 TOP COURSE ASPHALT, 50 SERIES COMPACTION	TON
	407.01040009	NON-TRACKING TACK COAT	GAL
$\neg$	418.7603	ASPHALT PAVEMENT JOINT ADHESIVE	LF
- 1	490.15	PRODUCTION COLD MILL SURFACE PLANING OF BITUMINOUS CONCRETE	SY
⊣	606.2801	HPBO (MOD.) CORRUGATED MEDIAN BARRIER	LF
-1	619.0901	TEMPORARY PAVEMENT MARKING STRIPES (TRAFFIC PAINT)	LF
- 1	635.0403225	RECESS DIAMOND GRINDING FOR INLAID PAVEMENT MARKINGS	LF
- 1	649.01	MILLED IN AUDIBLE ROADWAY DELINEATION (MIARDS)	LF
- 1	685.11060025	WHITE EPOXY REFLECTORIZED PAVEMENT STRIPES 6' x 20 MILS	LF
	685.12060025	YELLOW EPOXY REFLECTORIZED PAVEMENT STRIPES 6' x 20 MILS	LF
	685.17070025	WHITE HIGHLY REFLECTORIZED TRIPLE DROP EPOXY PAVEMENT STRIPES 6" x 20 MILS	LF
	685.17080025	YELLOW HIGHLY REFLECTORIZED TRIPLE DROP EPOXY PAVEMENT STRIPES 6" x 20 MILS	LF
		·	

## NOTES:

- NOIES:
  1. CROSS SLOPES MAY VARY NORMAL CROWN TO FULL SUPERELEVATION (BOTH BANKED LEFT AND RIGHT), THE PROPOSED TRAVEL LANE AND SHOULDER CROSS SLOPE SHALL MATCH THE EXISTING CROSS SLOPE IN ALL CASES.
- 2. TEMPORARY PAVEMENT MARKING STRIPES (TRAFFIC PAINT) ARE REQUIRED WHEN PERMANENT STRIPING LANES ARE REMOVED AND WILL BE INSTALLED PRIOR TO OPENING TRAVEL LANES TO TRAFFIC. PAYMENT UNDER 619.0901. REFER TO STANDARD SHEET TA 685-04.
- 3. ALL DEBRIS ON MILLED SURFACE SHALL BE REMOVED IN ACCORDANCE WITH SECTION 490-COLD MILLING OF THE NYSDOT STANDARD SPECIFICATIONS.
- 4. THE CONTRACTOR SHALL ALIGN THE PROPOSED LONGITUDINAL JOINTS WITH EXISTING LONGITUDINAL JOINTS. SEE DTL-9 FOR DETAIL ON CONSTRUCTION OF LONGITUDINAL JOINTS.
- 5. PLACE TACK COAT ON ALL EXPOSED SURFACES WHICH WILL BE IN CONTACT WITH NEW ASPHALT, COST TO BE PAID FOR UNDER ITEM 407.01040009, FOR APPLICATION RATES, SEE TABLE 407-1 OF NYSDOT SPECIAL SPECIFICATION.
- 6. ITEM 418.7603, ASPHALT JOINT ADHESIVE, SHALL BE PLACED ON CENTERLINE JOINT AND INTERFACE BETWEEN DRIVING AND RAMP LANES.
- 7. PERMANENT PAVEMENT STRIPES ARE TO BE REPLACED IN KIND AFTER ALL MILL AND INLAY OPERATIONS ARE COMPLETED, COST TO BE PAID FOR UNDER ITEMS 685.17070025 AND 685.17080025. RAMP STRIPES SHALL BE PAID UNDER 685.11060025 AND 685.12060025. ALL PAVEMENT MARKINGS SHALL BE INSTALLED PER NYSTA STANDARD SHEET TA 685-01.

I	IT IS A VIOLATION OF LAW FOR ANY PERSON, UNLESS THEY ARE ACTING		REVISIONS			NEW   Thrusay	TITLE OF PROJECT 1R MILL AND INLAY, SAFETY IMPROVEMENTS,	CONTRACT NUMBER:
-	UNDER THE DIRECTION OF A LICENSED PROFESSIONAL ENGINEER, ARCHITECT. LANDSCAPE ARCHITECT. OR LAND SURVEYOR. TO ALTER AN	DATE	DESCRIPTION	BY	SYM.	NEW Thruway STATE Authority	AND MISC. WORK	TAB 25-31
/	ITEM IN ANY WAY. IF AN ITEM BEARING THE STAMP OF A LICENSED PROFESSIONAL IS ALTERED. THE ALTERING ENGINEER. ARCHITECT.					STATE   Authority	MP 416.90 TO MP 419.40	DATE:
	LANDSCAPE ARCHITECT, OR LAND SURVEYOR SHALL STAMP THE DOCUMENT						TITLE OF DRAWING PROPOSED TYPICAL SECTIONS	08/20/25
	AND INCLUDE THE NOTATION "ALTERED BY" FOLLOWED BY THEIR SIGNATURE, THE DATE OF SUCH ALTERATION, AND A SPECIFIC DESCRIPTION OF THE						PROPOSED ITPICAL SECTIONS	DRAWING NUMBER:
	ALTERATION.							TYP-6

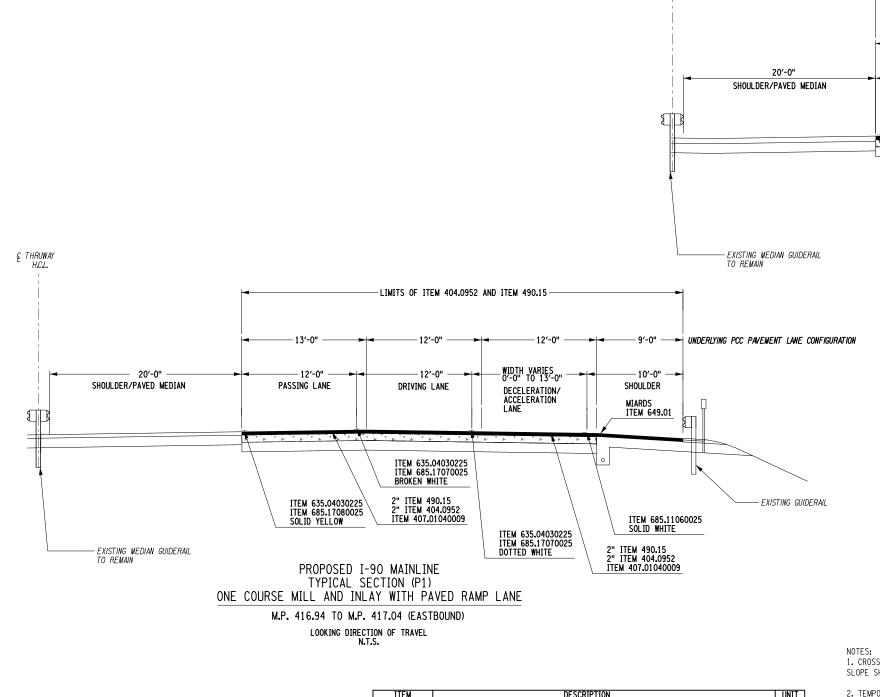

PROPOSED I-90 MAINLINE TYPICAL SECTION (P1) ONE COURSE MILL AND INLAY M.P. 416.90 TO M.P. 417.04 (WESTBOUND) LOOKING DIRECTION OF TRAVEL N.T.S.

LIMITS OF ITEM 404.0952 AND ITEM 490.15

2" ITEM 490.15 2" ITEM 404.0952 ITEM 407.01040009

12'-0"

12'-0"

DRIVING LANE

ITEM 635.04030225 ITEM 685.17070025 BROKEN WHITE

9′-0"

10'-0"

SHOULDER

ITEM 635.04030225 ITEM 685.17070025 SOLID WHITE

- EXISTING MIARDS TO REMAIN

UNDERLYING PCC PAVEMENT LANE CONFIGURATION

- EXISTING GUIDERAIL

- EXISTING DELINEATOR/SNOW PLOW MARKER (TYP)

13'-0"

12'-0"

PASSING LANE

ITEM 635.04030225 ITEM 685.17080025 SOLID YELLOW

## - ITEM 404.0952, ITEM 490.15, ITEM 407.01040009


ALTERED ON:	AFFIXED ON: 08/21/2025
SIGNATURE: STAMP:	SIGNATURE: STOLEN OF NEW PORTS

II LIM	DESCRIPTION	OHIL
404.0952	9.5 F2 TOP COURSE ASPHALT, 50 SERIES COMPACTION	TON
407.01040009	NON-TRACKING TACK COAT	GAL
418.7603	ASPHALT PAVEMENT JOINT ADHESIVE	LF
490.15	PRODUCTION COLD MILL SURFACE PLANING OF BITUMINOUS CONCRETE	SY
619.0901	TEMPORARY PAVEMENT MARKING STRIPES (TRAFFIC PAINT)	LF
627.50140008	SAWCUTTING PAVEMENT	LF
635.0403225	RECESS DIAMOND GRINDING FOR INLAID PAVEMENT MARKINGS	LF
649.01	MILLED IN AUDIBLE ROADWAY DELINEATION (MIARDS)	LF
685.11060025	WHITE EPOXY REFLECTORIZED PAVEMENT STRIPES 6' x 20 MILS	LF
685.12060025	YELLOW EPOXY REFLECTORIZED PAVEMENT STRIPES 6' x 20 MILS	LF
685.17070025	WHITE HIGHLY REFLECTORIZED TRIPLE DROP EPOXY PAVEMENT STRIPES 6" x 20 MILS	LF
685.17080025	YELLOW HIGHLY REFLECTORIZED TRIPLE DROP EPOXY PAVEMENT STRIPES 6" x 20 MILS	LF

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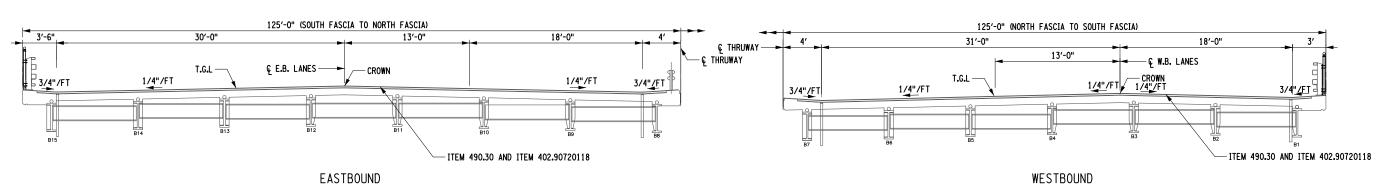
- 1. CROSS SLOPES MAY VARY NORMAL CROWN TO FULL SUPERELEVATION (BOTH BANKED LEFT AND RIGHT), THE PROPOSED TRAVEL LANE AND SHOULDER CROSS SLOPE SHALL MATCH THE EXISTING CROSS SLOPE IN ALL CASES.
- 2. TEMPORARY PAVEMENT MARKING STRIPES (TRAFFIC PAINT) ARE REQUIRED WHEN PERMANENT STRIPING LANES ARE REMOVED AND WILL BE INSTALLED PRIOR TO OPENING TRAVEL LANES TO TRAFFIC. PAYMENT UNDER 619.0901. REFER TO STANDARD SHEET TA 685-04.
- 3. ALL DEBRIS ON MILLED SURFACE SHALL BE REMOVED IN ACCORDANCE WITH SECTION 490-COLD MILLING OF THE NYSDOT STANDARD SPECIFICATIONS.
- 4. THE CONTRACTOR SHALL ALIGN THE PROPOSED LONGITUDINAL JOINTS WITH EXISTING LONGITUDINAL JOINTS. SEE DTL-9 FOR DETAIL ON CONSTRUCTION
- 5. PLACE TACK COAT ON ALL EXPOSED SURFACES WHICH WILL BE IN CONTACT WITH NEW ASPHALT, COST TO BE PAID FOR UNDER ITEM 407.01040009, FOR APPLICATION RATES, SEE TABLE 407-1 OF NYSDOT SPECIAL SPECIFICATION.
- 6. ITEM 418.7603, ASPHALT JOINT ADHESIVE, SHALL BE PLACED ON CENTERLINE JOINT AND INTERFACE BETWEEN DRIVING AND RAMP LANES.
- 7. PERMANENT PAVEMENT STRIPES ARE TO BE REPLACED IN KIND AFTER ALL MILL AND INLAY OPERATIONS ARE COMPLETED, COST TO BE PAID FOR UNDER ITEMS 685.17070025 AND 685.17080025. RAMP STRIPES SHALL BE PAID UNDER 685.11060025 AND 685.12060025. ALL PAVEMENT MARKINGS SHALL BE INSTALLED PER NYSTA STANDARD SHEET TA 685-01.

	IT IS A VIOLATION OF LAW FOR ANY PERSON, UNLESS THEY ARE ACTING		REVISIONS			NEW   Thruway	TITLE OF PROJECT 1R MILL AND INLAY, SAFETY IMPROVEMENTS,	CONTRACT NUMBER:
1	UNDER THE DIRECTION OF A LICENSED PROFESSIONAL ENGINEER, ARCHITECT, LANDSCAPE ARCHITECT, OR LAND SURVEYOR, TO ALTER AN	DATE	DESCRIPTION	BY	SYM.	NEW YORK Thruway STATE Authority	AND MISC. WORK	TAB 25-31
	ITEM IN ANY WAY. IF AN ITEM BEARING THE STAMP OF A LICENSED PROFESSIONAL IS ALTERED. THE ALTERING ENGINEER, ARCHITECT.					<b>STATE</b> Authority	MP 416.90 TO MP 419.40	DATE: 08/20/25
	LANDSCAPE ARCHITECT, OR LAND SURVEYOR SHALL STAMP THE DOCUMENT						TITLE OF DRAWING	06/20/25
	AND INCLUDE THE NOTATION "ALTERED BY" FOLLOWED BY THEIR SIGNATURE, THE DATE OF SUCH ALTERATION. AND A SPECIFIC DESCRIPTION OF THE						PROPOSED TYPICAL SECTIONS	DRAWING NUMBER:
-	ALTERATION.						1	TYP-7

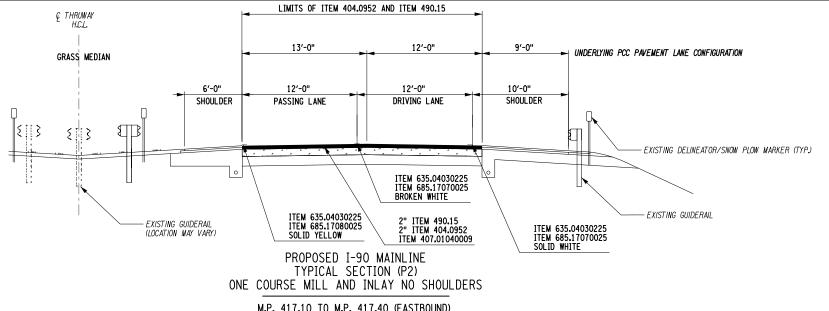

M.P. 417.10 TO M.P. 417.40 (EASTBOUND) M.P. 417.60 TO M.P. 417.74 (EASTBOUND) M.P. 417.04 TO M.P. 417.12 (WESTBOUND) M.P. 417.30 TO M.P. 417.56 (WESTBOUND)

N.T.S LOOKING IN DIRECTION OF TRAVEL.



PROPOSED BIN 5030279
TYPICAL SECTION
1 1/2" MILL AND WATERPROOF ASPHALT OVERLAP

M.P. 416.94
N.T.S
LOOKING IN DIRECTION OF TRAVEL.

- ITEM 404.0952, ITEM 490.15, ITEM 407.01040009

ALTERED ON:	AFFIXED ON: 09/11/2025
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IIEM	DESCRIPTION	UNII
402.90720118	WATERPROOFING BRIDGE DECK OVERLAY F2, 70 SERIES COMPACTION	TON
404.0952	9.5 F2 TOP COURSE ASPHALT, 50 SERIES COMPACTION	TON
407.01040009	NON-TRACKING TACK COAT	GAL
418.7603	ASPHALT PAVEMENT JOINT ADHESIVE	LF
490.15	PRODUCTION COLD MILL SURFACE PLANING OF BITUMINOUS CONCRETE	SY
490.30	MISCELLANEOUS COLD MILLING OF BITUMINOUS CONCRETE	SY
619.0901	TEMPORARY PAVEMENT MARKING STRIPES (TRAFFIC PAINT)	LF
635.0403225	RECESS DIAMOND GRINDING FOR INLAID PAVEMENT MARKINGS	LF
685.11060025	WHITE EPOXY REFLECTORIZED PAVEMENT STRIPES 6' x 20 MILS	LF
685.12060025	YELLOW EPOXY REFLECTORIZED PAVEMENT STRIPES 6' x 20 MILS	LF
685.17070025	WHITE HIGHLY REFLECTORIZED TRIPLE DROP EPOXY PAVEMENT STRIPES 6" x 20 MILS	LF
685.17080025	YELLOW HIGHLY REFLECTORIZED TRIPLE DROP EPOXY PAVEMENT STRIPES 6" x 20 MILS	LF

NOTES:

- 1. CROSS SLOPES MAY VARY NORMAL CROWN TO FULL SUPERELEVATION (BOTH BANKED LEFT AND RIGHT), THE PROPOSED TRAVEL LANE AND SHOULDER CROSS SLOPE SHALL MATCH THE EXISTING CROSS SLOPE IN ALL CASES.
- 2. TEMPORARY PAVEMENT MARKING STRIPES (TRAFFIC PAINT) ARE REQUIRED WHEN PERMANENT STRIPING LANES ARE REMOVED AND WILL BE INSTALLED PRIOR TO OPENING TRAVEL LANES TO TRAFFIC. PAYMENT UNDER 619.0901. REFER TO STANDARD SHEET TA 685-04.
- 3. ALL DEBRIS ON MILLED SURFACE SHALL BE REMOVED IN ACCORDANCE WITH SECTION 490-COLD MILLING OF THE NYSDOT STANDARD SPECIFICATIONS.
- 4. THE CONTRACTOR SHALL ALIGN THE PROPOSED LONGITUDINAL JOINTS WITH EXISTING LONGITUDINAL JOINTS. SEE DTL-9 FOR DETAIL ON CONSTRUCTION OF LONGITUDINAL JOINTS.
- 5. PLACE TACK COAT ON ALL EXPOSED SURFACES WHICH WILL BE IN CONTACT WITH NEW ASPHALT, COST TO BE PAID FOR UNDER ITEM 407.01040009, FOR APPLICATION RATES, SEE TABLE 407-1 OF NYSDOT SPECIAL SPECIFICATION.
- 6. ITEM 418.7603, ASPHALT JOINT ADHESIVE, SHALL BE PLACED ON CENTERLINE JOINT AND INTERFACE BETWEEN DRIVING AND RAMP LANES.
- 7. PERMANENT PAVEMENT STRIPES ARE TO BE REPLACED IN KIND AFTER ALL MILL AND INLAY OPERATIONS ARE COMPLETED, COST TO BE PAID FOR UNDER ITEMS 685.17070025 AND 685.17080025. RAMP STRIPES SHALL BE PAID UNDER 685.11060025 AND 685.12060025. ALL PAVEMENT MARKINGS SHALL BE INSTALLED PER NYSTA STANDARD SHEET TA 685-01.

IT IS A VIOLATION OF LAW FOR ANY PERSON, UNLESS THEY ARE ACTING		REVISIONS			NFW Throngs	TITLE OF PROJECT 1R MILL AND INLAY, SAFETY IMPROVEMENTS,	CONTRACT NUMBER:
UNDER THE DIRECTION OF A LICENSED PROFESSIONAL ENGINEER, ARCHITECT, LANDSCAPE ARCHITECT, OR LAND SURVEYOR, TO ALTER AN	DATE	DESCRIPTION	BY	SYM.	NEW Thruway STATE Authority	AND MISC. WORK	TAB 25-31
ITEM IN ANY WAY. IF AN ITEM BEARING THE STAMP OF A LICENSED PROFESSIONAL IS ALTERED. THE ALTERING ENGINEER. ARCHITECT.					<b>STATE</b> Authority	MP 416.90 TO MP 419.40	DATE:
LANDSCAPE ARCHITECT, OR LAND SURVEYOR SHALL STAMP THE DOCUMENT						TITLE OF DRAWING PROPOSED TYPICAL SECTIONS	08/20/25
AND INCLUDE THE NOTATION "ALTERED BY" FOLLOWED BY THEIR SIGNATURE, THE DATE OF SUCH ALTERATION, AND A SPECIFIC DESCRIPTION OF THE						BIN 5030279	DRAWING NUMBER:
ALTERATION.							TYP-8

GN SUPERVISOR: KEITH GAWRONSKI

## New York State Thruway Authority Standard Sheets

The following NYS Thruway Authority standard sheets, marked with an "X" in first column, apply to this project.

Х	SHEET NO.	SUBJECT
Χ	TA 201-01	Clearing and Grubbing (Dwg. CG)
Х	TA 203-01	Shoulder Backup 1R Projects (Dwg. SB)
	TA 203-02	Slope Flattening Details
Х	TA 404-01	Highway Pavement Repair Details (Dwg. PRD)
Χ	TA 404-02	Bridge Deck Wearing Course Resurfacing (Dwg. BDR)
	TA 404-03	Overhead Bridge Underclearance Improvement (Dwg. BU)
	TA 603-01	Culvert Extension Details
	TA 605-01	Underdrain Details
	TA 606-01	Modified Thrie Beam (Mod.) Guiderail (Dwg. GR-1)
	TA 606-02	Vacant
	TA 606-03	Corrugated Median Barrier to Corrugated Beam Guide Railing Transition Detail D (Dwg. GR-4)
	TA 606-04	Box Beam to 42" Single Slope Half Section Concrete Barrier Pier Protection (Dwg. GR-5)
	TA 606-05	HPBO (Mod.) Corrugated Beam to 42" Single Slope Half Section Concrete Barrier Pier Protection (Dwg. GR-6)
X	TA 606-06	Typical U-Turn Median Rail Layout and Roadway Transverse Section
	TA 606-07	Modified Thrie Beam Guiderail with Rock Rail
	TA 606-08 TA 611-01	Transition HPBO Corrugated Beam Median Guide Railing to HPBO Corrugated Beam Guide Railing
	TA 614-01	Living Snow Fences  Tree Removal
X	TA 619-01	Work Zone Traffic Control Tables & Legend
X	TA 619-02	General Work Zone Traffic Control Notes & Channelizing Devices
X	TA 619-03	Shoulder Closure Short-Term or Intermediate-Term Stationary
	TA 619-04	Shoulder Closure Short-Duration Stationary and Mobile
Х	TA 619-05	Signing & Delineation for Shoulder Work Spaces with Temporary Concrete Barrier
	TA 619-06	Work Beyond Shoulder
Х	TA 619-07	Be Prepared to Stop and Uneven Lanes Signing
Х	TA 619-08	Single Lane Closure Short- or Intermediate-Term Stationary: 65 MPH Zone
	TA 619-09	Double Lane Closure Short- or Intermediate-Term Stationary: 65 MPH Zone
	TA 619-10	Center Lane Closure Short- or Intermediate-Term Stationary: 65 MPH Zone
	TA 619-11	Lane Shift: 65 MPH Zone
	TA 619-12	Single Lane Closure Short- or Intermediate-Term Stationary: 55 MPH Zone
	TA 619-13	Double Lane Closure Short- or Intermediate-Term Stationary: 55 MPH Zone
	TA 619-14	Center Lane Closure Short- or Intermediate-Term Stationary: 55 MPH Zone
<u> </u>	TA 619-15	Lane Shift: 55 MPH Zone
X	TA 619-16	Work Zone Traffic Control at Interchanges, Service Areas and Parking Areas
X	TA 619-17	Work Zone Traffic Control for Miscellaneous Operations
X	TA 619-18	Mobile Lane Closure  Mobile Lane Closure: Narrow Shoulder Area
Х	TA 619-19 TA 619-20	Short-Duration Lane Closure
<u> </u>	TA 619-21	Short-Duration Double Lane Closure
Х	TA 619-22	Work Zone Traffic Control Guide for Pavement Striping Operations
Х	TA 619-23	Mobile Lane Closure for Pavement Striping Operations
	TA 619-24	Mobile Lane Closure for Pavement Striping Operations: Narrow Shoulder Area
Х	TA 619-25	Work Zone Traffic Control for Pavement Striping Operations at Interchanges, Service Areas and Parking Areas
	TA 619-26	Temporary Rock Catchment Barrier (Sheets 1-3)
	TA 619-27	Workzone Overhead Gantry Signing
	TA 619-30	New York Division Traffic Management Tables (Sheets 1-28)
	TA 619-31	Albany Division 1,150 Veh/Hr/Lane Traffic Management Tables (Sheets 1-18)
	TA 619-32	Albany Division 1,300 Veh/Hr/Lane Traffic Management Tables (Sheets 1-18)
<u> </u>	TA 619-33	Syracuse Division 1,150 Veh/Hr/Lane Traffic Management Tables (Sheets 1-18)
<u> </u>	TA 619-34	Syracuse Division 1,300 Veh/Hr/Lane Traffic Management Tables (Sheets 1-18)
<u></u>	TA 619-35	Buffalo Division 1,150 Veh/Hr/Lane Traffic Management Tables (Sheets 1-37)
X	TA 619-36	Buffalo Division 1,300 Veh/Hr/Lane Traffic Management Tables (Sheets 1-37)
$\vdash$	TA 625-01	ROW and Survey Markers
$\vdash$	TA 645-01	Wrong Way Deterrence Sign
$\vdash$	TA 646-01	Reference Marker Details (Sheets 1-2)
$\vdash$	TA 670-01	Fiber Optic & Backbone Handhole Relocation Details
$\vdash$	TA 680-01 TA 680-02	Inductance Loop Installation Highway Advisory Radio (Sheets 1-9)
X	TA 680-02 TA 685-01	Pavement Marking Details: Asphalt and Concrete Pavement (Sheets 1-2)
Ĥ	TA 685-01	Pavement Marking Details: Tapered Acceleration and Deceleration Lanes
$\vdash$	TA 685-02	Vacant
X	TA 685-03	Temporary Pavement Marking Details
	TA 690-01	Loop and Treadle Plan (Sheets 1-2)
	TA 690-02	Toll Lane Slab Reinforcement Plan
	TA 690-03	10 ft Treadle Frame (Sheets 1-4)

The officially adopted New York State Thruway Authority Standard Sheets book is available on the Thruway Authority's website at: http://www.thruway.ny.gov/business/contractors/standard-sheets/index.shtml

## REV. 02/25

## Highway Work Type

The marked types & treatments apply to the indicated milepost range(s) below.

MILEPOST FROM:	416.90 WB	419.40 EB					
TO:	419.40 WB	416.86 EB					
PROJECT TYPE	Х	Х	Х	Х	Х	Х	Х
1R Resurfacing	Х	Х					
2R Resurfacing							
3R Rehabilitation							
Reconstruction							
Safety Improvements	Х	Х					
Drainage	Х	Х					
Rock Slope Remediation							
Pavement Striping							
Other:							
PAVEMENT TREATMENT	х	X	Х	Х	Х	Х	х
Isolated Pavement Repairs Only							
Thin Overlay without Milling							
Thin Overlay with Milling							
1" Mill & Inlay without Shoulders							
1" Mill & Inlay with Shoulders							
2" Mill & Inlay without Shoulders	Х						
2" Mill & Inlay with Shoulders							
Mill to Concrete with 4" Overlay							
·							
Mill to Concrete with 4" Overlay							
Mill to Concrete with 4" Overlay Mill to Concrete with 4.5" Overlay							

## Structure Work Type

Other:

The marked types apply to the indicated milepost(s) below.

MILEPOS	416.94	417.27	418.73	418.98			
PROJECT TYPE	Х	Х	Х	Х	Х	Х	Х
Bridge Washing							
Scour Protection							
Channel Cleaning							
Railing System							
Protective Screening							
Painting							
Steel Repair							
Wearing Surface Treatment							
Deck Repairs							
Joint Rehabilitation			Х	Х			
Joint Replacement							
Bearing Rehabilitation							
Bearing Replacement							
Hanger Pin Replacement							
Security							
Seismic Retrofit							
Substructure Rehabilitation							
Electrical							
Cathodic Protection System							
Fendor or Pier Protection System							
Deck Replacement							
Superstructure Replacement							
Bridge Replacement							
Added Bridge (New Location)							
Abandoned Bridge							
Other:	Х	Х					

## New York State Department of Transportation Standard Sheets

The latest revisions of the New York State Department of Transportation Standard Sheets maintained by NYSDOT, which are current as of the Standard Specifications adoption date shown on the Proposal cover, shall be considered to be in effect. All pay items and work contained in the Contract and any additional pay items and work encountered during the course of the Contract shall be subject to the applicable standard sheet(s) unless otherwise specified in the Contract documents.

The officially adopted New York State Department of Transportation Standard Sheets book is available on the NYSDOT website at:

 $\underline{\text{https://www.dot.ny.gov/main/business-center/engineering/specifications/busi-e-standards-usc}}$ 

	REVISIONS	•		NEW Thruway	TITLE OF PROJECT 1R MILL AND INLAY, SAFETY IMPROVEMENTS,	CONTRACT NUMBER:
ATE	DESCRIPTION	BY	SYM.		AND MISC. WORK	TAB 25-31
				<b>STATE</b> Authority		DATE:
					TITLE OF DRAWING	08/20/25
					NYSTA STANDARD SHEETS LISTING	DRAWING NUMBER:
					AND WORK TYPE TABLES	SS-1

## GENERAL NOTES:

- 1. MATERIAL AND CONSTRUCTION SPECIFICATIONS NEW YORK STATE DEPARTMENT OF TRANSPORTATION STANDARD SPECIFICATIONS (U.S. CUSTOMARY) DATED AS SHOWN ON THE FRONT COVER OF THE PROPOSAL, EXCEPT AS MODIFIED IN THESE PLANS AND THE PROPOSAL.
- 2. THE CONTRACTOR SHALL BE REQUIRED TO COORDINATE ITS WORK WITH OTHER CONTRACTORS AND AUTHORITY MAINTENENCE FORCES, AND SHALL SCHEDULE ITS OPERATIONS SO AS TO CAUSE MINIMUM
- 3. NO EMBANKMENT AREAS FOR SURPLUS MATERIALS ARE AVAILABLE FOR THIS CONTRACT WITHIN THE AUTHORITY'S RIGHT OF WAY. THEREFORE, ALL MATERIAL TO BE REMOVED FROM THE JOB SITE SHALL BE DISPOSED OF BY THE CONTRACTOR OFF THE AUTHORITY'S PROPERTY. THE CONTRACTOR SHALL COMPLY WITH ALL LOCAL AND STATE REGULATIONS THAT APPLY TO THE AREA CHOSEN FOR THE DISPOSAL OF THIS MATERIAL. ALL COST ASOCIATED WITH THE SPOIL AREA AND REMOVAL OF THE SPOIL MATERIAL SHALL BE INCLUDED IN THE VARIOUS ITEMS OF THE CONTRACT.

### RECONSTRUCTION NOTES:

- 1. THE CONTRACTOR SHALL EXAMINE AND VERIFY, IN THE FIELD, ALL CONDITIONS AND DIMENSIONS. DIMENSIONS OF THE EXISTING STRUCTURES SHOWN ON THESE PLANS ARE FOR GENERAL REFERENCE ONLY. THEY HAVE BEEN TAKEN FROM THE ORIGINAL CONSTRUCTION OR SUBSEQUENT REHABILITATION ONLY. THEY HAVE BEEN TAKEN FROM THE ORIGINAL CONSTRUCTION OR SUBSEQUENT REHABILITATION DRAWINGS AND ARE NOT GUARANTEED. THE CONTRACTOR SHALL TAKE ALL SUCH FIELD MEASUREMENTS TO ASSURE PROPER FIT OF THE FINISHED WORK, AND THE CONTRACTOR SHALL ASSUME FULL RESPONSIBILITY FOR THEIR ACCURACY. IF FIELD CONDITIONS AND DIMENSIONS DIFFER FROM THOSE SHOWN ON THE PLANS, THE CONTRACTOR SHALL USE THE FIELD CONDITIONS AND DIMENSIONS AND MAKE THE APPROPRIATE CHANGES TO THOSE SHOWN ON THE PLANS, AS APPROVED BY THE ENGINEER, WHEN SHOP DRAWINGS BASED ON FIELD MEASUREMENTS ARE SUBMITTED FOR APPROVAL, THE FIELD MEASUREMENTS MADE SHALL BE INDICATED ON THE SHOP DRAWINGS SUBMITTED FOR APPROVAL, THE FIELD MEASUREMENTS MADE SHALL BE INDICATED ON THE SHOP DRAWINGS SUBMITTED FOR REFERENCE OF THE REVIEWER.
- 2. THE CONTRACTOR'S ATTENTION IS DIRECTED TO THE FACT THAT, DUE TO THE NATURE OF RECONSTRUCTION PROJECTS, THE EXACT EXTENT OF CONSTRUCTION WORK CANNOT ALWAYS BE ACCURATELY DETERMINED PRIOR TO COMMENCEMENT OF WORK, THESE CONTRACT DOCUMENTS HAVE BEEN PREPARED BASED ON FIELD INSPECTION AND OTHER INFORMATION AVAILABLE AT THE TIME. ACTUAL FIELD CONDITIONS MAY REQUIRE MODIFICATIONS TO CONSTRUCTION DETAILS AND WORK QUANTITIES. THE CONTRACTOR SHALL PERFORM THE WORK IN ACCORDANCE WITH FIELD CONDITIONS.
- 3. THE CONTRACTOR WILL BE HELD RESPONSIBLE FOR ALL DAMAGE TO THE MATERIALS WHICH ARE TO REMAIN IN PLACE. THE CONTRACTOR SHALL PERFORM ALL WORK WITH CARE SO THAT ANY MATERIALS WHICH ARE TO REMIAN IN PLACE, OR WHICH ARE TO REMAIN THE PROPERTY OF THE AUTHORITY, WILL NOT BE DAMAGED. IF THE CONTRACTOR DAMAGES ANY MATERIALS WHICH ARE TO REMAIN IN PLACE, OR WHICH ARE TO REMAIN THE PROPERTY OF THE AUTHORITY, THE DAMAGED MATERIAL SHALL BE REPAIRED OR REPLACED IN A MANNER SATISFACTORY TO THE ENGINEER AT THE EXPENSE OF THE CONTRACTOR.
- 4. THE CONTRACTOR SHALL CONDUCT HIS/HER REMOVAL OPERATIONS TO THE SATISFACTION OF THE ENGINEER SO AS NOT TO UNDULY DISTURB UNDERLYING MATERIALS WHICH ARE TO REMAIN IN PLACE.

## MISCELLANEOUS NOTES:

- 1. THE CONTRACTOR IS ADVISED THAT ADDITIONAL "NOTES" WILL BE FOUND ON SUBSQUENT SHEETS OF THE CONTRACT PROPOSAL AND SUCH "NOTES", WHILE PERTAINING TO THE SPECIFIC SHEETS THEY ARE PLACED ON, ALSO SUPPLEMENT THE GENERAL NOTES LISTED HEREIN.
- 2. PRIVATE VEHICLES OWNED BY THE CONTRACTOR OR THE CONTRACTOR'S WORKERS SHALL BE PARKED, DURING WORKING AND NON-WORKING HOURS, OUTSIDE THE WORK ZONE AND OFF THE TRAVELED WAY.

## WORK TO BE DONE:

THE FOLLOWING IS THE GENERAL DESCRIPTION OF THE WORK TO BE DONE UNDER THIS CONTRACT, THIS LIST IS INTENDED TO GIVE THE CONTRACTOR A GENERAL DESCRIPTION OF THE WORK INVOLVED IN THIS CONTRACT AND IS NOT A COMPLETE LISTING OF ALL WORK TO BE DONE, ALL WORK SHALL BE DONE IN ACCORDANCE WITH THE CONTRACT DOCUMENTS EVEN THOUGH NOT SPECIFICALLY MENTIONED IN THE LIST.

- 1. PROVIDE BASIC WORK ZONE TRAFFIC CONTROL ACCORDING TO THE CONTRACT DOCUMENTS AND AS ORDERED BY THE ENGINEER.
- 2. PROVIDE FULL DEPTH AND PARTIAL DEPTH PAVEMENT REPAIRS, AS NEEDED, PRIOR TO MILLING AND INLAYING OPERATIONS.
- 3. PERFORM VERTICAL CLEARANCE IMPROVEMENTS THROUGH RECONSTRUCTION IN BOTH EB AND WB DIRECTIONS AT THE FOLLOWING OVERHEAD BRIDGE:
  - MP 417.27 BIN 5512160 EXIT 49 RAMP
- 4. REPLACE EXISTING BOX BEAM MEDIAN BARRIER ON EXIT 49 RAMP WITH NEW SINGLE SLOPE CONCRETE MEDIAN
- 5. REPLACE EXISTING GUIDE RAIL IN FRONT OF GANTRY ON EXIT 49 RAMP WITH NEW SINGLE SLOPE CONCRETE MEDIAN BARRIER AND TRANSITIONS.
- 6. PERFORM CULVERT REPAIRS TO CIN 417.63011XX.
- 7. CLEAN CLOSED DRAINAGE SYSTEMS AND DRAINAGE STRUCTURES.
- 8. PERFORM 2" PRODUCTION MILL AND 2" INLAY TO MAINLINE WITHOUT SHOULDERS.
- 9. PAVING LIMITS ARE THE FOLLOWING: -MP 419.4 TO MP 416.86 EB -MP 416.9 TO MP 419.4 WB -COLD MILL TO MATCH EXISTING PAVEMENT (EB & WB)
- 10. PERFORM 2" MILL AND 2" INLAY TO EXIT 49 RAMP WITH SHOULDERS, DECELERATION AND ACCELERATION LANES.
- 11. PERFPORM 1 1/2" MILL AND WATERPROOF ASPHALT OVERLAY TO BIN 5030279 NY RTE 78 TRANSIT RD.
- 12. REPLACE BRIDGE JOINT SEALS AT THE FOLLOWING BRIDGES:
- -BIN 5511929 WEHRLE DR. -BIN 5511919 ELLICOTT CREEK
- 13. REPLACE ALL PAVEMENT MARKINGS.
- 14. REPLACE EXISITNG GUIDE RAIL WITH NEW GUIDE RAIL AT VARIOUS LOCATIONS.
- 15. REPLACE VARIOUS GROUND MOUNTED TRAFFIC SIGNAGE.
- 16. PERFORM MISCELLANEOUS WORK AS ORDERED BY THE ENGINEER.
- 17. CLEAN AND RESTORE ALL DISTURBED AREAS.

ALTERED ON:	AFFIXED ON: 08/21/2025	
SIGNATURE: STAMP:	SIGNATURE: STANDING OF NEW CONTROL O	

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	REVISIONS			NEW Thruway	1R MILL AND INLAY, SAFETY IMPROVEMENTS,
DATE	DESCRIPTION	BY	SYM.		AND MISC. WORK
				<b>STATE</b> Authority	MP 416.90 TO MP 419.40
					TITLE OF DRAWING  GENERAL NOTES
					GLINEINOTES

TAB 25-31

08/20/25

GNN-1

## **EROSION AND SEDIMENT CONTROL NOTES:**

- 1. CONTRACTOR SHALL CLEAN SEDIMENT AND DEBRIS OFF ALL PAVED SURFACES AT THE END OF EACH DAY AS DIRECTED BY THE ENGINEER. COST OF CLEANING SHALL BE INCLUDED IN THE VARIOUS ITEMS OF THE CONTRACT.
- 2. THE CONTRACTOR SHALL SUBMIT FOR APPROVAL TO THE ENGINER A WRITTEN PROPOSED MEASURES FOR TEMPORARY AND PERMANENT EROSION AND SEDIMENT CONTROL WORK AND SCHEDULE OF OPERATIONS AS REQUIRED BY SECTION 209 OF THE NYSDOT STANDARD SPECIFICATIONS.
- 3. INSPECTION, PERIODIC CLEANING AND MAINTENANCE OF TEMPORARY SOIL EROSION AND POLLUTION CONTROL DEVICES SHALL BE PERFORMED ON A SCHEDULE BASIS IN ACCORDANCE WITH SECTION 209 OF THE NYSDOT SPECIFICATION. THE COST OF INSTALLING, CLEANING AND REMOVING TEMPORARY SOIL EROSION AND WATER POLLUTION CONTROL DEVICES SHALL BE PAID FOR UNDER THE ITEMS SHOWN.
- 4. ALL NECESSARY PRECAUTIONS SHALL BE TAKEN TO PREVENT CONTAMINATION OF ANY STREAM OR WATERWAY BY SILT, SEDIMENT, FUELS, SOLVENTS, LUBRICANTS, EPOXY COATINGS, CONCRETE OR SLURRY LEACHATE OR ANY OTHER POLLUTANT ASSOCIATED WITH CONSTRUCTION AND CONSTRUCTION PROCEDURES.
- 5. ALL CONTROLS SHALL BE PLACED PRIOR TO STARTING EARTHWORK OPERATIONS AND SHALL REMAIN IN PLACE UNTIL NEW SLOPES ARE STABILIZED WITH SEEDING AND/OR SLOPE PROTECTION.
- 6. CONTRACTOR SHALL BE RESPONSIBLE FOR PROVIDING ANY ADDIITONAL EROSION CONTROL MEASURES THAT MAY BE REQUIRED OR AS ORDERED BY
- 7. CONTRACTOR STAGING AREAS SHALL BE EXISTING AREAS OF NON-DISTURBABLE COVER (I.E. ASPHALT MILLING, ASPHALT OR CONCRETE PAVEMENT).

  IF THE CONTRACTOR CREATES A STAGING AREA ON DISTURBABLE COVER (I.E. GRASS) THEN THE ENTIRE AREA SHALL BE ENCLOSED WITH SILT FENCE.
- 8. CONTRACTOR SHALL ESTABLISH A STABILIZED CONSTRUCTION ENTRANCE INTO AND OUT OF EACH WORK AREA AND EACH STAGING AREA CONSTRUCTED ON DURABLE COVER.
- 9. THE ALLOWABLE DISTURBANCE AREA IS 1.0 ACRE; THE CONTRACTOR IS RESPONSIBLE FOR APPLICABLE PERMITS IF ACREAGE OVER 1.0 ACRE IS EXCEEDED, AT NO COST TO THE AUTHORITY.

### UTILITY NOTES

- 1. LOCATIONS OF UTILITIES, PUBLIC AND/OR PRIVATE, INDICATED AS EXISTING AND/OR TO BE CONSTRUCTED AS SHOWN ON THE PLANS ARE APPROXIMATE ONLY. THEIR EXACT LOCATION SHALL BE DETERMINED IN THE FIELD. ADDITIONAL UTILITY LINES, WHETHER ABANDONED OR IN SERVICE, MAY EXIST AND IT SHALL BE THE CONTRACTOR'S RESPONSIBILITY TO CONDUCT HIS OPERATIONS AND TAKE THE NECESSARY PRECAUTIONS TO PREVENT INTERFERENCE WITH OR DAMAGE TO THESE OR OTHER FACILITIES DURING THE COURSE OF CONSTRUCTION.
- 2. IN THE EVENT THE CONTRACTOR DAMAGES AN EXISTING UTILITY SERVICE CAUSING AN INTERRUPTION IN SAID SERVICE, HE/SHE SHALL IMMEDIATELY STOP WORK AND RESTORE SERVICE AND MAY NOT COMMENCE HIS/HER WORK OPERATION UNTIL SERVICE IS RESTORED.
- 3. THE METHOD OF REMOVAL OF EXISTING ROADWAY OR SHOULDER PAVEMENT IN THE IMMEDIATE VICINITY OF UNDERGROUND UTILITIES SHALL BE SUBJECT TO THE APPROVAL OF THE ENGINEER.
- 4. THE AUTHORITY'S FIBER OPTIC INFRASTRUCTURE RUNS ALONG THE RIGHT SIDE OF THE WESTBOUND LANES.
- 5. THE AUTHORITY'S FIBER OPTIC INFRASTRUCTURE IS LOCATED WITHIN THE ENTIRE WORK LIMITS OF THIS PROJECT, THE CONTRACTOR IS ADVISED TO CONTACT UDIG NY AT 811 OR 1-800-962-7962, PRIOR TO ANY EXCAVATION.
- 6. WARNING EXISTING UNDERGROUND UTILITIES MAY BE LOCATED WITHIN THE WORK LIMITS AND MAY BE ENCOUNTERED DURING CONSTRUCTION. EXTREME CARE SHOULD BE EXERCISED TO AVOID DAMAGE TO THESE FACILITIES. ANY DAMAGE SHALL BE IMMEDIATELY REPORTED TO THE ENGINEER AND TO THE OWNER TO THE UTILITY. THE CONTRACTOR IS RESPONSIBLE FOR THE COST OF REPAIRS. IN ACCORDANCE WITH 16NYCRR, PART 753, "PROTECTION OF UNDERGROUND FACILITIES". UDIG NY SHALL BE CONTACTED PRIOR TO ANY EXCAVATION AT 1-800-962-7962 OR 811. THRUWAY AUTHORITY UTILITIES WILL BE LOCATED BY THRUWAY STAFF.

## CONCRETE MEDIAN BARRIER NOTES:

- 1. IF CONTRACTOR CHOOSES TO UTILIZE "CAST IN PLACE" METHOD FOR SINGLE SLOPE CONCRETE MEDIAN BARRIER (ITEM 606.3041), NO HORIZONTAL JOINT WILL BE ALLOWED TO BE LOCATED BETWEEN THE TOP OF THE BARRIER TO THE BOTTOM OF 9" EMBEDMENT. THEREFORE, THE CROSS SECTION FROM TOP OF BARRIER TO BOTTOM OF 9" EMBEDMENT MUST BE CAST IN PLACE AS ONE MONOLITHIC POUR.
- 2. IF THE CONTRACTOR PROPOSES TO USE A "FOOTER", THE "FOOTER" SHALL BE BELOW THE 9" EMBEDMENT.

ALTERED ON:	AFFIXED ON: 08/21/2025
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	IT IS A VIOLATION OF LAW FOR ANY PERSON, UNLESS THEY ARE ACTING
ı	UNDER THE DIRECTION OF A LICENSED PROFESSIONAL ENGINEER,
ı	ARCHITECT, LANDSCAPE ARCHITECT, OR LAND SURVEYOR, TO ALTER AN
ı	ITEM IN ANY WAY. IF AN ITEM BEARING THE STAMP OF A LICENSED
ı	PROFESSIONAL IS ALTERED, THE ALTERING ENGINEER, ARCHITECT,
ı	LANDSCAPE ARCHITECT, OR LAND SURVEYOR SHALL STAMP THE DOCUMENT
ı	AND INCLUDE THE NOTATION "ALTERED BY" FOLLOWED BY THEIR SIGNATURE,
ı	THE DATE OF SUCH ALTERATION, AND A SPECIFIC DESCRIPTION OF THE
ı	ALTERATION

REVISIONS			NEW   There were a	TITLE OF PROJECT 1R MILL AND INLAY, SAFETY IMPROVEMENTS,	CONTRACT NUMBER:
DESCRIPTION	BY	SYM.	YORK I Inruway	AND MISC. WORK	TAB 25-31
			Authority	MP 416.90 TO MP 419.40	DATE:
				TITLE OF DRAWING	08/20/25
				GENERAL NOTES	DRAWING NUMBER:
					GNN-2
				DESCRIPTION BY SYM. NOW YORK Thruway Authority	DESCRIPTION BY SYM.  NEW YORK STATE AUTHORITY  Thruway Authority  AND INLAY, SAFETY IMPROVEMENTS, AND MISC, WORK  LOCATION OF PROJECT MP 416,90 TO MP 419,40

SIGNATURE:
STANDARD OR 122/2025

SIGNATURE:
STANDARD OR 122/2025

							ASPHALT FULL DEPTH REPAIRS (416.9 to 419.4)													
Loca	ation	MP	Length (LF)	Width (LF)	Area (SF)	Depth (IN)	Sawcut (LF)	Excavation (CY)	Tack (Gal) (.06 App. Rate)	Binder (TON)	Base (TON)	Subbase (CY)	Comment							
1	T .						627.50140008	203.02	407.01040009	404.1979	404.3779	304.12								
	1	440.4.1.440.0	8	12	96	25.5	40	7.56	0.64	2.66	5.33 5.33	3.56	Full Depth Repair							
	2	419.1 to 419.0	8	12 12	96 96	25.5	40	7.56 7.56	0.64 0.64	2.66 2.66	5.33	3.56 3.56	Full Depth Repair							
	3		8	12	96	25.5	40 40	7.56	0.64	2.66	5.33	3.56	Full Depth Repair							
	5		8	12	96	25.5 25.5	40	7.56	0.64	2.66	5.33	3.56	Full Depth Repair							
	6		8	12	96	25.5	40	7.56	0.64	2.66	5.33	3.56	Full Depth Repair Full Depth Repair							
	7	418.9 to 418.8	8	12	96	25.5	40	7.56	0.64	2.66	5.33	3.56	Full Depth Repair							
	8		8	12	96	25.5	40	7.56	0.64	2.66	5.33	3.56	Full Depth Repair							
	9		8	12	96	25.5	40	7.56	0.64	2.66	5.33	3.56	Full Depth Repair							
	10	418.8 to 418.7	8	12	96	25.5	40	7.56	0.64	2.66	5.33	3.56	Full Depth Repair							
	11	418.7 to 418.6	20	12	240	25.5	64	18.89	1.60	6.66	13.32	8.89	Full Depth Repair							
	12		8	12	96	25.5	40	7.56	0.64	2.66	5.33	3.56	Full Depth Repair							
	13	447 6 to 447 E	8	12	96	25.5	40	7.56	0.64	2.66	5.33	3.56	Full Depth Repair							
	14	417.6 to 417.5	8	12	96	25.5	40	7.56	0.64	2.66	5.33	3.56	Full Depth Repair							
EB	15		8	12	96	25.5	40	7.56	0.64	2.66	5.33	3.56	Full Depth Repair							
	16	417.5 to 417.4	8	12	96	25.5	40	7.56	0.64	2.66	5.33	3.56	Full Depth Repair							
	17	711.5 10 411.4	8	12	96	25.5	40	7.56	0.64	2.66	5.33	3.56	Full Depth Repair							
	18	417.4 to 417.3	8	12	96	25.5	40	7.56	0.64	2.66	5.33	3.56	Full Depth Repair							
	19	411.4 to 411.0	8	12	96	25.5	40	7.56	0.64	2.66	5.33	3.56	Full Depth Repair							
	20	417.3 to 417.2	20	12	240	25.5	64	18.89	1.60	6.66	13.32	8.89	Full Depth Repair							
	21		8	12	96	25.5	40	7.56	0.64	2.66	5.33	3.56	Full Depth Repair							
	22	417.2 to 417.1	8	12	96	25.5	40	7.56	0.64	2.66	5.33	3.56	Full Depth Repair							
	23		8	12	96	25.5	40	7.56	0.64	2.66	5.33	3.56	Full Depth Repair							
	24		8	12	96	25.5	40	7.56	0.64	2.66	5.33	3.56	Full Depth Repair							
	25		8	12	96	25.5	40	7.56	0.64	2.66	5.33	3.56	Full Depth Repair							
	26		8	13	104	25.5	42	8.19	0.69	2.89	5.77	3.85	Full Depth Repair							
	27	417.0 to 416.9		12	96	25.5	40	7.56	0.64	2.66	5.33	3.56	Full Depth Repair							
	28		8	12	96	25.5	40	7.56	0.64	2.66	5.33	3.56	Full Depth Repair							
	29		8	13	104	25.5	42	8.19 7.56	0.69	2.89	5.77	3.85	Full Depth Repair							
	30	417.0 to 417.1	8	12 12	96 96	25.5	40	7.56	0.64 0.64	2.66 2.66	5.33 5.33	3.56 3.56	Full Depth Repair							
	31		8	12	96	25.5	40	7.56	0.64	2.66	5.33	3.56	Full Depth Repair							
	32	417.1 to 417.2		12	96	25.5	40	7.56	0.64	2.66	5.33	3.56	Full Depth Repair							
	33 34	417.1 (0 417.2	8	12	96	25.5 25.5	40 40	7.56	0.64	2.66	5.33	3.56	Full Depth Repair Full Depth Repair							
	35	417.2 to 417.3	20	12	240	25.5	64	18.89	1.60	6.66	13.32	8.89	Full Depth Repair							
	36		8	13	104	25.5	42	8.19	0.69	2.89	5.77	3.85	Full Depth Repair							
	37	417.5 to 417.6	8	12	96	25.5	40	7.56	0.64	2.66	5.33	3.56	Full Depth Repair							
	38		8	12	96	25.5	40	7.56	0.64	2.66	5.33	3.56	Full Depth Repair							
	39		8	12	96	25.5	40	7.56	0.64	2.66	5.33	3.56	Full Depth Repair							
WB	40		8	12	96	25.5	40	7.56	0.64	2.66	5.33	3.56	Full Depth Repair							
	41	417.6 to 417.7	8	12	96	25.5	40	7.56	0.64	2.66	5.33	3.56	Full Depth Repair							
	42		20	12	240	25.5	64	18.89	1.60	6.66	13.32	8.89	Full Depth Repair							
	43		8	12	96	25.5	40	7.56	0.64	2.66	5.33	3.56	Full Depth Repair							
	44	447 7 to 447 0	8	12	96	25.5	40	7.56	0.64	2.66	5.33	3.56	Full Depth Repair							
	45	417.7 to 417.8	8	13	104	25.5	42	8.19	0.69	2.89	5.77	3.85	Full Depth Repair							
	46	418.3 to 418.4	20	12	240	25.5	64	18.89	1.60	6.66	13.32	8.89	Full Depth Repair							
	47	418.8 to 418.9	8	12	96	25.5	40	7.56	0.64	2.66	5.33	3.56	Full Depth Repair							
	48		8	12	96	25.5	40	7.56	0.64	2.66	5.33	3.56	Full Depth Repair							
	49	419.3 to 419.4	8	12	96	25.5	40	7.56	0.64	2.66	5.33	3.56	Full Depth Repair							
	50	EB	8	12	96	25.5	40	7.56	0.64	2.66	5.33	3.56	Full Depth Repair							
	51		8	12	96	25.5	40	7.56	0.64	2.66	5.33	3.56	Full Depth Repair							
EXIT 49	52		8	12	96	25.5	40	7.56	0.64	2.66	5.33	3.56	Full Depth Repair							
RAMP	53	WB	8	12	96	25.5	40	7.56	0.64	2.66	5.33	3.56	Full Depth Repair							
	54		8	12	96	25.5	40	7.56	0.64	2.66	5.33	3.56	Full Depth Repair							
	55         8         12         96         25.5         40         7.56         0.64         2.66         5.33											3.56	Full Depth Repair							
						TOTALS	2,328	475	40	167	335	223								
					TOTALS F	PLUS 15%	2,677	546	46	192	385	257	1							

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THE DATE OF SUCH ALTERATION, AND A SPECIFIC DESCRIPTION OF THE ALTERATION.

		REVISIONS													
	DATE	DESCRIPTION	BY	SYM.											
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NEW YORK STATE	Thruway	TITLE OF PROJECT 1R MILL AND INLAY, SAFETY IMPROVEMENTS, AND MISC, WORK	CONTRACT NUMBER: TAB 25-31
SIAIE	Authority	MP 416.90 TO MP 419.40  TITLE OF DRAWING	DATE: 08/20/25
		MISCELLANEOUS TABLES	DRAWING NUMBER:
			10151-1

18	1
58	

														TABLE	OF GU	IDE R	AIL AI	ND ME	DIAN	BAR	RIER								
		START			END			APPROX.			12		7.								125							125	
RUN#	GNP	MP	SIDE	GNP	MP	SIDE	DIRECTION	PROPOSED WORK	568.70	606.10	606.100002	£   5	606.1203	606.2801	606.2802	606.3041	606.7101	606.72	606.73	606.74	606.79200125	606.7946	606.8805	606.8903	606.8905	606.9003	606.9004	606.92010	DESCRIPTION OF WORK
								LF	LF	LF	LF	LF E	EA EA	LF	EA	LF	LF	LF	LF	LF	EA	EA	EA	EA	EA	EA	EA	EA	
1	GP-1	419.342	LT	GP-2	418.989	LT	EB	1863.8						1750				1850							2				REPLACE CORR. MEDIAN BARRIER WITH HPBO FROM BIN 5511949 TO BIN 5511929
2	GP-2	418.964	LT	GP-3	418.738	LT	EB	1193.3						1013				1113							2				REPLACE CORR. MEDIAN BARRIER WITH HPBO FROM BIN 5511929 TO BIN 5544919
3	GP-3	418.738	LT	GP-3	418.707	LT	EB	163.7																				160	REPLACE SPLICE BOLTS
4	GP-4	418.436	RT	GP-4	418.430	RT	EB	31.7					1								1								REPLACE TYPE 3 BOX BEAM END ASSEMBLY
5	GP-5	418.045	LT	GP-6	417.885	LT	EB	844.8						801	1			801				1							NEW TRANSITION AND REPLACE CORR. MEDIAN BARRIER WITH HPBO
6	GP-6	417.971	RT	GP-6	417.967	RT	EB	21.1					1								1								REPLACE TYPE 3 BOX BEAM END ASSEMBLY
7	GP-6	417.910	LT	GP-6	417.710	LT	EB	1056.0						1157	1			1157				1							REPLACE CORR. MEDIAN BARRIER WITH HPBO
8	GP-8	417.364	RT	GP-8	417.359	RT	EB	26.4					1								1								REPLACE TYPE 3 BOX BEAM END ASSEMBLY
9	GP-8	417.215	LT	GP-9	416.950	LT	EB	1399.2						1288				1338							1				NEW TRANSITION AND REPLACE CORR. MEDIAN BARRIER WITH HPBO
																F	RAMP	'S											
		STA			STA																								
10	GP-8	797.450	LT	GP-10	1955.120	LT					1	120				990				2424	1		2						REPLACE BOX BEAM MEDIAN BARRIER WITH CONCRETE SINGLE SLOPE BARRIER AND TRANSITIONS
11	GP-11	2565.910	LT	GP-8	3365.150	LT						60				753				2424			1						REPLACE BOX BEAM MEDIAN BARRIER WITH CONCRETE SINGLE SLOPE BARRIER AND TRANSITIONS
12	GP-11	2289.920	RT	GP-11	2449.590	RT										100	148	3						1		1			INSTALL SINGLE SLOPE BARRIER AT GANTRY
13	GP-11	2346.320	RT	GP-11	2507.080	RT										100	196	3						2		1	1		INSTALL SINGLE SLOPE BARRIER AT GANTRY
14	GP-8	3295.870	RT	GP-8	3484.190	RT			34				1								1								EXTEND AND REPLACE BOX BEAM BRIDGE APPROACH RAILING
15	GP-8	3717.700	RT	GP-10	1074.350	RT			34	052			1						1021		1								REPLACE BOX BEAM BRIDGE APPROACH RAILING
16	GP-10	1479.220	RT	GP-10	3717.660	RT			34	953	126		1						71021		1								EXTEND REPLACE BOX BEAM BRIDGE APPROACH RAILING
17	GP-8	3369.230	RT	GP-8	3484.630	RT			34																				REPLACE BOX BEAM BRIDGE APPROACH RAILING AND TIE INTO EXISTING BOX BEAM
								TOTALS	136	953	126 1	180	3 3	6009	2	1943	344	6259	1021	2424	1 6	2	3	3	5	2	1	160	

ITEM	DESCRIPTION	UNIT	ITEM	DESCRIPTION	UNIT	NOTES:
568.70 606.10 606.100002 606.11 606.120102	TRANSITION BRIGE RAILING BOX BEAM GUIDE RAILING BOX BEAM GUIDE RAILING (SHOP BENT OR SHOP MITERED) BOX BEAM MEDIAN BARRIER BOX BEAM MEDIAN BARRIER BOX BEAM GUIDE RAILING END ASSEMBLY TYPE 1 BOX BEAM END ASSEMBLY, TYPE 3 HPBO (MOD.) CORRUGATED BEAM MEDIAN BARRIER ANCHORAGE UNIT FOR HPBO (MOD.) CORRUGATED BEAM MEDIAN BARRIER SINGLE-SLOPE CONCRETE MEDIAN BARRIER (OPTIONAL)	LF LF LF EA EA LF	606.74 606.79200125 606.7946 606.8805 606.8903 606.9003 606.9004 606.92010125	REMOVING AND DISPOSING BOX BEAM MEDIAN BARRIER REMOVE AND DISPOSE END TERMINAL FOR BOX BEAM GUIDE RAIL AN REMOVE AND DISPOSE ANCHORAGE UNIT FOR HPBO (MOD) CORRUGATED TRANSITION BETWEEN BOX BEAM MEDIAN BARRIER AND SINGLE SLOPE TRANSITION - HPBO (MOD). OFOR BEAM GUIDERAILING TO SINGLE SL TRANSITION - HPBO (MOD) CORRUGATED BEAM MEDIAN BARRIER TO WE TRANSITION - HALF SECTION AND FULL SECTION SINGLE SLOPE CONC TRANSITION - HALF SECTION AND FULL SECTION SINGLE SLOPE CONC REPLACE GUIDE RAIL SPLICE BOLTS	LF EA EA EA EA EA	
606.7101 606.72 606.73	REMOVE AND DISPOSE HPBO (MOD.) CORRUGATED BEAM GUIDE RAIL REMOVING AND DISPOSING CORRUGATED BEAM MEDIAN BARRIER REMOVING AND DISPOSING BOX BEAM GUIDE RAILING	LF LF LF	600.32010123	THE FACE GOLDE THATE STELLE BOETS	LA	

	ALTERED ON:	AFFIXED ON: 08/21/2025	
DESIGN SUPERVISOR: NETTH GAWACINON	SIGNATURE: STAMP:	SIGNATURE: STATE OF NEW CONTROL OF N	

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	REVISIONS								
	DATE	DESCRIPTION	BY	SYM.					
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IONN	Thruway Authority
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TITLE OF PROJECT
1R MILL AND INLAY, SAFETY IMPROVEMENTS,
AND MISC, WORK

LOCATION OF PROJECT
MP 416,90 TO MP 419,40


TITLE OF DRAWING
MISCELLANEOUS TABLES

TAB 25-31

DATE: 08/20/25

DRAWING NUMBER:


MST-2

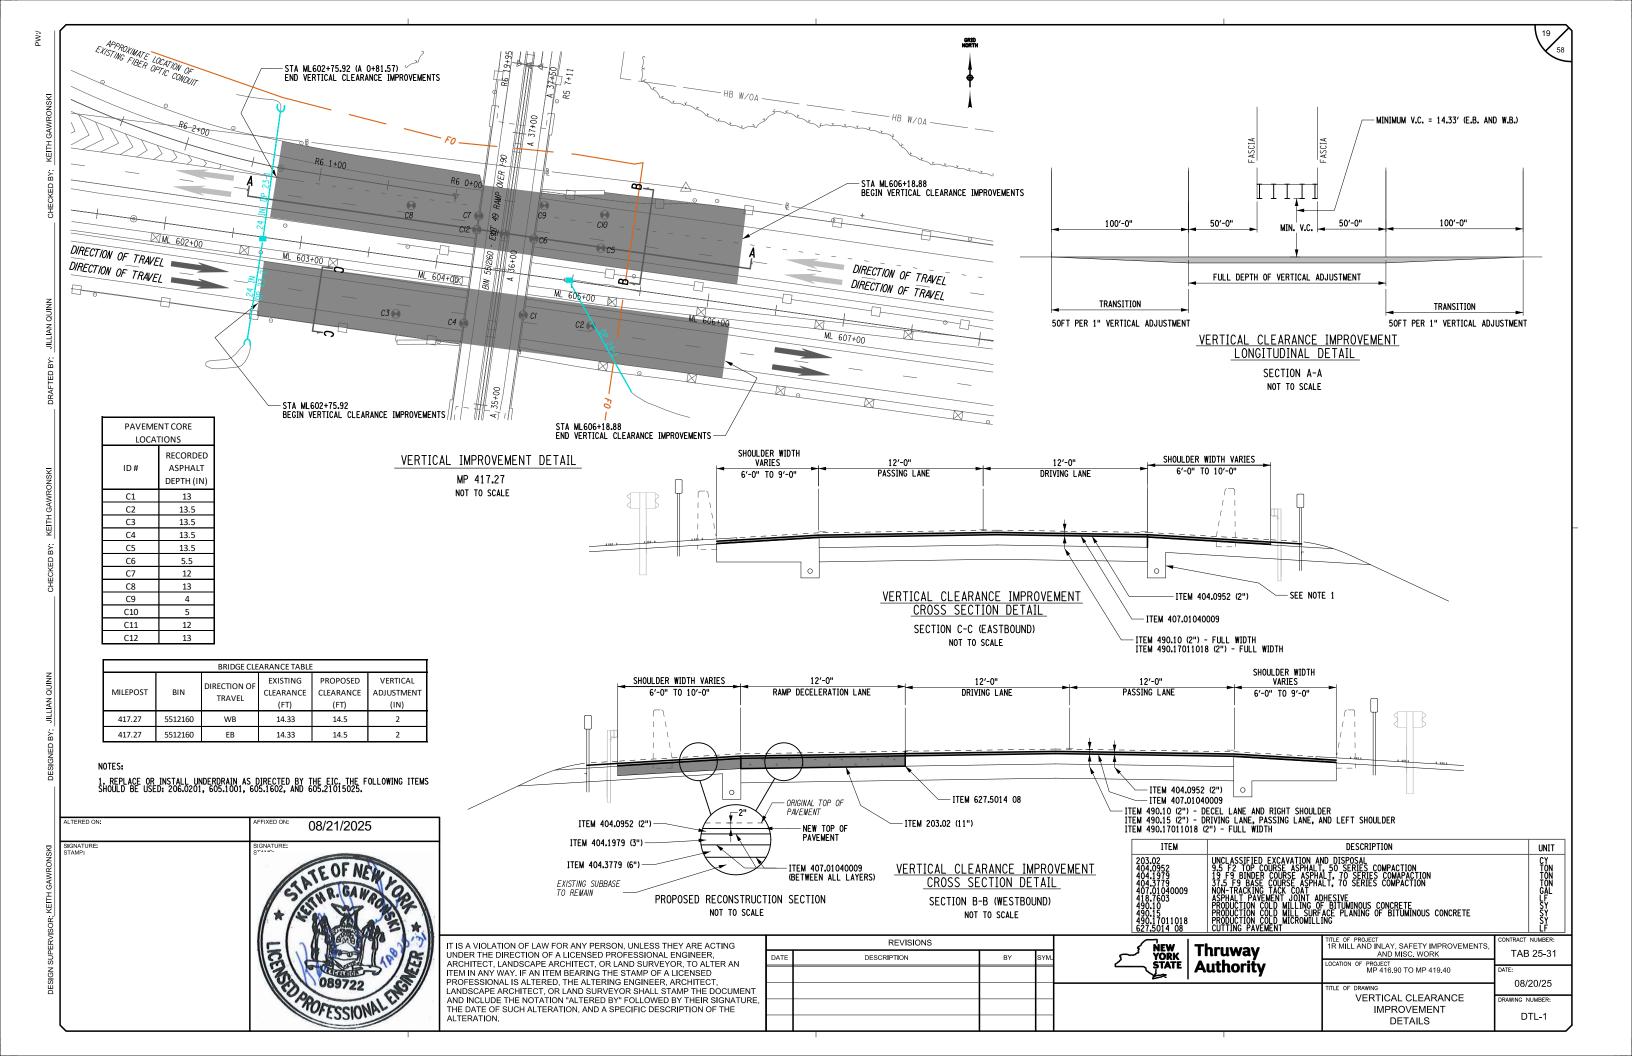

− & OF JOINT 1/2" RECESS (TYPICAL) --NEW JOINT SEALER EXISTING ELASTOMERIC HEADER TO REMAIN - EXISTING STEEL GIRDER

## PROPOSED JOINT SEAL REPLACEMENT MP 418.73 AND MP 418.98

(NOT TO SCALE)

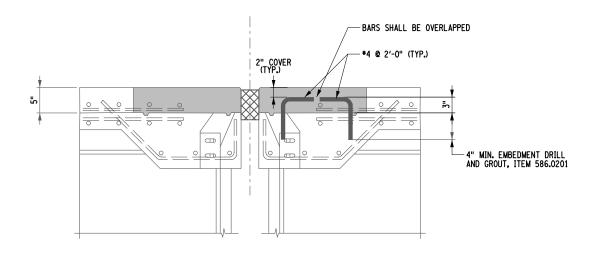

## PROPOSED HEADER REPAIRS

BIN 5511929

(NOT TO SCALE)

1		
	ALTERED ON:	AFFIXED ON: 08/21/2025
	SIGNATURE: STAMP:	SIGNATURE: STATE OF NEW CONTROL OF N
		(23)01.

THE "JOINT OPENING" SHALL BE DETERMINED AT THE TIME OF PLACEMENT, USING THE TABLE PROVIDED ON THIS DRAWING.

THE CONTRACTOR SHALL SUPPLY A JOINT SEAL WITH AN UNCOMPRESSED WIDTH EQUAL TO OR GREATER THAN THE DIMENSION NOTED AS "MIN. SEAL WIDTH" IN THE TABLE ABOVE. THE SEAL SUPPLIED SHALL NOT EXCEED THE MANUFACTURER'S COMPRESSION LIMITS AT THE "MINIMUM OPENING" NOTED IN THE TABLE.

THE SUPERSTRUCTURE TEMPERATURE USED TO DETERMINE THE JOINT OPENING SHALL BE THE AVERAGE TEMPERATURE OF THE BOTTOM OF THE GIRDER TOP FLANGES, (OR) THE TEMPERATURE OF THE SIDE OF A PRESTRESSED BEAM NOT DIRECTLY IN SUNLIGHT. A MINIMUM OF TWO TEMPERATURE READINGS PER SPAN SHALL BE USED TO CALCULATE THE AVERAGE SUPERSTRUCTURE TEMPERATURE.

SUPERSTRUCTURE TEMPERATURE (°F)	JOINT OPENING (IN.)	
30	1 1/4	
35	1 1/4	
40	1 1/8	
45	1 1/8	
50	1 1/8	
55	1 1/8	
60	1 1/8	
65	1 1/8	
70	1 1/8 1 1/8	
75		
80	1	
85	1	
90	1	
95	1	
100	1	
105	1	
110	1	

MP 418.98 - PIER 1 JOINT

MAX. OPENING / REQ. MIN. SEAL WIDTH (IN.) = 1.375 TOTAL MOVEMENT (IN.) = 0.375


EXPANSION JOINT OPENING TABLE						
SUPERSTRUCTURE TEMPERATURE (°F)	JOINT OPENING (IN.)					
30	2					
35	2					
40	2					
45	1 7/8 1 7/8 1 7/8					
50						
55						
60	1 3/4					
65	1 3/4 1 5/8 1 5/8					
70						
75						
80	1 5/8					
85	1 1/2					
90	1 1/2					
95	1 1/2					
100	1 3/8					
105	1 3/8					
110	1 3/8					

MIN. OPENING (IN.) = 1.375 MAX. OPENING / REQ. MIN. SEAL WIDTH (IN.) = 2.5 TOTAL MOVEMENT (IN.) = 1.125

MP 418.73 - JOINT 1						
EXPANSION JOINT OPENING TAE						
SUPERSTRUCTURE TEMPERATURE (°F)	JOINT OPENING (IN.)					
30	2 1/8					
35	2					
40	2					
45	1 7/8					
50	1 7/8					
55	1 3/4 1 3/4					
60						
65	1 3/4					
70	1 3/4					
75	1 3/4					
80	1 5/8					
85	1 5/8					
90	1 1/2					
95	1 1/2					
100	1 3/8					
105	1 3/8					
110	1 3/8					
NOTES:						
MIN. OPENING (IN.) = 1.375						
MAX. OPENING / REQ. MIN. SEAL WIDTH (IN.) = 2.625						

TOTAL MOVEMENT (IN.) = 1.375

ITEM	DESCRIPTION	UNIT
207.21 556.0202 567.62 567.63 580.01 586.0201	GEOTEXTILE SEPARATION EPOXY-COATED BAR REINFORCEMENT FOR STRUCTURES BRIDGE JOINT HEADER BRIDGE JOINT SEAL REMOVAL OF STRUCTURAL CONCRETE DRILLING AND GROUTING BOLTS OR REINFORCEMENT BARS	SY LB CF LF CY EACH

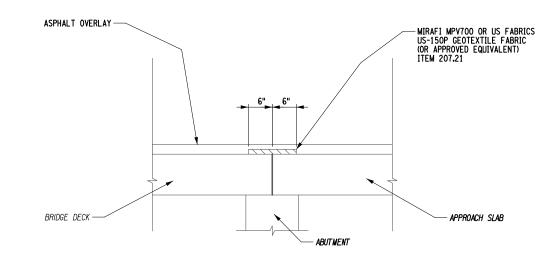



## SAWED JOINT GEOTEXTILE FABRIC DETAIL (NOT TO SCALE)


NOTES:


AT JOINTS BETWEEN ROLLS, OVERLAP FABRIC A MINIMUM OF 6".

IT IS A VIOLATION OF LAW FOR ANY PERSON, UNLESS THEY ARE ACTING		REVISIONS			/ a'	TITLE OF PROJECT 1R MILL AND INLAY, SAFETY IMPROVEMENTS,	CONTRACT NUMBER:
UNDER THE DIRECTION OF A LICENSED PROFESSIONAL ENGINEER, ARCHITECT, LANDSCAPE ARCHITECT, OR LAND SURVEYOR, TO ALTER AN	DATE	DESCRIPTION	BY	SYM.	YORK I III UWAY	AND MISC. WORK	TAB 25-31
ITEM IN ANY WAY. IF AN ITEM BEARING THE STAMP OF A LICENSED PROFESSIONAL IS ALTERED. THE ALTERING ENGINEER. ARCHITECT.					STATE   Authority		DATE: 08/20/25
LANDSCAPE ARCHITECT, OR LAND SURVEYOR SHALL STAMP THE DOCUMENT						TITLE OF DRAWING BRIDGE JOINT DETAILS	DRAWING NUMBER:
AND INCLUDE THE NOTATION "ALTERED BY" FOLLOWED BY THEIR SIGNATURE, THE DATE OF SUCH ALTERATION, AND A SPECIFIC DESCRIPTION OF THE						BRIDGE SOUT DETAILS	
ALTERATION.							DTL-2

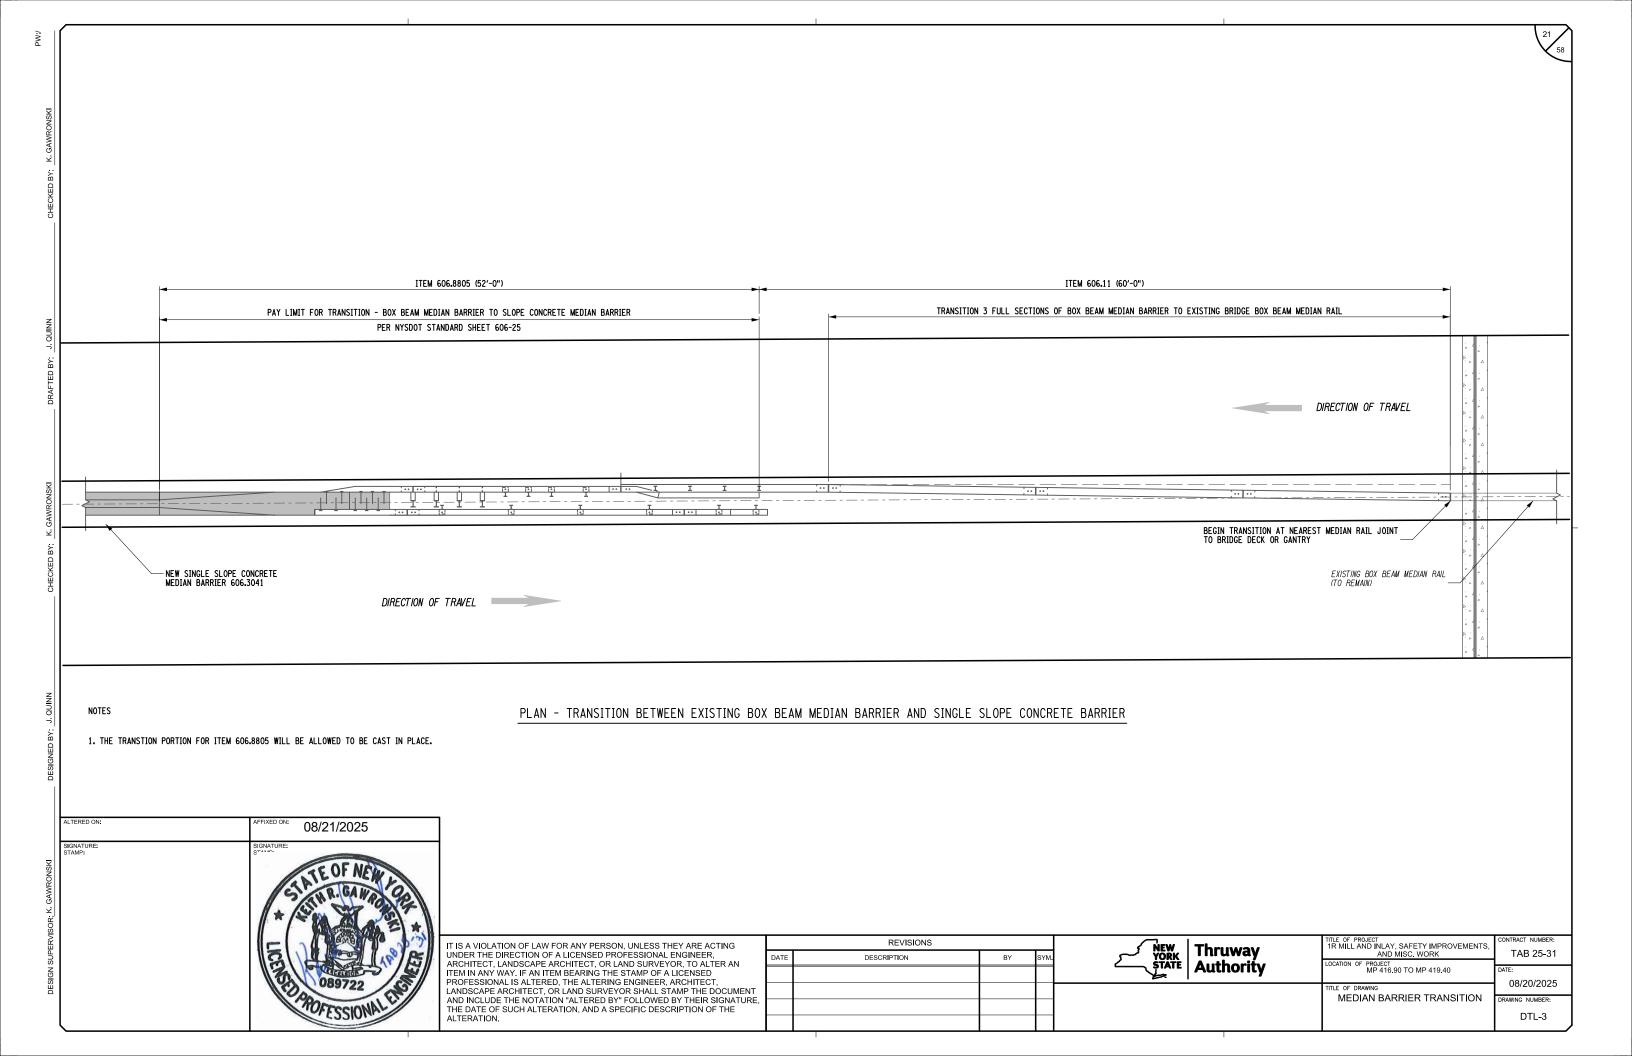

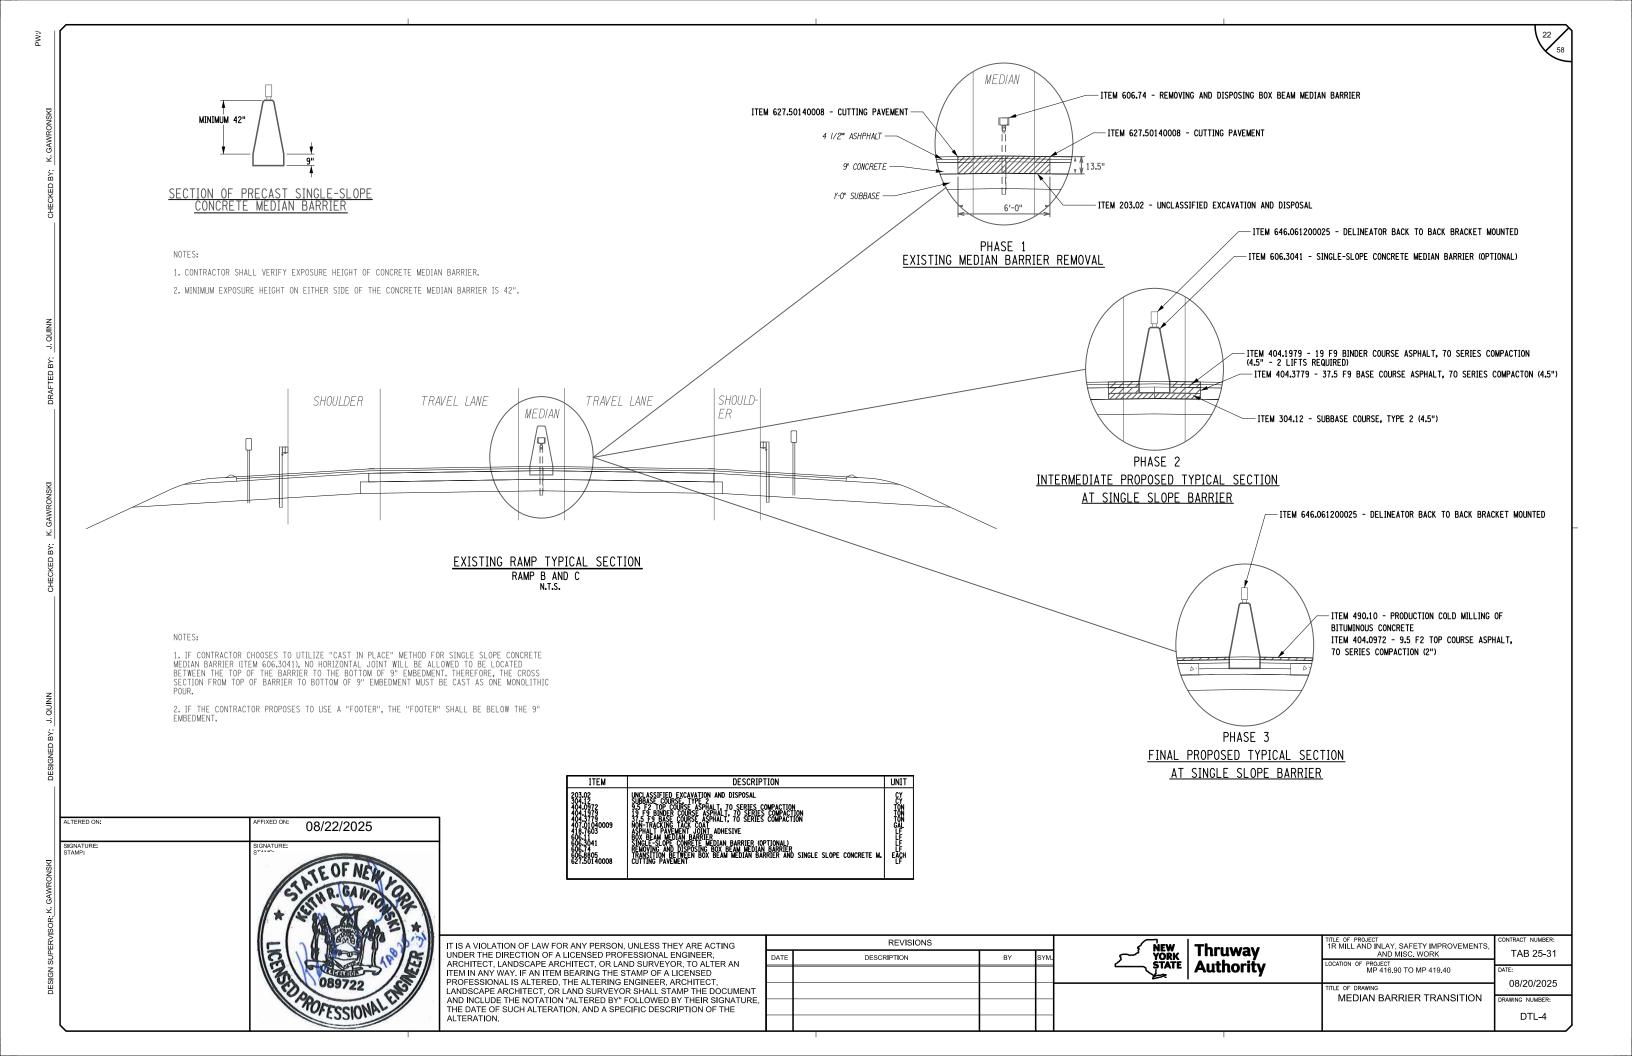

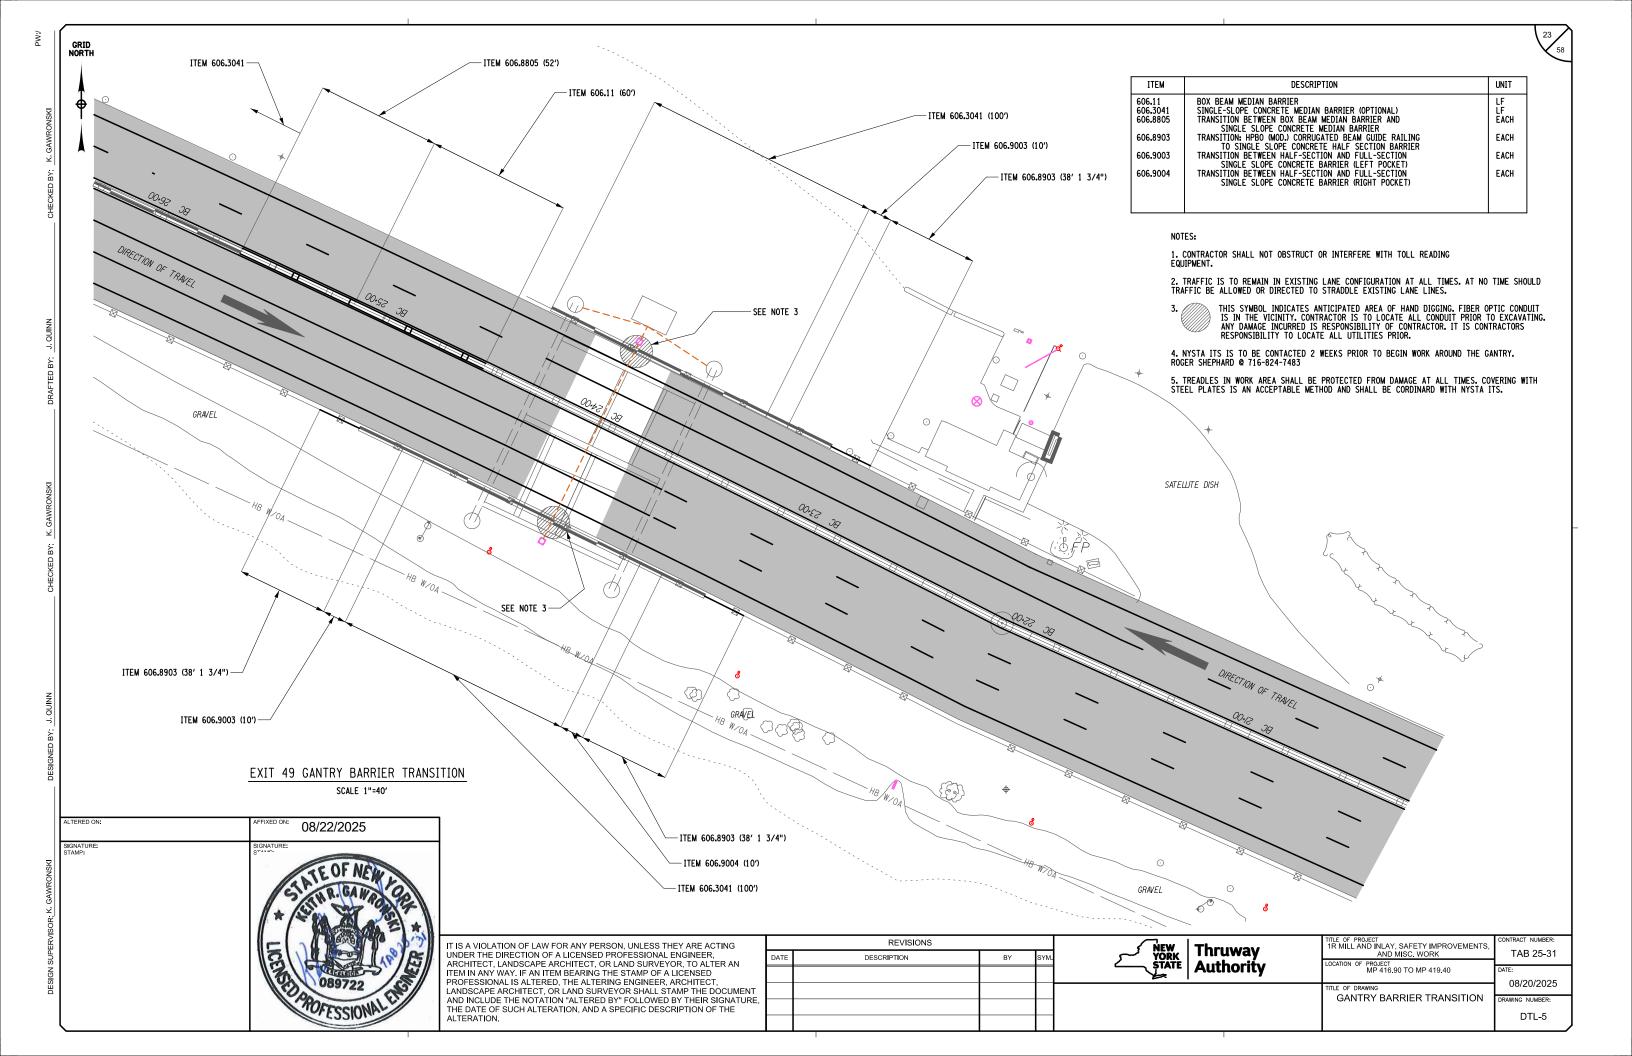


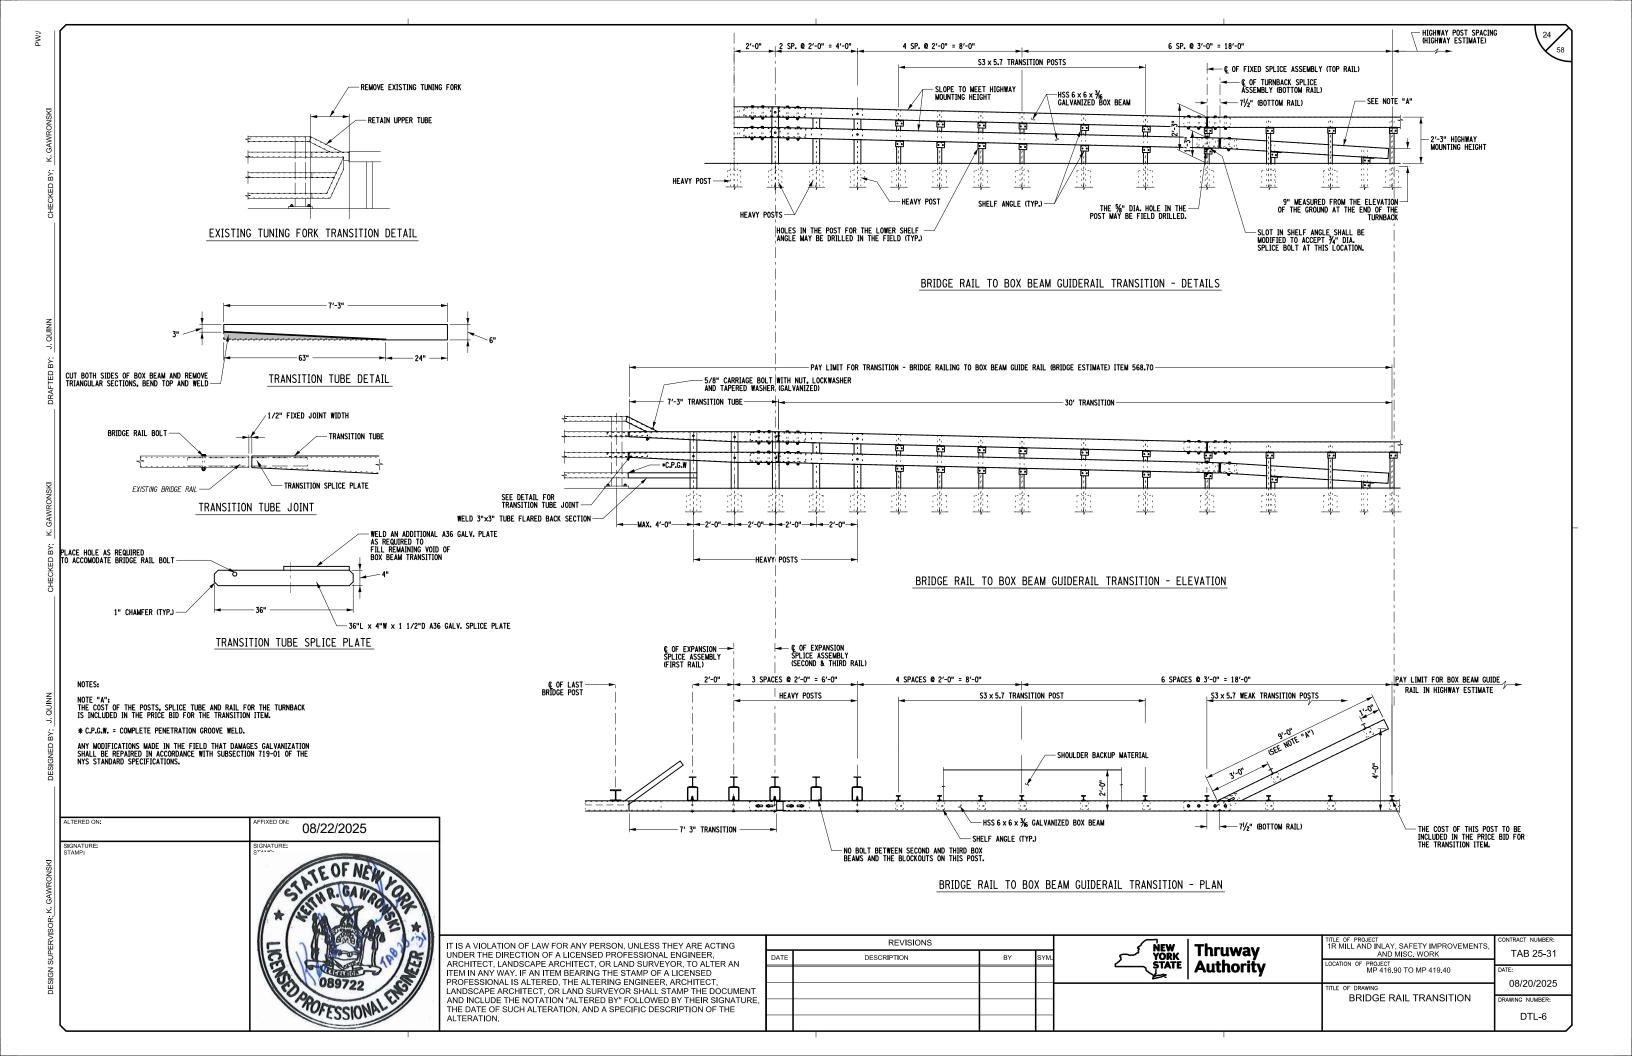


TAB 25-31

08/20/2025

DTL-7

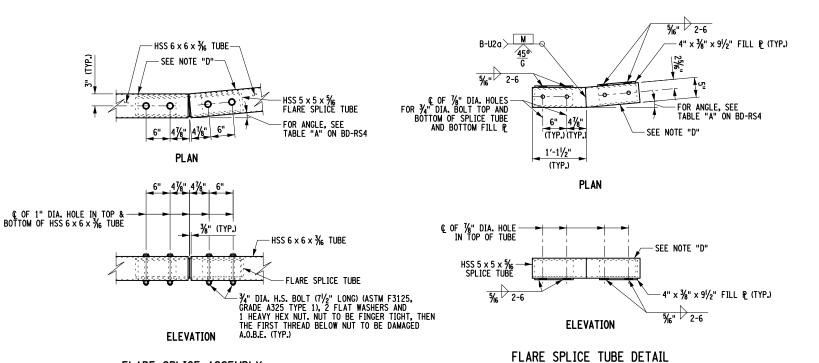


FLARE SPLICE ASSEMBLY

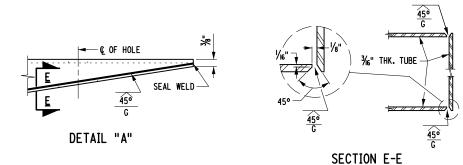

TRANSITION TUBE WELD DETAILS

NOTES:

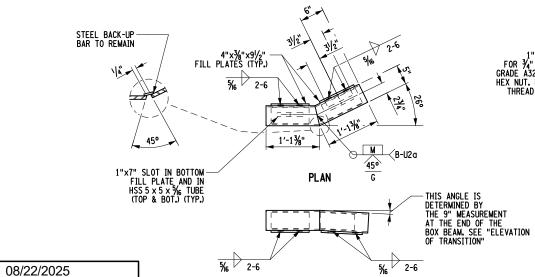

HSS 6 x6 x 3/6 GALVANIZED
BOX BEAM RAIL (TYP.)

SEE NOTE "D"

1" DIA. HOLE IN BOX BEAM (TOP AND BOTTOM
FOR 3/4" DIA. H.S. BOLTS (71/2" LONG) (ASTM F3125,
GRADE A325 TYPE 1), 2 FLAT WASHERS AND 1 HEAVY
HEX NUT. NUT TO BE FINGER TIGHT, THEN THE FIRST
THREAD BELOW NUT TO BE DAMAGED A.O.B.E. (TYP.)

HSS 5 x 5 x 3/6 SPLICE TUBE

1. NOTE "D"
PROTRUSIONS CAUSED BY WELDING OR GALVANIZING ARE NOT PERMITTED
ON THE ADJOINING SURFACES OF THE BOX BEAM RAILS, SPLICE TUBES
AND FILL PLATES.


ELEVATION

SPLICE TUBE DETAILS FOR TURNBACK

IT IS A VIOLATION OF LAW FOR ANY PERSON, UNLESS THEY ARE ACTING UNDER THE DIRECTION OF A LICENSED PROFESSIONAL ENGINEER, ARCHITECT, LANDSCAPE ARCHITECT, OR LAND SURVEYOR, TO ALTER AN ITEM IN ANY WAY. IF AN ITEM BEARING THE STAMP OF A LICENSED PROFESSIONAL IS ALTERED, THE ALTERING ENGINEER, ARCHITECT, LANDSCAPE ARCHITECT, OR LAND SURVEYOR SHALL STAMP THE DOCUMENT AND INCLUDE THE NOTATION "ALTERED BY" FOLLOWED BY THEIR SIGNATURE, THE DATE OF SUCH ALTERATION, AND A SPECIFIC DESCRIPTION OF THE ALTERATION.

REVISIONS				NEW Thruway	1 TITLE OF PROJECT 1R MILL AND INLAY, SAFETY IMPROVEMENTS		
DATE	DESCRIPTION	BY	SYM.	1 IORN I	AND MISC. WORK		
				STATE   Authority	MP 416.90 TO MP 419.40		
					TITLE OF DRAWING BRIDGE RAIL TRANSITION		
					BRIDGE RAIL TRANSITION		

SPLICE DETAIL AT TURNBACK IN LOWER TRANSITION GUIDE RAIL

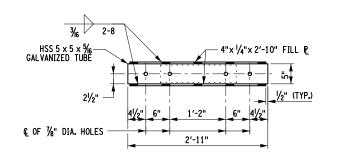

3/6 2-8


© OF ⅓" DIA. HOLES THROUGH TUBE AND FILL №


HSS  $5 \times 5 \times \frac{5}{16}$  GALVANIZED – TUBÉ, 2'-11" LONG

PLAN

**ELEVATION** EXPANSION SPLICE TUBE

— 4"x ¼"x 1′-7" FILL №

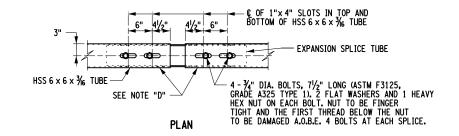


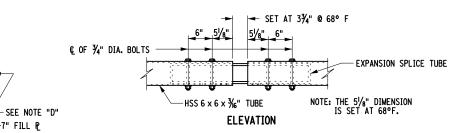

**EXPANSION SPLICE ASSEMBLY** 

HSS 5 x 5 x 5/6 GALVANIZED TUBE


© OF %" DIA. HOLES-

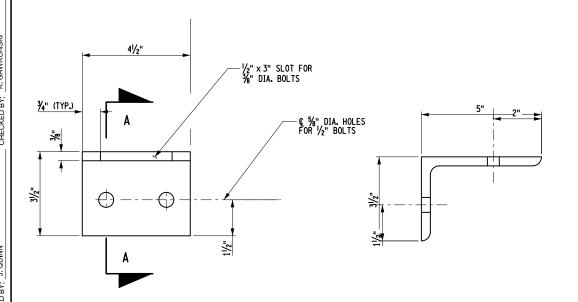




ALTERED ON:	AFFIXED ON: 08/22/2025	
SIGNATURE: STAMP:	SIGNATURE: STAMP.  STA	
	OB9722 OB9722 OB9722	IT IS A VIOLATION OF LAW FOR ANY PERSON, UNLESS THEY ARE ACTING UNDER THE DIRECTION OF A LICENSED PROFESSIONAL ENGINEER, ARCHITECT, LANDSCAPE ARCHITECT, OR LAND SURVEYOR. TO ALTER AN ITEM IN ANY WAY. IF AN ITEM BEARING THE STAMP OF A LICENSED PROFESSIONAL IS ALTERED, THE ALTERING ENGINEER, ARCHITECT, LANDSCAPE ARCHITECT, OR LAND SURVEYOR SHALL STAMP THE DOCUMENT AND INCLUDE THE NOTATION "ALTERED BY" FOLLOWED BY THEIR SIGNATURE, THE DATE OF SUCH ALTERATION, AND A SPECIFIC DESCRIPTION OF THE ALTERATION.

SECTION A-A

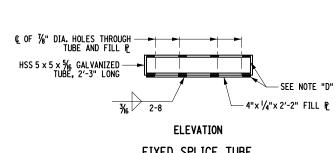

2'-3" PLAN -4"x 1/4"x 2'-2" FILL P

FIXED SPLICE TUBE

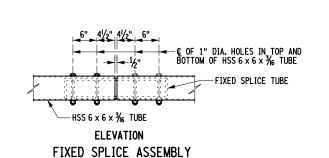

NOTES:

1. NOTES "D"
PROTRUSIONS CAUSED BY WELDING OR GALVANIZING ARE NOT PERMITTED
ON THE ADJOINING SURFACES OF THE BOX BEAM RAILS, SPLICE TUBES
AND FILL PLATES.

-FIXED SPLICE TUBE


- 4 - ¾" DIA. BOLTS, 7½" LONG (ASTM F3125, GRADE A325 TYPE 1). 2 FLAT WASHERS AND 1 HEAVY HEX NUT ON EACH BOLT. NUT TO BE FINGER TIGHT AND THE FIRST THREAD BELOW THE NUT TO BE DAMAGED A.O.B.E. 4 BOLTS AT EACH SPLICE.

TITLE OF PROJECT
1R MILL AND INLAY, SAFETY IMPROVEMENTS
AND MISC. WORK REVISIONS Thruway TAB 25-31 DESCRIPTION Authority PROJECT MP 416.90 TO MP 419.40 08/20/2025 **BRIDGE RAIL TRANSITION** DTL-8

SEE NOTE "D"

-0--0-

HSS 6 x 6 x 3/6 TUBE

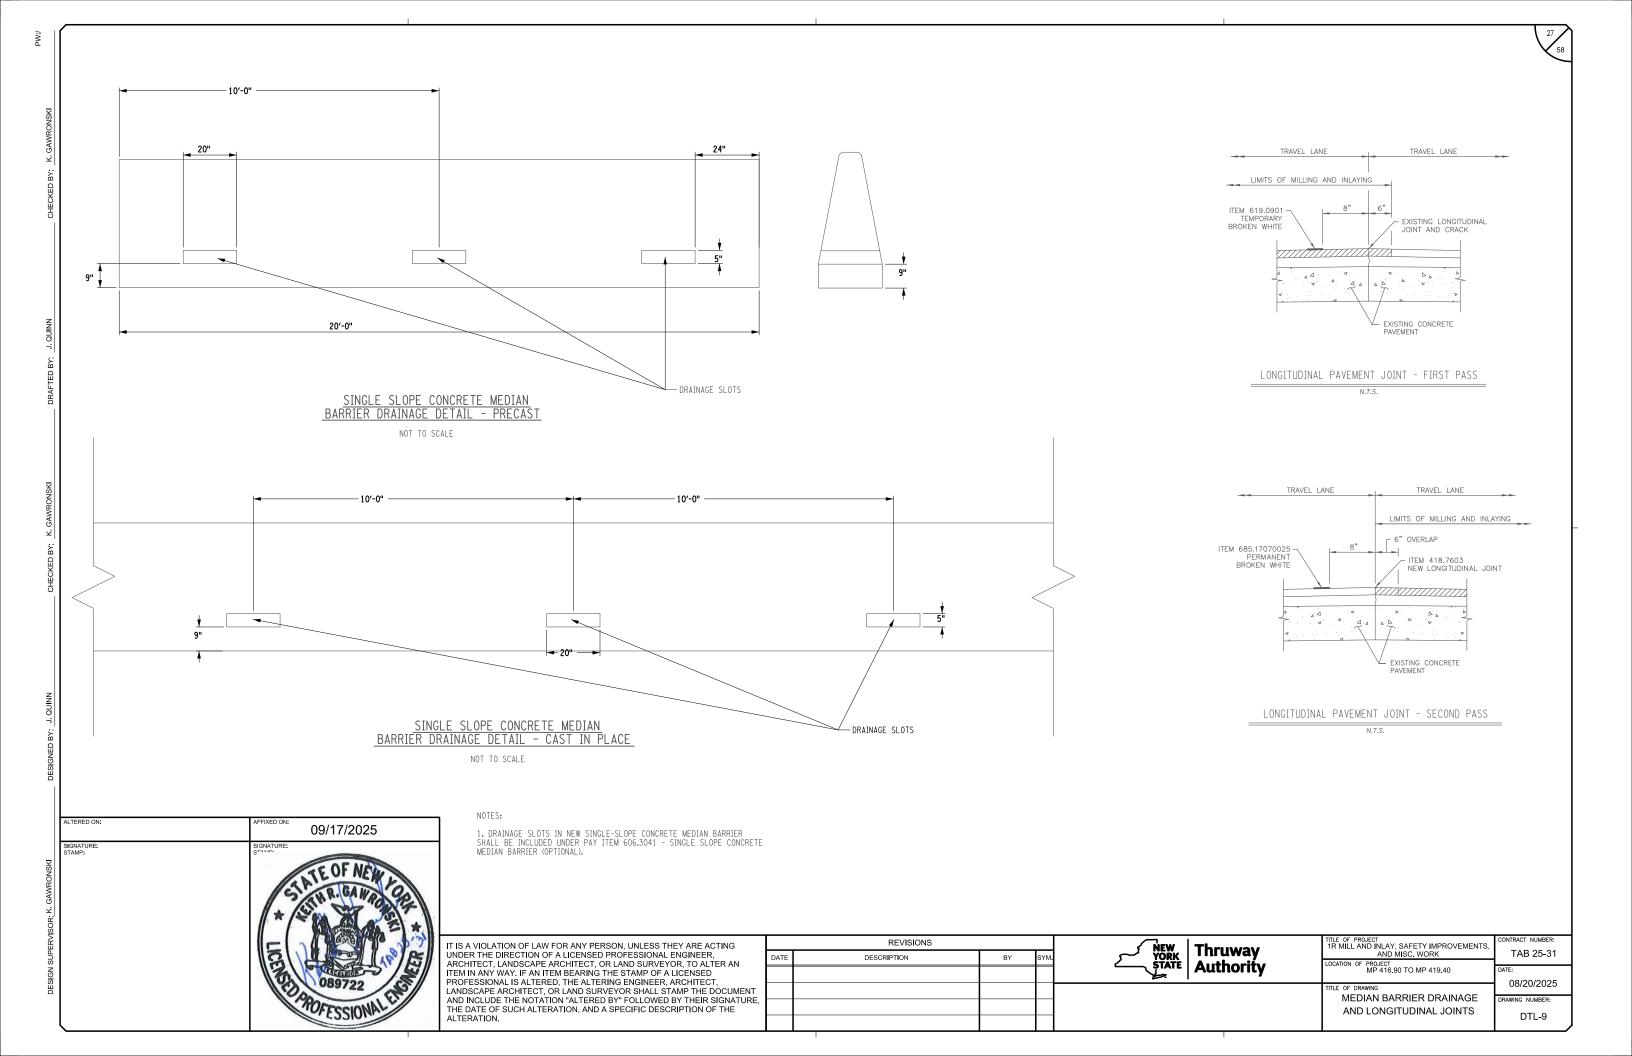

## GENERAL WORK ZONE AND TRAFFIC CONTROL NOTES

- WORKZONE TRAFFIC CONTROL SHALL BE PROVIDED THROUGHOUT THE LENGTH OF THE CONTRACT IN ACCORDANCE WITH THE PROVISIONS OF SECTION 619 WORK ZONE TRAFFIC CONTROL OF THE NYSDOT STANDARD SPECIFICATIONS. THE NATIONAL MANUAL ON UNIFORM TRAFFIC CONTROL DEVICES AND ANY PROVISIONS CONTAINED IN THE CONTRACT DOCUMENTS, AND AS ORDERED BY THE ENGINEER (A.O.B.E). THE NATIONAL MANUAL ON UNIFORM TRAFFIC CONTROL DEVICES (NATIONAL MUTCD) SHALL BE DEFINED AS THE NATIONAL MUTCD, JULY 2022 EDITION WITH SUPPLEMENTS.
- THE CONTRACT DOCUMENTS AND THE TRAFFIC MAINTENANCE SCHEMES SHOWN IN SECTION 6 OF THE NATIONAL MUTCD ARE CONSIDERED TO BE MINIMUM REQUIREMENTS. ADDITIONAL SIGNS, DELINEATION, AND/OR TRAFFIC CONTROL DEVICES MAY BE REQUIRED AS DETERMINED BY THE ENGINEER. THE COST OF ANY ADDITIONAL DEVICES SHALL BE INCLUDED IN THE PRICE BID FOR ITEM 619.01 - WORK ZONE TRAFFIC CONTROL.
- THE CONTRACT DOCUMENTS ARE NOT INTENDED TO BE ALL INCLUSIVE, BUT RATHER SERVE AS A GUIDE FOR THE SAFE & EFFICIENT SEQUENCING OF CONSTRUCTION OPERATIONS. THE TRAFFIC CONTROL PLANS PROVIDE FOR THE BASIC REQUIREMENTS & RESTRICTIONS OF THIS CONTRACT. ANY INCIDENTAL ADDITIONS & REVISIONS TO THESE PLANS, AS DIRECTED BY THE ENGINEER, SHALL BE INCLUDED IN THE PRIDE BID FOR ITEM 619.01 - WORK ZONE TRAFFIC CONTROL.
- PRIOR TO THE START OF WORK, THE CONTRACTOR MUST SUBMIT TO THE ENGINEER, IN WRITING, ANY PROPOSED CHANGES TO THE TRAFFIC CONTROL PLANS FOR APPROVAL. ANY CHANGES WHICH ALTER THE BASIC CONCEPT OF THESE PLANS MUST BE
- IF THE ENGINEER NOTIFIES THE CONTRACTOR OF ANY HAZARDOUS CONSTRUCTION PRACTICES AND/OR CONDITIONS, ALL OPERATIONS IN THAT AREA SHALL BE DISCONTINUED AND IMMEDIATE REMEDIAL ACTION SHALL BE TAKEN TO CORRECT THE SITUATION, TO THE SATISFACTION OF THE ENGINEER, BEFORE WORK IS RESUMED.
- ON LONG LANE CLOSURES, ADDITIONAL DEVICES (DRUMS, OVERSIZED VEHICLES PANELS, ETC.) SHALL BE PLACED PERPENDICULAR TO TRAFFIC IN THE CLOSED LANE, EVERY 800 FEET. IN ADDITION, ADDITIONAL DEVICES SHALL BE SIMILARLY PLACED IN ADVANCE OF ANY TRAVERSE DROP-OFF OF 1 1/2 INCHES OR GREATER.
- THE CONTRACTOR SHALL PLAN AND INCORPORATE ACCESS POINTS INTO THE WORK ZONE SUCH THAT, TO THE EXTENT PRACTICAL, THE CONTRACTOR'S VEHICLES ENTERING AND LEAVING THE WORK ZONE SHALL NOT IMPEDE THE MOVEMENT OF
- CONSTRUCTION EQUIPMENT AND MATERIALS SHALL BE REMOVED FROM THE CLEAR ROADSIDE AREA DURING THE HOURS THAT THE CONTRACTOR IS NOT WORKING, THIS REQUIREMENT SHALL NOT BE LIMITED TO THE CONTRACT LIMITS.
- ADDITIONAL WORK ZONE TRAFFIC CONTROL NOTES ARE INCLUDED ELSEWHERE IN THE TRAFFIC CONTROL PLANS, OTHER CONTRACT DRAWINGS AND THE NYSTA CURRENT STANDARD SHEETS.
- THE CONTRACTOR'S ATTENTION IS DIRECTED TO THE FACT THAT THESE HIGHWAYS WILL BE DESIGNATED AS NON-RESTRICTED HIGHWAYS UNDER THIS CONTRACT.
- WHEN TWO OR MORE WORK AREAS ARE ADJACENT, OVERLAP, OR ARE IN CLOSE PROXIMITY AS DETERMINED BY THE ENGINEER, THE CONTRACTOR SHALL ENSURE THERE IS NO CONFLICT IN SIGNING AND THAT LANE CONTINUITY IS MAINTAINED CONSTRUCTION ACTIVITIES THROUGHOUT ALL WORK AREAS.

### DELINEATION AND CHANNELIZATION

- THE CONTRACTOR SHALL DELINEATE AREAS WHERE THERE IS A DROP-OFF NEAR OF THE EDGE OF THE TRAVELED WAY AND 2. AREAS ON WHICH IT IS UNSAFE TO TRAVEL. THE PROVISIONS FOR DELINEATION SHALL BE IN ACCORDANCE WITH NYSDOT STANDARD SPECIFICATIONS 619-3.02 AND NYSTA STANDARD SHEETS ON SS-1 OF THE PLANS. THESE SECTIONS INDICATE THE MINIMUM DELINEATION REQUIREMENTS. ADDITIONAL DELINEATION MAY BE REQUIRED AS DIRECTED BY THE ENGINEER OR AS MINIMUM DELINEATION REQUIREMENTS. ADDITIONAL DELINEATION MAY BE REQUIRED AS DIRECTED BY THE ENGINEER OR A SHOWN ON THE PLANS. MUTCO COMPLIANT CHANNELIZATION DEVICES MEETING 619 SPECIFICATIONS SHALL BE USED AT HAZARDOUS LOCATIONS DETERMINED BY THE ENGINEER. DELINEATION DEVICES SHALL REMAIN IN PLACE UNTIL SATISFACTORY PROTECTION IS PROVIDED OR THE HAZARD REMOVED. THEY SHALL BE PLACED AT A DISTANCE NOT TO EXCEED 40 FEET OR AS DIRECTED BY THE ENGINEER. THE CONTRACTOR MAY ELECT, AT NO ADDITIONAL COST TO THE AUTHORITY, TO INSTALL TEMPORARY POSITIVE BARRIER TO ELIMINATE DROP-OFFS OR HAZARDS. THE COST OF ALL DELINEATION AND DROP-OFF PROTECTION SHALL BE INCLUDED IN THE PRICE BID FOR ITEM 619.01 - BASIC WORK ZONE TRAFFIC CONTROL
- PAYEMENT MARKINGS PLACED DURING CONSTRUCTION SHALL BE APPLIED PER SECTION 619 OF THE NYSDOT STANDARD SPECIFICATIONS AND SHALL CONFORM TO THE PROJECT'S PERMANENT MARKINGS WITH RESPECT TO COLOR AND PATTERN. PAYMENT WILL BE MADE UNDER ITEM 619.0901 - TEMPORARY PAVEMENT MARKINGS STRIPES.
- THE CONTRACTOR IS RESPONSIBLE FOR MONITORING THE WORK ZONE, ALL DISLODGED DELINEATION DEVICES AND/OR OBSCURED PAVEMENT MARKINGS WILL BE RESET AND/OR RE-MARKED AS REQUIRED, OR A.O.B.E.
- THE CONTRACTOR SHALL REMOVE EXISTING PAVEMENT MARKINGS THAT CONFLICT WITH TEMPORARY PAVEMENT MARKINGS REQUIRED FOR CONSTRUCTION, THE COST TO REMOVE THE EXISTING PAYEMENT MARKINGS, UNLESS REMOVED DURING EXCAVATION, WILL BE INCLUDED IN THE PRICE BID FOR ITEMS 619.080101 AND 619.080102 - REMOVE PAVEMENT MARKING STRIPES (TRAFFIC PAINT) AND REMOVE PAVEMENT MARKING STRIPES (EPOXY PAINT).
- THE CONTRACTOR SHALL NOT MIX DELINEATION DEVICES IN A LINEAR CLOSURE OR TAPER, (I.E., CONES, VERTICAL PANELS, CANDLES, OR DRUMS SHALL NOT BE USED IN THE SAME TAPER OR CLOSURE). HOWEVER, DIFFERENT WORK AREAS WITHIN THE PROJECT LIMITS MAY BE USE DIFFERENT DELINEATION DEVICES.
- THE MAXIMUM LENGTH OF ANY CONTINUOUS WORK SPACE SHALL NOT EXCEED 2 MILES EXCEPT UNDER FOUR-LANE, TWO-WAY OPERATION (FLTWO). ALL TRAFFIC SHALL BE RE-ESTABLISHED TO ITS NORMAL LANE CONFIGURATION FOR A MINIMUM 2 MILES PRIOR TO A SUCCESSFUL LANE CLOSURE, (THE SEPARATION BETWEEN SUCCESSIVE LANE CLOSURES MEASURED FROM THE LAST SIGN OF THE FIRST LANE CLOSURE TO THE BEGINNING OF THE MERGING TAPER OF THE SECOND LANE CLOSURE).

09/16/2025

- DIAMOND-SHAPED ADVANCE WARNING SIGNS SHALL BE USED FOR ALL ADVANCE WARNING SIGNS SHOWN IN THE NATIONAL MUTCD, COLOR REQUIREMENTS SHALL BE BLACK TEXT ON ORANGE BACKGROUND, COLOR REQUIREMENTS FOR REGULATORY & GUIDE SIGNS USED FOR CONSTRUCTION SIGNING SHALL BE AS SPECIFIED IN THE NATIONAL MUTCD FOR EACH SIGN, OR AS
- LONGITUDINAL PLACEMENT OF CONSTRUCTION SIGNS SHALL BE SHOWN ON THE TRAFFIC CONTROL PLANS AND AS DIRECTED BY THE ENGINEER. THE LATERAL CLEARANCE FROM THE EDGE OF THE TRAVEL LANE TO THE EDGE OF THE CONSTRUCTION SIGN SHALL BE A MINIMUM OF 3 FEET, OR AS A.O.B.E.. SIGNS SHALL BE PLACED TO PROVIDE OPTIMUM
- MOUNTING HEIGHT REQUIEMENTS FOR ALL LONG DURATION CONSTRUCTION SIGNS SHALL BE 7 FEET MINIMUM MEASURED FROM THE GROUND SURFACE TO THE BOTTOM OF THE SIGN. SHORT DURATION CONSTRUCTION SIGNS MAY BE MOUNTED AT A 4. MINIMUM HEIGHT OF 5 FEET, OR A.O.B.E.
- DURING THE PROGRESSION OF CONSTRUCTION, SOME EXISTING SIGNS MAY REQUIRE MINOR RELOCATION DUE TO TEMPORARY PAVEMENT WIDENING, SHIFT OF TRAFFIC LANES, OR CHANGE IN THE FLOW OF TRAFFIC. THE COST OF THESE RELOCATIONS SHALL BE INCLUDED IN THE PRICE BID FOR ITEM 619.01 BASIC WORK ZONE TRAFFIC CONTROL.
- ALL FLAGGING OPERATIONS SHALL USE 24" (MIN.) OCTAGONAL SHAPED STOP/SLOW PADDLES HAVING A 6' STAFF, FLAGGERS 1. SHALL BLOCK ALL ENTRANCE LANES/RAMPS (INCLUDING ENTRANCES FROM SERVICE SREAS, PARKING AREAS, REST AREAS, TANDEM TRUCK LOTS, ETC.) WITHIN THE AREA OF THE TRAFFIC SLOWDOWN/STOP. AN ADVANCE WARNING SIGN, FLAGGER SYMBOL (W20-7) OR ROAD WORK AHEAD (W20-1), FOR EACH RAMP SHALL BE PLACED 300 TO 500 FEET IN ADVANCE OF THE
- THE COST OF ALL TEMPORARY SIGNS NECESSARY FOR WORK ZONE TRAFFIC CONTROL AS NOTED IN THE PLANS, STANDARD SPECIFICATIONS, NATIONAL MUTCD, AND A.O.B.E, SHALL BE INCLUDED IN THE PRICE BID FOR ITEM 619.01 BASIC WORK ZONE TRAFFIC CONTROL.
- THE CONTRACTOR WILL BE REQUIRED TO COVER AND UNCOVER EXISTING AND CONSTRUCTION SIGNS DURING THE PROJECT. THIS PROCESS WILL BE DIRECTED BY THE ENGINEER-IN-CHARGE AND SHALL BE INCLUDED IN ITEM 619.01 AT NO
- THE CONTRACTOR SHALL REMOVE, STORE, AND RE-SET EXISTING SIGNS WHICH CONFLICT WITH CONSTRUCTION SIGNS. THE CONTRACTOR SHALL BE RESPONSIBLE FOR ANY DAMAGE TO THE EXISTING SIGNS DUE TO THE REMOVAL, STORAGE, AND
- THE DIMENSIONS OF THE WORK ZONE TRAFFIC CONTROL SIGNS ARE DESCRIBED IN THE MUTCD, ANY CHANGES TO THE DIMENSIONS SHALL BE APPROVED BY THE EIC.

- UNLESS OTHERWISE SHOWN OR APPROVED BY THE ENGINEER, WORK AREAS ON OPPOSITE SIDES OF THE ROAD SHALL NOT OVERLAP OR CO-EXIST.
- NO MATERIAL IS TO BE STORED WITHIN THE CLEAR ROADSIDE AREA OTHER THAN THAT MATERIAL WHICH WILL BE PLACED THAT DAY, WITHOUT THE APPROVAL OF THE ENGINEER. THE CLEAR ROADSIDE AREA IS DEFINED AS THE AREA WITHIN 30
- CONSTRUCTION EQUIPEMENT SHALL BE REMOVED FROM THE CLEAR ROASIDE AREA DURING HOURS THAT THE CONTRACTOR IS NOT WORKING. THIS REQUIREMENT SHALL NOT BE LIMITED TO THE CONTRACT LIMITS.
- NO PRIVATE VEHICLES (OWNED BY THE CONTRACTOR'S EMPLOYEES) SHALL BE PARKED ON THRUWAY PROPERTY. THE CONTRACTOR AND ALL SUBCONTRACTORS SHALL MARSHALL AT AN OFF-SITE YARD AND TRAVEL TO THE WORK SITE IN CONTRACTOR OWNED VEHICLES.
- ALL OPERATIONS, INCLUDING PAVING, ROLLING, GRADING, SUPPLYING OF MATERIAL, AND THE TRAVEL OF SUPERVISORY PERSONNEL THROUGH THE WORK ZONE, AND THE ENTIRE LENGTH OF THE CONTRACT, WILL ALWAYS BE IN THE DIRECTION OF NORMAL TRAFFIC EXCEPT WHERE SPECIFICALLY ALLOWED OTHERWISE BY THE ENGINEER TO PERFORM A PARTICULAR
- ALL UNEVEN TRAVERSE PAVEMENT SURFACES (I.E. PAVEMENT REBATES, END OF PAVED SURFACES) SHALL BE POSTED WITH "BUMP" SIGNS (W8-1) AND EITHER A TYPE 1 OBJECT MARKER (OM1-3) OR A CONSTRUCTION DRUM WITH A FLASHING WARNING LIGHT ON BOTH SIDES OF THE ROADWAY, TO BE LOCATED A.O.B.E COST TO BE INCLUDED IN ITEM 619.01.

## NIGHTTIME OPERATIONS NOTES

- WORK ZONE TRAFFIC CONTROL FOR NIGHTTIME CONSTRUCTION SHALL BE CONDUCTED IN ACCORDANCE WITH THE CONTRACT
- TO THE EXTENT PROJECT AND TRAFFIC CONDITIONS PERMIT, THE CONTRACTOR SHALL TAKE ADVANTAGE OF DAYLIGHT HOURS BEFORE AND AFTER THE SHIFT FOR SETUP AND REMOVAL OF TRAFFIC CONTROLS, AS WELL AS OTHER PREPARATIONS AND
- ARROW BOARDS USED AT NIGHT SHALL BE PROPERLY DIMMED AS DESCRIBED BY THE MUTCD AND THE STANDARD SPECIFICATIONS TO AVOID GLARE FOR APPROACHING MOTORISTS.
- NIGHTTIME OPERATIONS, INCLUDING LANE CLOSURES OR OBSTRUCTIONS, WILL BE PERMITTED AS NOTED IN THE "SCHEDULE AND SUSPENSION OF WORK" LOCATED IN THE PROPOSAL.
- NIGHTTIME LANE CLOSURES SHALL BE LOCATED AWAY FROM OTHER CONFLICT POINTS SUCH AS RAMPS WHENEVER POSSIBLE.
- THE CONTRACTOR SHALL PROVIDE LIGHTING FOR ALL NIGHTTIME OPERATIONS IN ACCORDANCE WITH ITEM 619.24.
- THE CONTRACTOR IS ADVISED THAT ILLUMINATIONS IS TO BE PROVIDED THROUGHOUT THE ENTIRE AREA OF CONSTRUCTION OPERATIONS, WHICH INCLUDES ALL WORK AREAS OCCUPIED BY THE CONTRACTOR'S PERSONNEL (TRUCK STAGING AREAS, CLEAN OUT AREAS, LAYOUT AND MEASUREMENT AHEAD OF ACTUAL WORK, ETC.). ALL SUCH WORK AREAS ARE TO BE SHOWN ON THE LIGHTING PLAN SUBMITTED TO THE ENGINEER.

ALL CHANNELIZATION/DELINEATION DEVICES ARE TO BE PLACED SO AS TO PROVIDE A MINIMUM OF ONE FOOT CLEARANCE TO THE TRAVELED WAY UNLESS OTHERWISE SHOWN ON THE PLANS. THE CONTRACTOR SHALL MAKE CERTAIN THAT PLACEMENT OF CONES, DRUMS AND MARKERS OR BARRICADES SHALL NOT INTERFERE WITH SIGHT DISTANCE.

28

- LONGITUDINAL SPACING SHALL BE 40 FT. OTHER SPACING MAY BE REQUIRED AS SHOWN ON THE
- WHERE POSSIBLE A LATERAL BUFFER SPACE OF ONE FOOT SHOULD BE PROVIDED BETWEEN THE WORK ZONE AND THE LINE OF DELINEATION DEVICES.
- THE COST OF ANY DELINEATION AND GUIDING DEVICES (CONES, DRUMS, VERTICAL PANELS, ETC.) SHALL BE INCLUDED IN THE PRICE BID FOR ITEM 619.01 BASIC WORK ZONE TRAFFIC CONTROL.
- DRUMS ARE THE PREFERRED CHANNELIZING DEVICES TO BE USED DURING THE HOURS OF DARKNESS. DRUMS MUST BE USED ON TAPERS BOTH DAY AND NIGHT.

- LOCAL ROADS WORK 70NE TRAFFIC CONTROL

  1. WHEN THE VISIBILITY OF THE TRAVELING PUBLIC IS RESTRICTED DUE TO WEATHER CONDITIONS, AND/OR THE WORK OPERATIONS COMMENCE PRIOR TO DAWN OR CONTINUE BEYOND DUSK, FLASHING BEACONS (TYPE 'A' LIGHTS) SHALL BE PROVIDED.
- THE CONTRACTOR SHALL COORDINATE WITH NYSDOT REGION 5, PRIOR TO THE START OF ANY CONSTRUCTION THAT MAY IMPACT TRANSIT ROAD (NY ROUTE 78).

## LANE CLOSURES

- LANE CLOSURES FOR ANY CONTRUCTION OPERATIONS MUST BE CONDUCTED IN ACCORDANCE WITH THE 'LANE CLOSURE CHARTS' ON NYSTA STANDARD SHEET TA 619-36.
- THE CONTRACTOR SHALL PROVIDE FLAGGERS A.O.B.E. TO CONTROL TRAFFIC MOVEMENT ALONG RAMP WORK OPERATIONS REQUIRING TEMPORARY SHIFTING OF TRAFFIC FLOW ON PORTIONS OF THE TRAVEL WAY, FLAGGING IS NOT PERMITTED ON THRUWAY MAINLINE.
- NIGHTLY INTERCHANGE RAMP CLOSURES WILL BE ALLOWED ON A LIMITED BASIS FOR CONCRETE BARRIER WORK AND PAVINGOPERATIONS AS APPROVED BY BOTH THE PROJECT ENGINEER AND DIVISION TRAFFIC SUPERVISION. THE CONTRACTOR SHALL SUBMIT TO THE PROJECT ENGINEER FOR APPROVAL THE PROPOSED INTERCHANGE RAMP CLOSURE DETAILS, INCLUDING DETOUR PLAN, 21 DAYS PRIOR TO THE DESIRED CLOSURE. COST ASSOCIATED WITH PROPOSED INTERCHANGE RAMP CLOSURE(S) SHALL BE INCLUDED IN THE UNIT PRICE FOR WORK ZONE TRAFFIC CONTROL ITEMS.

### PAVEMENT MARKINGS

- THE COST OF REMOVAL OF EXISTING PAVEMENT MARKINGS, WHERE REQUIRED, SHALL BE INCLUDED IN THE PRICE BID FOR ITEMS 619.080101 AND 619.080102 - REMOVE PAVEMENT MARKING STRIPES (TRAFFIC PAINT) AND REMOVE PAVEMENT MARKING STRIPES (EPOXY PAINT).
- THE CONTRACTOR SHALL PROVIDE PAVEMENT MARKINGS AT ALL TIMES ON ALL PAVEMENT, WHETHER THE CONTRACTOR SHALL PROVIDE MAYEMENT MARKINGS AT ALL TIMES ON ALL FAVEMENT, WILLIAM EXISTING, TEMPORARY OR NEW, UNTIL PERMANENT MARKINGS ARE RENEWED OR RESTORED. THIS SHALL INCLUDE AT ALL APPROPRIATE LOCATIONS: EDGE LINES, LANE LINES (SOLID OR BROKEN), CHANNELIZING LINES, DOTTED LINES, PLUS ANY MARKINGS ORDERED BY THE ENGINEER. ALL MARKINGS SHALL BE APPLIED IN ACCORDANCE WITH THE STANDARD SPECIFICATIONS, CONTRACT PLANS AND THE NEW YORK STATE MUTCH SUPPLEMENT AND SHALL INDICATE ACTUAL CONDITIONS AT ALL TIMES. THESE MARKINGS SHALL BE PAID FOR AS SHOWN ON THE CONTRACT PLANS.
- 3. TEMPORARY WORK ZONE PAVEMENT MARKINGS, SHALL BE USED AS FOLLOWS: -MAINLINE - USE ITEM 619.0901 -RAMPS - USE ITEM 619.0901



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REVISIONS				NEW Thruway	TITLE OF PROJECT 1R MILL AND INLAY, SAFETY IMPROVEMENTS,	CONTRACT NUMBER:
DATE	DESCRIPTION	BY	SYM.		AND MISC. WORK	TAB 25-31
				<b>STATE</b> Authority	MP 416.90 TO MP 419.40	DATE: 08/20/25
					TITLE OF DRAWING	
					TRAFFIC CONTROL NOTES	DRAWING NUMBER:
						TCN-1

## PORTABLE VARIABLE MESSAGE DISPLAY UNITS

- THE CONTRACTOR SHALL PROVIDE UP TO 2 PORTABLE VARIABLE MESSAGE SIGNS (PVMS) WITH COMMUNICATION ABILITY (ITEM 619.110512) TO BE USED FOR THE DURATION OF THIS CONTRACT. PVMS ARE INTENDED TO SUPPLEMENT FIXED SIGNS AND ARE NOT INTENDED TO REPLACE THEM.
- TYPICAL APPLICATIONS FOR VARIABLE MESSAGE DISPLAY UNITS INCLUDE LOCATIONS WHERE:
  - A. TRAFFIC SPEED IS EXPECTED TO DROP SUBSTANTIALY.
    B. SIGNIFICANT QUEUING OR DELAYS ARE EXPECTED.
  - C. CHANGES IN ALIGNMENT OR SURFACE CONDITIONS OCCUR
  - D. LANES, RAMPS OR ROADWAYS ARE CLOSED.
  - SIGNIFICANT ACCIDENTS OR INCIDENTS HAVE OCCURED.
  - F. NIGHTTIME WORK IS PERFORMED. PERIOD OF ADVANCED NOTIFICATION TO BE DETERMINED BY THE ENGINEER.

- A. VARIABLE MESSAGE SIGNS ARE TO BE PLACED BEYOND THE SHOULDER WHEREVER PRACTICAL. B. VARIABLE MESSAGE SIGNS SHALL BE PLACED WHERE THEY ARE VISIBLE TO TRAFFIC FROM AT LEAST 2800 FEET AWAY BOTH DAY AND NIGHT OR APPROVED BY THE ENGINEER.
- PORTABLE VARIBLE MESSAGE SIGNS SHALL BE LOCATED AS DEEMED NECESSARY BY THE AUTHORITY'S PROJECT ENGINEER AND BY THE NYSTA DIVISION TRAFFIC SUPERVISOR. ALTHOUGH PAYMENT IS PER SIGN, THE CONTRACTOR MAY BE REQUIRED TO MOVE THE SIGNS AS OFTEN AS REQUESTED BY EITHER THE ENGINEER OR THE NYSTA DIVISION TRAFFIC SUPERVISOR. NO ADDITIONAL PAYMENT WILL BE MADE FOR SIGN MOVEMENTS.
- ALL MESSAGES DISPLAYED BY THE VARIABLE PORTABLE MESSAGE SIGNS SHALL BE APPROVED BY THE NYSTA DIVISION TRAFFIC SUPERVSIOR PRIOR TO USE.

- THE CONTRACTOR MUST PROVIDE SAFE AND CONVENIENT EMERGENCY ACCESS AT ALL TIMES DURING CONSTRUCTION. PRIOR TO THE START OF CONSTRUCTION, THE CONTRACTOR SHALL NOTIFY THE LOCAL FIRE, POLICE, AND AMBULANCE SERVICES TO COORDINATE THE PROPOSED CONSTRUCTION SCHEDULE, AND TO DEVELOP AN EMERGENCY ACCESS PLAN FOR ALL ROADS AND STREETS WITHIN THE PROJECT LIMITS.
- THE CONTRACTOR SHALL PROVIDE A WRITTEN LIST OF INDIVIDUALS RESPONSIBLE FOR EMERGENCY REPAIRS AND EMERGENCY COORDINATION. THIS "CALL OUT" LIST SHALL BE PROVIDED TO THE LOCAL FIRE, POLICE, AND AMBULANCE SERVICES, THE VILLAGE GOVERNMENT CENTER, AND THE ENGINEER, THIS LIST SHALL INCLUDE THE NAME, ADDRESS, AND TELEPHONE NUMBER(S) OF THE PERSONS AUTHORIZED TO SECURE LABOR, MATERIALS, AND EQUIPMENT FOR
- IF EMERGENCY ACCESS IS REQUIRED THROUGH ANY CLOSED WORK AREA, THE CONTRACTOR SHALL BE RESPONSIBLE TO ALWAYS BE PREPARED TO ALLOW EMERGENCY VEHICLES THROUGH THE CLOSED AREA. THIS MAY REQUIRE TRENCHES TO BE COVERED WITH STEEL PLATES, EXCAVATION DROP OFFS TO BE BACKED-UP AND RAMPED, OR THE ACTUAL PROGRESSION OF WORK TO BE SEQUENCED. THE COST OF ANY ADDITIONAL WORK NECESSARY TO MEET THIS REQUIREMENT SHALL BE INCLUDED IN THE PRICE BID FOR ITEM 619.01 - WORK ZONE TRAFFIC CONTROL.

## DELINEATORS

- 1. SEE NYSTA STANDARD SHEET TA 646-01 FOR DELINEATOR AND MILE MARKER DETAILS.
- EXISTING DELINEATORS AND MILE MARKERS DURING CONSTRUCTION: -RELOCATION AND MILE MARKERS BURING CONSTITUTION. -RELOCATION AND BACK-TO-BACK DELINEATOR AND MILE MARKERS COSTS SHALL BE INCLUDED UNDER ITEM 619.01. -DELINEATORS AND MILE MARKERS SHALL BE CLEARLY VISIBLE AT ALL TIMES.
- REMOVE AND REPLACE EXISTING DELINEATORS AND MILE MARKERS AT COMPLETION OF PROJECT IN ACCORDANCE WITH NYSTA STANDARD SHEET TA 646-01. PAYMENT SHALL BE MADE UNDER DELINEATOR AND MILE MARKERS REMOVAL AND NEW

'RE PREPARED TO STOP' SIGNS

 THE CONTRACTOR SHALL HAVE ON HAND "BE PREPARED TO STOP" SIGNS (W3-4) TO BE INSTALLED IN ADVANCE OF LANE CLOSURE SETUPS WHERE THE ENGINEER DETERMINES THEY ARE NECESSARY. THE SIGNS AS WELL AS ADDITIONAL W20-1 "ROAD WORK" SIGNS SHALL BE PLACED AND RELOCATED AS NECESSARY IN ACCORDANCE WITH SECTION 619-3.02H.5 OF THE STANDARD SPECIFICATIONS AND AS MODIFIED BY THE CONTRACT PROPOSAL. THE CONTRACTOR SHALL HAVE THESE SIGNS (48" X 48") TRUCK MOUNTED AND READY FOR AN INCIDENT ON SHORT NOTICE.

## CONSTRUCTION INGRESS AND EGRESS


- VEHICLES, MATERIALS, AND/OR EQUIPMENT, INCLUDING OUT OF SERVICE SIGNS, SHALL NOT BE PARKED OR STORED WITHIN 30 FT. OF THE ROADWAY USED BY THE GENERAL PUBLIC OR ANY OTHER AREAS DEEMED HAZARDOUS BY THE EIC.
- VEHICLES PARKED BEHIND GUIDERAIL/BARRIER SHALL BE PARKED BEYOND DEFLECTION DISTANCE AND WITHIN THE

## BARRIER/SHADOW VEHICLES

- IN ADDITION TO THE REQUIREMENTS OF SECTION 619-2.02G AND 619-3.02G OF THE NYS STANDARD SPECIFICATIONS, AND UNLESS OTHERWISE APPROVED BY THE ENGINEER, THE CONTRACTOR SHALL PROVIDE BARRIER/SHADOW VEHICLES FOR ALL ACTIVE WORK AREAS OCCUPYING ANY TRAVEL LANE OR SHOULDER CLOSED TO TRAFFIC WITH CONES, DRUMS OR OTHER CHANNELIZING DEVICES. A SEPARATE BARRIER/SHADOW VEHICLE SHALL BE PROVIDED IN EACH CLOSED LANE
- EXCEPTIONS TO THE REQUIREMENT MAY BE MADE WHERE, IN THE JUDGEMENT OF THE ENGINEER, THE BARRIER/SHADOW VEHICLE PLACEMENT WOULD BE INEFFECTIVE OR WOULD INTERFERE WITH THE SAFE OPERATION OF TRAFFIC AT OR
- THE BARRIER/SHADOW VEHICLES SHALL TYPICALLY BE LOCATED AS INDICATED ON THE PLANS, UNLESS OTHERWISE DIRECTED BY THE ENGINEER. IF THE WORK AREAS MOVE WITHIN A STATIONARY LANE OR SHOULDER CLOSURE THE BARRIER/SHADOW VEHICLE SHALL BE RE-POSITONED ACCORDINGLY.
- PAYMENT FOR TYPICAL BARRIER/SHADOW VEHICLES SHALL BE INCLUDED IN THE PRICE BID FOR ITEM 619.01 BASIC WORK ZONE TRAFFIC CONTROL.
- THE ARROW PANEL SHALL OPERATE IN THE "CAUTION MODE" WHEN IN USE. A "4 CORNER FLASH" SHALL ONLY BE PERMITTED. A FLASHING BAR DISPLAY SHALL NOT BE PERMITTED FOR THE CAUTION MODE. USE "4 LAMPS FLASHING 5. SIMULTANEOUSLY" OR "2 PAIRS OF LAMPS FLASHING IN A PATTERN". A DIRECTION WILL NOT BE INDICATED.
- ANY ROADWAY DEBRIS PICKUP BY CONTRACTOR PERSONNEL SHALL BE PROTECTED BY A SHADOW VEHICLE WITH IMPACT ATTENUATOR.

### DRAINAGE

1. THE CONTRACTOR MUST MAINTAIN EXISTING DRAINAGE AT ALL TIMES DURING CONSTRUCTION.

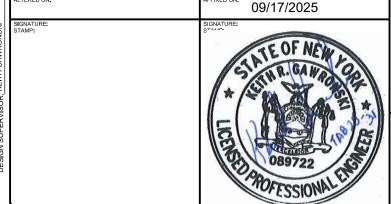



IT IS A VIOLATION OF LAW FOR ANY PERSON, UNLESS THEY ARE ACTING UNDER THE DIRECTION OF A LICENSED PROFESSIONAL ENGINEER, ARCHITECT, LANDSCAPE ARCHITECT, OR LAND SURVEYOR, TO ALTER AN ITEM IN ANY WAY, IF AN ITEM BEARING THE STAMP OF A LICENSED PROFESSIONAL IS ALTERED, THE ALTERING ENGINEER, ARCHITECT LANDSCAPE ARCHITECT, OR LAND SURVEYOR SHALL STAMP THE DOCUMENT AND INCLUDE THE NOTATION "ALTERED BY" FOLLOWED BY THEIR SIGNATURE, THE DATE OF SUCH ALTERATION, AND A SPECIFIC DESCRIPTION OF THE ALTERATION.

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TITLE OF PROJECT
1R MILL AND INLAY, SAFETY IMPROVEMENTS
AND MISC. WORK TAB 25-31 ority PROJECT MP 416,90 TO 419,40 08/20/25 TRAFFIC CONTROL NOTES


TCN-2



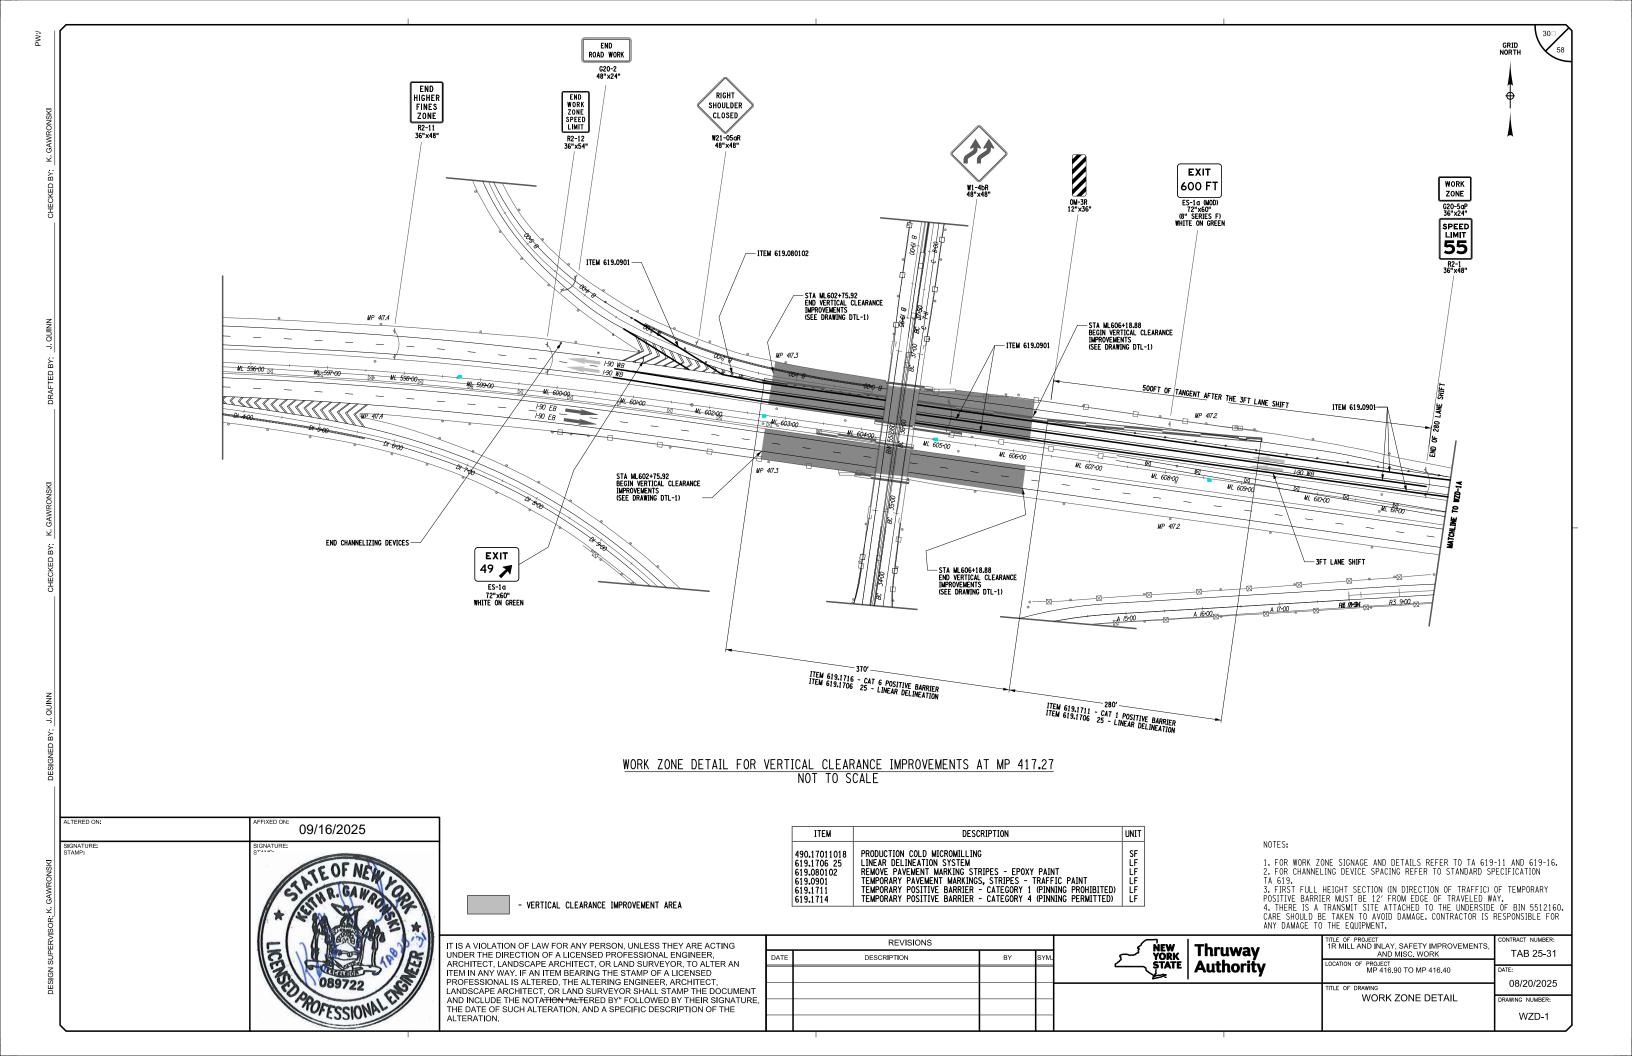
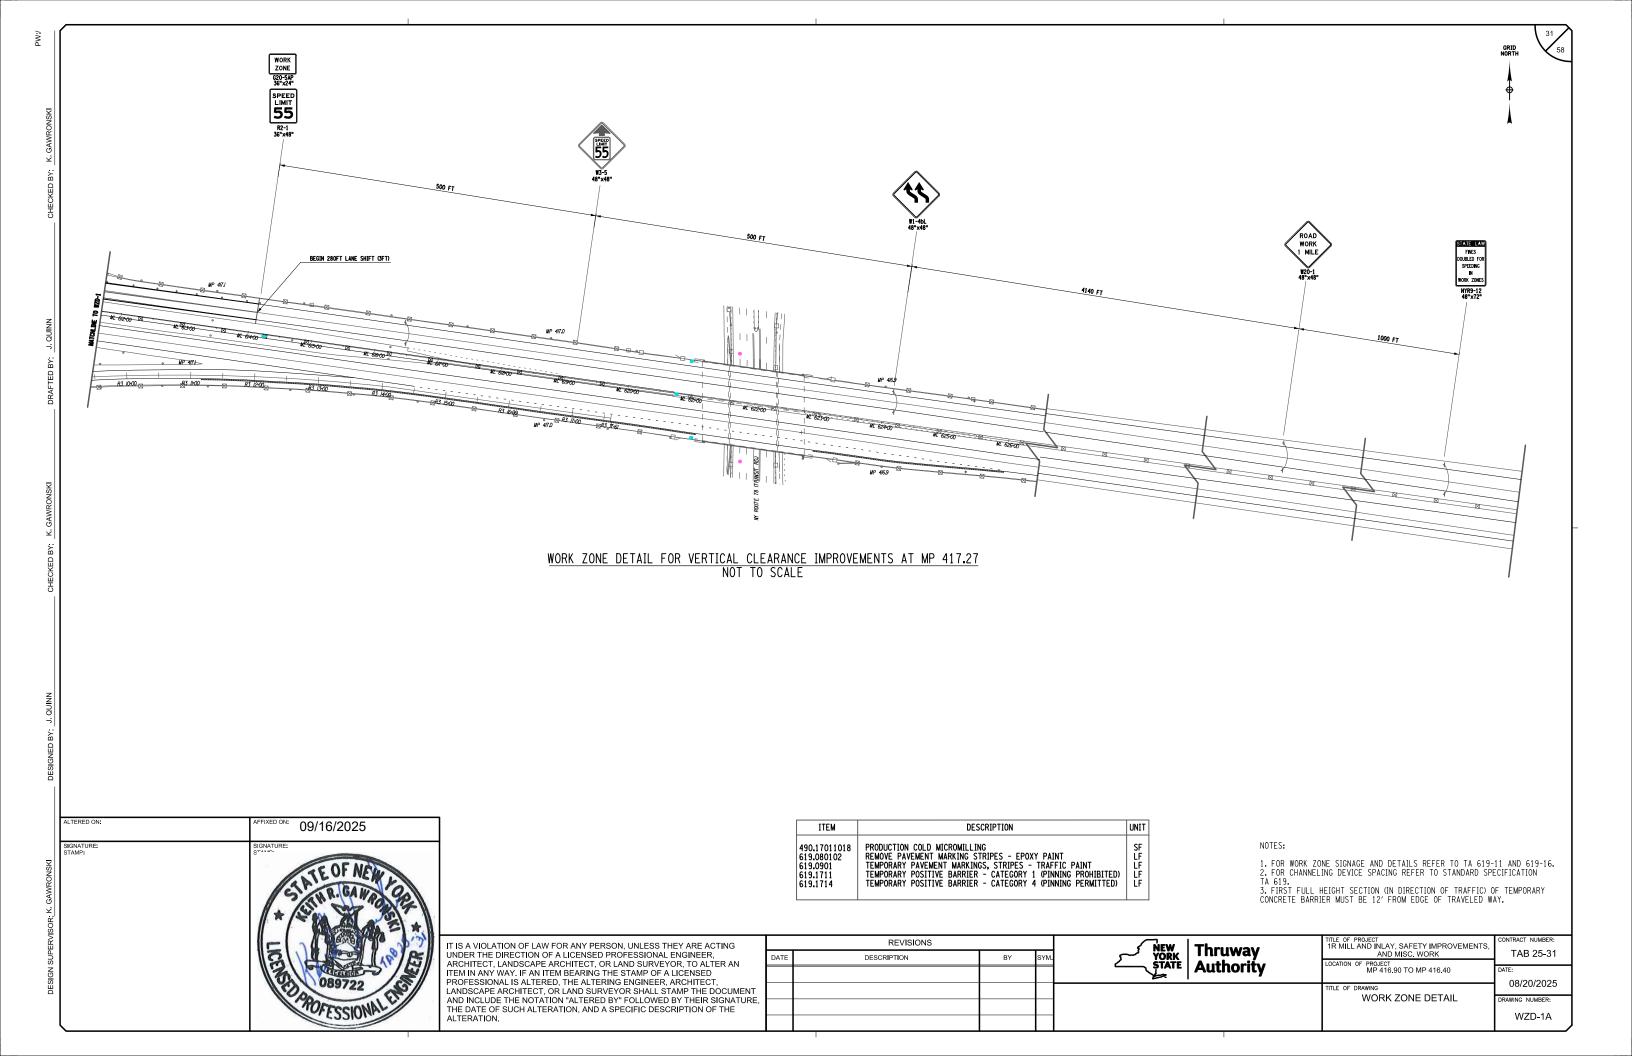
## PHASE 1

-2" MICROMILL EXISTING SURFACE -ADD TEMPORARY PAVEMENT STRIPING

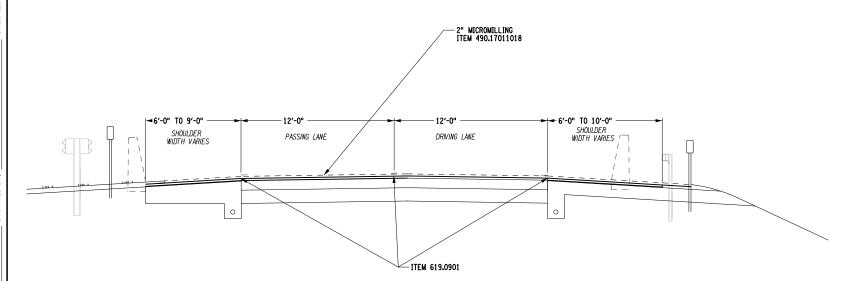


VERTICAL CLEARANCE IMPROVEMENT CROSS SECTION DETAIL

SECTION C-C (EASTBOUND)
NOT TO SCALE

# ITEM DESCRIPTION 490.17011018 PRODUCTION COLD MICROMILLING TEMPORARY PAVEMENT MARKINGS, STRIPES - TRAFFIC PAINT

## NOTES:

- 1. SEE DTL-1 FOR VERTICAL CLEARANCE IMPROVEMENT DETAIL AND REFERENCES TO SECTIONS.
- 2. TRAFFIC WILL BE PERMITTED TO DRIVE ON MICROMILLED SURFACE.

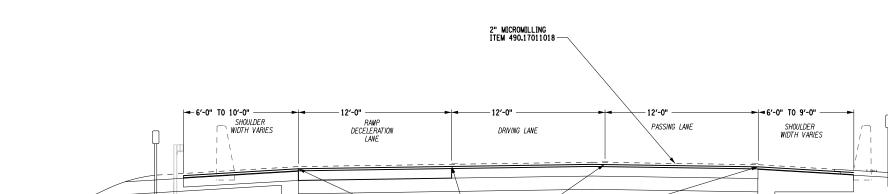

VERTICAL CLEARANCE IMPROVEMENT CROSS SECTION WORK ZONE DETAIL

ITEM 619.0901

SECTION B-B (WESTBOUND)
NOT TO SCALE

IT IS A VIOLATION OF UNDER THE DIRECTIC ARCHITECT, LANDSCO, ITEM IN ANY WAY, IF A PROFESSIONAL IS ALL LANDSCAPE ARCHITE AND INCLUDE THE NOTHE DATE OF SUCH A

09/09/2025

IT IS A VIOLATION OF LAW FOR ANY PERSON, UNLESS THEY ARE ACTING
UNDER THE DIRECTION OF A LICENSED PROFESSIONAL ENGINEER,
ARCHITECT, LANDSCAPE ARCHITECT, OR LAND SURVEYOR, TO ALTER AN
ITEM IN ANY WAY. IF AN ITEM BEARING THE STAMP OF A LICENSED
PROFESSIONAL IS ALTERED, THE ALTERING ENGINEER, ARCHITECT,
LANDSCAPE ARCHITECT, OR LAND SURVEYOR SHALL STAMP THE DOCUMENT
AND INCLUDE THE NOTATION "ALTERED BY" FOLLOWED BY THEIR SIGNATURE,
THE DATE OF SUCH ALTERATION, AND A SPECIFIC DESCRIPTION OF THE
ALTERATION.

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TITLE OF PROJECT 1R MILL AND INILAY, SAFETY IMPROVEMENTS, AND MISC, WORK TAB 25-31

LOCATION OF PROJECT MP 416,90 TO MP 419,40

TITLE OF DRAWING WORK ZONE DETAIL

TOTAL OF PROJECT OR PROJ

**Thruway** 


Authority

UNIT

## 33 5

## PHASE 2

-RECONSTRUCT DECELERATION LANE UP TO NEW SURFACE
-TEMPORARY POSITIVE BARRIER
-REMOVE TEMPORARY PAVEMENT STRIPING
-ADD NEW TEMPORARY PAVEMENT STRIPING

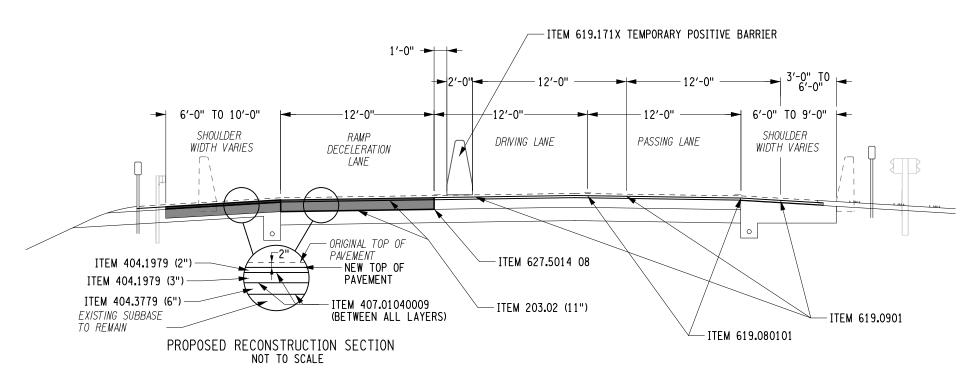

# VERTICAL CLEARANCE IMPROVEMENT CROSS SECTION WORK ZONE DETAIL SECTION B-B (WESTBOUND) NOT TO SCALE

ITEM	DESCRIPTION	UNIT
203.02 404.1979 404.3779 407.01040009 619.080101 619.0901 619.171X 627.5014 08	UNCLASSIFIED EXCAVATION AND DISPOSAL 19 F9 BINDER COURSE ASPHALT, 70 SERIES COMPACTION 37.5 F9 BASE COUSE ASPHALT, 70 SERIES COMPACTION NON-TRACKING TACK COAT REMOVE PAVEMENT MARKING STRIPES - TRAFFIC PAINT TEMPORARY PAVEMENT MARKINGS, STRIPES - TRAFFIC PAINT TEMPORARY POSITIVE BARRIER CUTTING PAVEMENT	CY TON TON GAL LF LF LF

## NOTES:

1. SEE DTL-1 FOR VERTICAL CLEARANCE IMPROVEMENT DETAIL AND REFERENCES TO SECTIONS.

ALTERED ON:	AFFIXED ON: 09/09/2025
SIGNATURE: STAMP:	SIGNATURE: STATUS OF NEW CONTROL OF


- EXISTING ASPHALT
- EXISITNG CONCRETE


IT IS A VIOLATION OF LAW FOR ANY PERSON, UNLESS THEY ARE ACTI UNDER THE DIRECTION OF A LICENSED PROFESSIONAL ENGINEER, ARCHITECT, LANDSCAPE ARCHITECT, OR LAND SURVEYOR, TO ALTEI ITEM IN ANY WAY. IF AN ITEM BEARING THE STAMP OF A LICENSED PROFESSIONAL IS ALTERED, THE ALTERING ENGINEER, ARCHITECT, LANDSCAPE ARCHITECT, OR LAND SURVEYOR SHALL STAMP THE DOWN AND INCLUDE THE NOTATION "ALTERED BY" FOLLOWED BY THEIR SIGNIFICATION OF SUCH ALTERATION, AND A SPECIFIC DESCRIPTION OF TALTERATION.	R AN CUMENT GNATURE,
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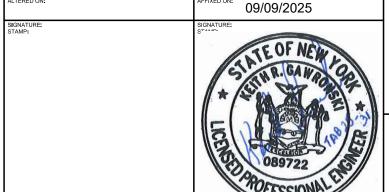
REVISIONS				NEW Thruway	1R MILL AND INLAY, SAFETY IMPROVEMENTS,	CONTRACT NUMBER:	1
TE	DESCRIPTION	BY	SYM.	1 IURN I	AND MISC. WORK	TAB 25-31	⅃
				STATE   Authority	MP 416.90 TO MP 419.40	DATE:	1
					TITLE OF DRAWING	08/20/2025	L
					WORK ZONE DETAIL	DRAWING NUMBER:	1
						WZD-2A	J

## PHASE 3

-REMOVE TEMPORARY POSITIVE BARRIER -2" MILL AND REPLACE WITH 2" 9.5 TOP COURSE -ML PAVEMENT STRIPING -RECESS DIAMOND GRINDING FOR INLAID PAVEMENT MARKINGS



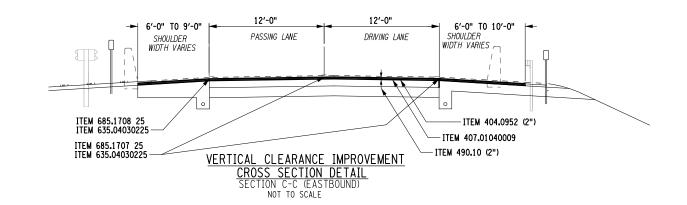

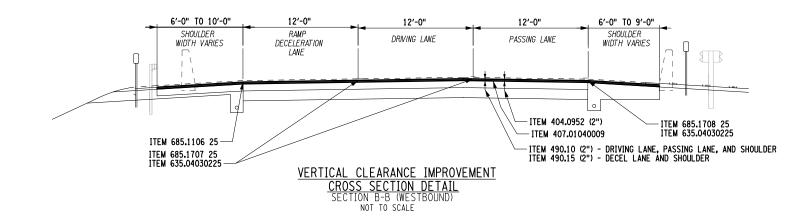


NEW TOP OF PAVEMENT

IT IS A VIOLATION OF LAW FOR ANY PERSON, UNLESS THEY ARE ACTING UNDER THE DIRECTION OF A LICENSED PROFESSIONAL ENGINEER, ARCHITECT, LANDSCAPE ARCHITECT, OR LAND SURVEYOR, TO ALTER AN ITEM IN ANY WAY, IF AN ITEM BEARING THE STAMP OF A LICENSED PROFESSIONAL IS ALTERED, THE ALTERING ENGINEER, ARCHITECT LANDSCAPE ARCHITECT, OR LAND SURVEYOR SHALL STAMP THE DOCUMENT AND INCLUDE THE NOTATION "ALTERED BY" FOLLOWED BY THEIR SIGNATURE, THE DATE OF SUCH ALTERATION, AND A SPECIFIC DESCRIPTION OF THE ALTERATION.

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TITLE OF PROJECT
1R MILL AND INLAY, SAFETY IMPROVEMENTS
AND MISC. WORK TAB 25-31 PROJECT MP 416.90 TO MP 419.40 08/20/2025 WORK ZONE DETAIL WZD-2B



## TYPICAL SHOULDER SECTION VC IMPROVEMENT
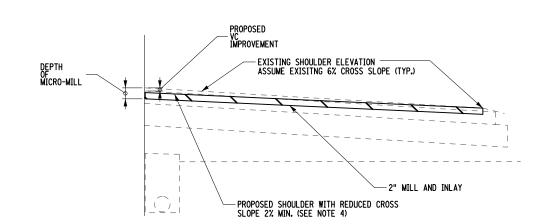
## NOTES:

1. THE CONTRACTOR IS RESPONSIBLE TO MEASURE THE VERTICAL CLEARANCE(S) AT THE BRIDGE LOCATIONS LISTED HERE-IN PRIOR TO THE START OF MILLING AND AFTER COMPLETION OF THE PAVING OPERATION. THE CONTRACTOR IS RESPONSIBLE TO GAIN VERTICAL CLEARANCE A.O.B.E. THE CONTRACTOR SHALL SUBMIT PRE-PAVING MEASUREMENTS TO THE AUTHORITY FOR REVIEW PRIOR TO PAVING, THE CONTRACTOR SHALL SUBMIT TO THE AUTHORITY POST-PAVING MEASUREMENTS WITHIN ONE WEEK OF PAVING COMPLETION AT THE DESPECTIVE PRODUCT ACCUSTOMY. RESPECTIVE BRIDGE LOCATIONS.

2. CROSS SLOPES OF THE THRUWAY MAY VARY FROM NORMAL CROWN TO FULL SUPER ELEVATION (BOTH BANKED LEFT AND RIGHT). THE PROPOSED TRAVEL LANE CROSS SLOPE SHALL MATCH THE EXISTING CROSS SLOPE IN ALL CASES.


3. PLACE TACK COAT ON ALL EXPOSED SURFACES WHICH WILL BE IN CONTACT WITH NEW ASPHALT. COST TO BE PAID FOR UNDER ITEM 407.01040009.

4. EXISTING EDGE OF SHOULDER ELEVATION SHALL REMAIN THE SAME. THE SHOULDER CROSS SLOPE SHALL BE REDUCED TO GAIN VERTICAL CLEARANCE AND STILL ALLOW DRAINAGE. SHOULDER CROSS SLOPE SHALL NOT BE LESS THAN 2% PER NYSTA STANDARD SHEET TA 402-03.


5. BRIDGE WIDTHS SHALL BE FIELD VERIFIED.

6. SEE DTL-1 FOR VERTICAL CLEARANCE DETAIL AND REFERENCES TO SECTIONS.

ITEM	DESCRIPTION	UNIT
404 <b>.</b> 0952 407.01040009	9.5 F9 TOP COURSE ASPHALT, 50 SERIES COMPACTION	TON GAL
490.10 490.15	PRODUCTION COLD MILLING OF BITUMINOUS CONCRETE PRODUCTION COLD MILL SURFACE PLANING OF BITUMINOUS CONCRETE	SY
635.04030225	RECESS DIAMOND GRINDING FOR INLAID PAVEMENT MARKINGS	LF
685.1106 25 685.1707 25	WHITE EPOXY REFLECTORIZED PAVEMENT STRIPES 6" x 20 MILS WHITE HIGHLY REFLECTORIZED TRIPLE DROP EPOXY PAVEMENT STRIPES	LF LF
685.1708 25	YELLOW HIGHLY REFLECTORIZED TRIPLE DROP EPOXY PAVEMENT STRIPES	LF

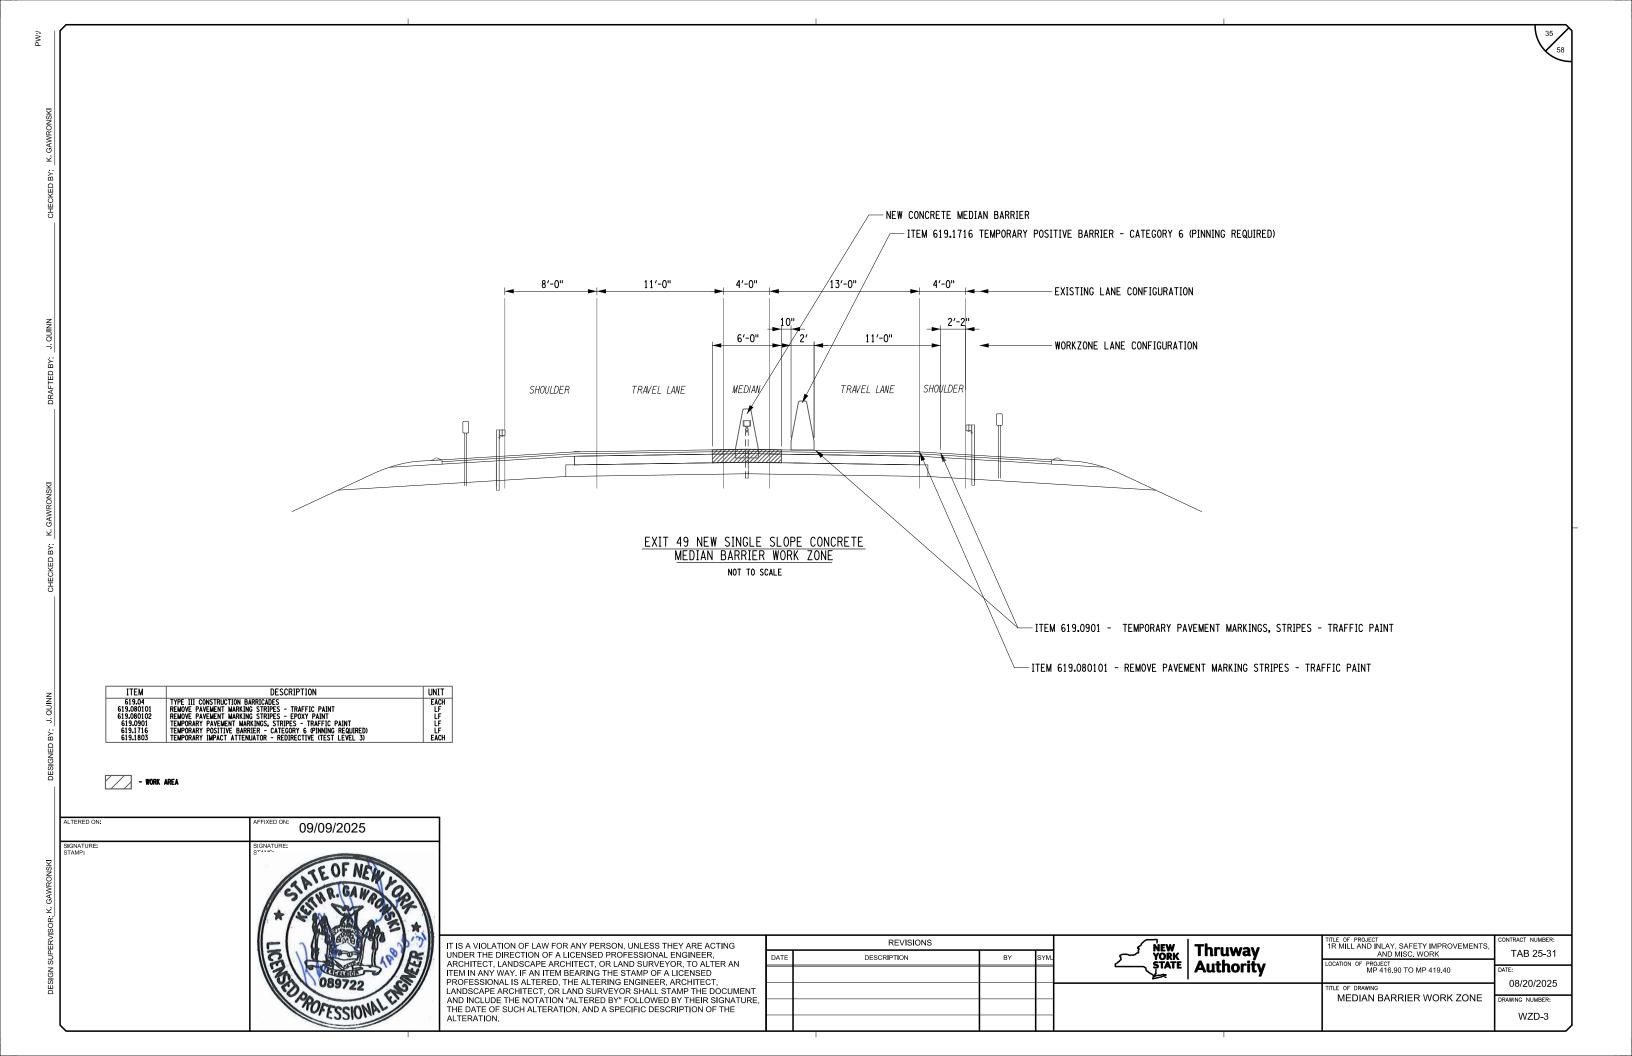


ITEM

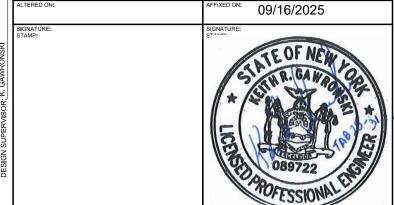

DESCRIPTION

TYPE III CONSTRUCTION BARRICADES
REMOVE PAVEMENT MARKING STRIPES - TRAFFIC PAINT
REMOVE PAVEMENT MARKING STRIPES - EPOXY PAINT
REMOVE PAVEMENT MARKING STRIPES - PRAFFIC PAINT
AUTOMATED FLAGGING ASSISTANT DEVICE
TEMPORARY POSITIVE BARRIER - CATEGORY 6 (PINNING REQUIRED)
TEMPORARY IMPACT ATTENUATOR - REDIRECTIVE (TEST LEVEL 2)

UNIT

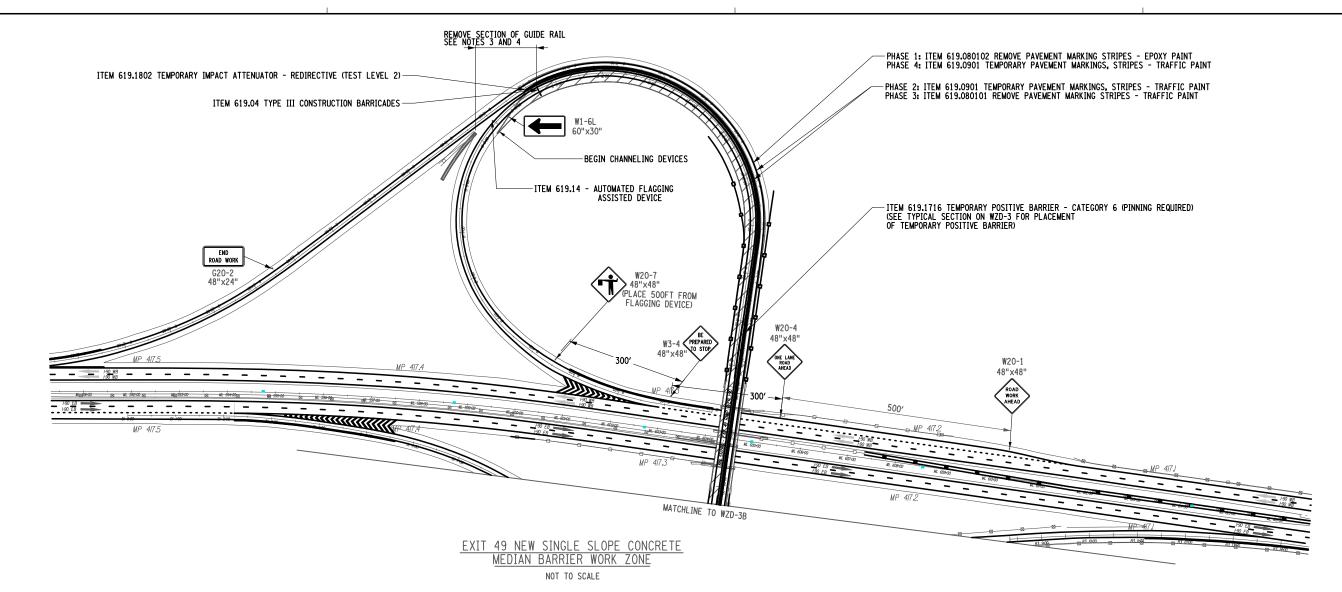

NOTES: 1. FLAGGING OPERATIONS SHALL BE ALLOWED DURING NIGHT TIME OPERATIONS. SEE 619 STANDARD SPECIFICATIONS FOR ADDITIONAL REQUIREMENTS FOR NIGHT TIME FLAGGING.

2. ALL SIGNS MAY BE FOUND IN THE MANUAL FOR UNIFORM TRAFFIC CONTROL DEVICES. ALL "W' SIGNS SHALL BE BLACK ON FLUORESENT ORANGE IN COLOR.

3. SEE TRAFFIC CONTROL NOTE PLAN SHEETS FOR ADDITIONAL DETAILS.

4. A SECTION OF BOX BEAM MEDIAN BARRIER TO BE REMOVED A LENGTH EQUAL TO APPROXIMATELY 162 FT OR A.O.B.E. TEMPORARY POSTIVE BARRIER CATEGORY 6 (PINNING REQUIRED) WITH TEMPORARY IMPACT ATTENUATORS ON THE EXPOSED ENDS TO BE PLACED BETWEEN EXISTING BOX BEAM MEDIAN BARRIER AND ONE WAY TRAVEL LANE A.O.B.E. ONCE TEMPORARY BARRIER HAS BEEN PLACED AND APPROVED, THE BOX BEAM MEDIAN BARRIER CAN BE REPLACED WITH

5. WORK IN THIS SECTION MAY REQUIRE ADDITIONAL MEDIAN BARRIER TO BE REMOVED. ADDITIONAL FLAG PERSON/SIGNAGE MAY BE REQUIRED TO PROPERLY CONTROL TRAFFIC IN THIS SECTION.

6. CONTRACTOR TO CONTROL TRAFFIC TO ONE LANE WITH AUTOMATED FLAGGER ASSISTANT ON RAMP DURING NIGHTTIME CONSTRUCTION OPERATIONS.

7. AT THE END OF DAILY CONSTRUCTION, THE AUTOMATED FLAGGER SHALL BE REMOVED AND CLOSELY SPACED DELINEATION DEVICES SHALL BE PLACED IN THE OPENINGS IN THE MEDIAN BARRIER AND ALL FLAGGING SIGNS (OR OTHER NON APPLICABLE SIGNS) SHALL BE COVERED OR REMOVED.


8. NIGHTLY INTERCHANGE RAMP CLOSURES WILL BE ALLOWED ON A LIMITED BASIS FOR CONCRETE BARRIER WORK AND PAYING OPERATIONS AS APPROVED BY BOTH THE PROJECT ENGINEER AND DIVISION TRAFFIC SUPERVISION, THE CONTRACTOR SHALL SUBMIT TO THE PROJECT ENGINEER FOR APPROVAL THE PROPOSED INTERCHANGE RAMP CLOSURE DETAILS INCLUDING DETOUR PLAN, 21 DAYS PRIOR TO THE DESIRED CLOSURE, COSTS ASSOCIATED WITH PROPOSED INTERCHANGE RAMP CLOSURE(S) SHALL BE INCLUDED IN THE UNIT PRICE BID FOR WORK ZONE TRAFFIC CONTROL ITEMS.

9. TRAFFIC QUEUES CREATED FROM THE FLAGGING OPERATION SHALL NOT EXTEND OR DISRUPT MAINLINE I-90 THROUGH TRAFFIC. IF THIS OCCURS, IMMEDIATELY PLACE MOBILE "BE PREPARED TO STOP" SIGNAGE PRIOR TO EXIT 49 UNTIL QUEUE IS CLEARED.

IT IS A VIOLATION OF LAW FOR ANY PERSON, UNLESS THEY ARE ACTING UNDER THE DIRECTION OF A LICENSED PROFESSIONAL ENGINEER, ARCHITECT, LANDSCAPE ARCHITECT, OR LAND SURVEYOR, TO ALTER AN ITEM IN ANY WAY, IF AN ITEM BEARING THE STAMP OF A LICENSED PROFESSIONAL IS ALTERED, THE ALTERING ENGINEER, ARCHITECT LANDSCAPE ARCHITECT, OR LAND SURVEYOR SHALL STAMP THE DOCUMENT AND INCLUDE THE NOTATION "ALTERED BY" FOLLOWED BY THEIR SIGNATURE, THE DATE OF SUCH ALTERATION, AND A SPECIFIC DESCRIPTION OF THE ALTERATION.

		REVISIONS	REVISIONS NEW Thruway			1R MILL AND INLAY, SAFETY IMPROVEMENTS,	CONTRACT NUMBER:
	DATE	DESCRIPTION	BY	SYM.	NEW Thruway  YORK Authority	AND MISC. WORK	TAB 25-31
					Authority	MP 416.90 TO MP 419.40	DATE:
-						TITLE OF DRAWING	08/20/2025
Ξ,						MEDIAN BARRIER WORK ZONE	DRAWING NUMBER:
							WZD-3A

ALTERED ON: 09/16/2025

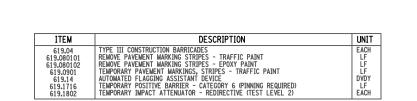

W20-7 48"x48" (SIGN SHALL BE PLACED 500FT FROM AUTOMATED FLAGGER LOCATION)

- WORK AREA

IT IS A VIOLATION OF LAW FOR ANY PERSON, UNLESS THEY ARE ACTING UNDER THE DIRECTION OF A LICENSED PROFESSIONAL ENGINEER, ARCHITECT, LANDSCAPE ARCHITECT, OR LAND SURVEYOR, TO ALTER AN ITEM IN ANY WAY, IF AN ITEM BEARING THE STAMP OF A LICENSED PROFESSIONAL IS ALTERED, THE ALTERING ENGINEER, ARCHITECT LANDSCAPE ARCHITECT, OR LAND SURVEYOR SHALL STAMP THE DOCUMENT AND INCLUDE THE NOTATION "ALTERED BY" FOLLOWED BY THEIR SIGNATURE, THE DATE OF SUCH ALTERATION, AND A SPECIFIC DESCRIPTION OF THE ALTERATION.

END ROAD WORK G20-2 48"x24"

EXIT 49 NEW SINGLE SLOPE CONCRETE MEDIAN BARRIER WORK ZONE

	REVISIONS								
	DATE	DESCRIPTION	BY	SYM.					
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					1				

NEW YORK Thruway STATE Authority

TITLE OF PROJECT
1R MILL AND INLAY, SAFETY IMPROVEMENTS
AND MISC. WORK LOCATION OF PROJECT MP 416.90 TO MP 419.40 MEDIAN BARRIER WORK ZONE

08/20/2025 WZD-3B

TAB 25-31

MATCHLINE TO WZD-3A 48"x24" ITEM 619.04 TYPE III CONSTRUCTION BARRICADES REMOVE SECTION OF GUIDE RAIL SEE NOTES 4 AND 5 ITEM 619.1802 TEMPORARY IMPACT ATTENUATOR - REDIRECTIVE (TEST LEVEL 2) ITEM 619.14 AUTOMATED FLAGGING SYSTEM\_

2. ALL SIGNS MAY BE FOUND IN THE MANUAL FOR UNIFORM TRAFFIC CONTROL DEVICES. ALL "W' SIGNS SHALL BE BLACK ON FLUORESENT ORANGE IN COLOR. 3. SEE TRAFFIC CONTROL NOTE PLAN SHEETS FOR ADDITIONAL DETAILS.

4. A SECTION OF BOX BEAM MEDIAN BARRIER TO BE REMOVED A LENGTH EQUAL TO APPROXIMATELY 162 FT OR A.O.B.E. TEMPORARY POSTIVE BARRIER CATEGORY 6 (PINNING REQUIRED) WITH TEMPORARY IMPACT ATTENUATORS ON THE EXPOSED ENDS TO BE PLACED BETWEEN EXISTING BOX BEAM MEDIAN BARRIER AND ONE WAY TRAVEL LANE A.O.B.E. ONCE TEMPORARY BARRIER HAS BEEN PLACED AND APPROVED, THE BOX BEAM MEDIAN BARRIER CAN BE REPLACED WITH

NOTES: 1. FLAGGING OPERATIONS SHALL BE ALLOWED DURING NIGHT TIME OPERATIONS. SEE 619 STANDARD SPECIFICATIONS FOR ADDITIONAL REQUIREMENTS FOR NIGHT TIME FLAGGING.


5. WORK IN THIS SECTION MAY REQUIRE ADDITIONAL MEDIAN BARRIER TO BE REMOVED. ADDITIONAL FLAG PERSON/SIGNAGE MAY BE REQUIRED TO PROPERLY CONTROL TRAFFIC IN THIS SECTION.


6. CONTRACTOR TO CONTROL TRAFFIC TO ONE LANE WITH AUTOMATED FLAGGER ASSISTANT ON RAMP DURING NIGHTTIME CONSTRUCTION OPERATIONS.

7. AT THE END OF DAILY CONSTRUCTION, THE AUTOMATED FLAGGER SHALL BE REMOVED AND CLOSELY SPACED DELINEATION DEVICES SHALL BE PLACED IN THE OPENINGS IN THE MEDIAN BARRIER AND ALL FLAGGING SIGNS (OR OTHER NON APPLICABLE SIGNS) SHALL BE COVERED OR REMOVED.

8. NIGHTLY INTERCHANGE RAMP CLOSURES WILL BE ALLOWED ON A LIMITED BASIS FOR CONCRETE BARRIER WORK AND PAVING OPERATIONS AS APPROVED BY BOTH THE PROJECT ENGINEER AND DIVISION TRAFFIC SUPERVISION. THE CONTRACTOR SHALL SUBMIT TO THE PROJECT ENGINEER FOR APPROVAL THE PROPOSED INTERCHANGE RAMP CLOSURE DETAILS INCLUDING DETOUR PLAN, 21 DAYS PRIOR TO THE DESIRED CLOSURE, COSTS ASSOCIATED WITH PROPOSED INTERCHANGE RAMP CLOSURE(S) SHALL BE INCLUDED IN THE UNIT PRICE BID FOR WORK ZONE TRAFFIC CONTROL ITEMS.

9. TRAFFIC QUEUES CREATED FROM THE FLAGGING OPERATION SHALL NOT EXTEND OR DISRUPT MAINLINE I-90 THROUGH TRAFFIC. IF THIS OCCURS, IMMEDIATELY PLACE MOBILE "BE PREPARED TO STOP" SIGNAGE PRIOR TO EXIT 49 UNTIL QUEUE IS CLEARED.

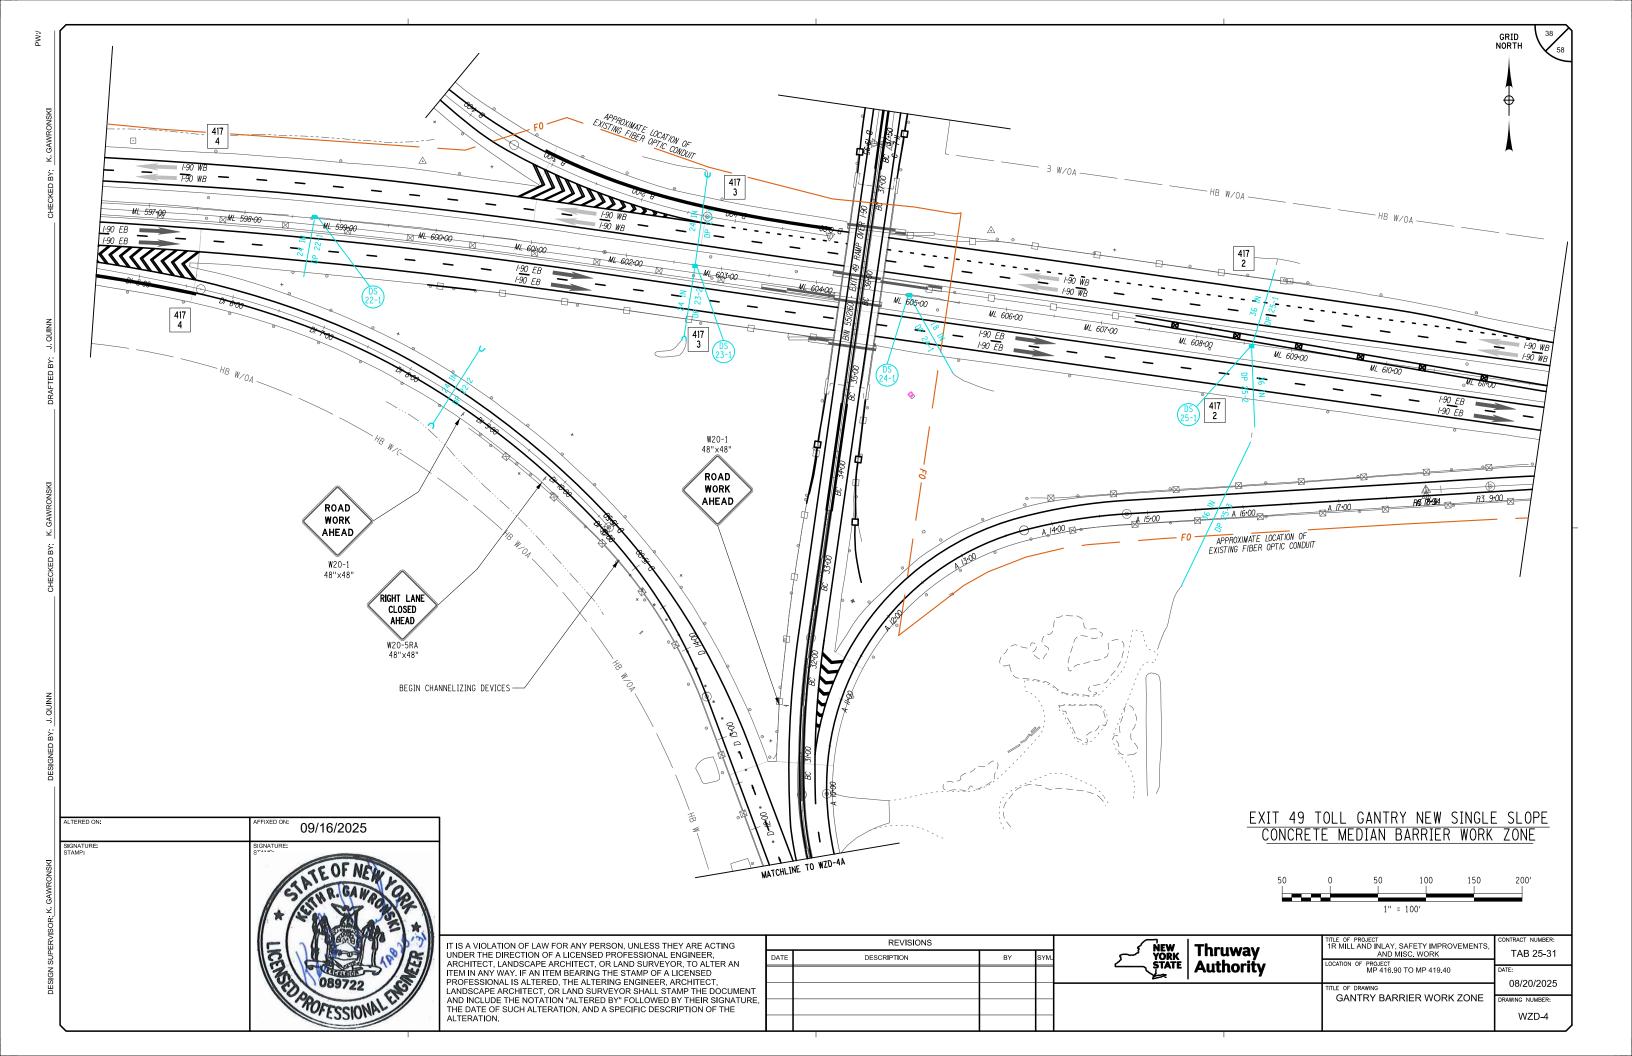

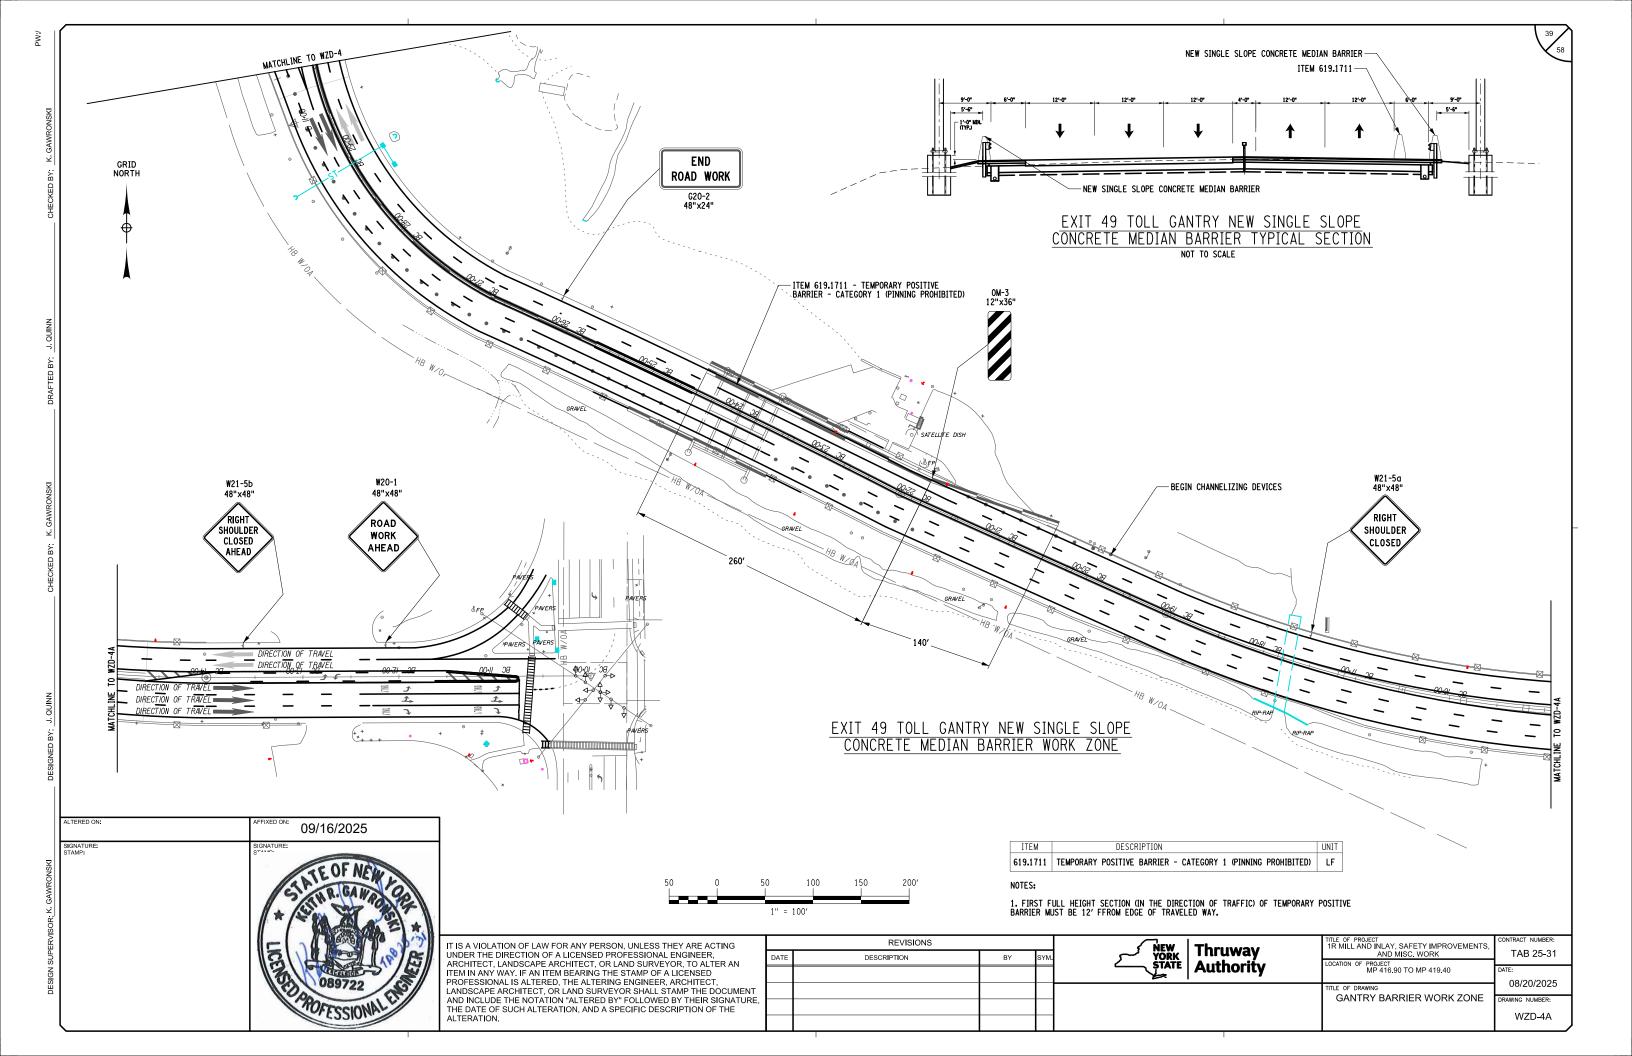

DS#	STATION	DESCRIPTION OF WORK	EXIST T.G. ELEV.	PROP T.G. ELEV.	SIDE / SIZE / INVERT ELEV.	621.04	621.0			
DS 1-1	ML 492+57.25	ALTER FRAME AND GRATE ELEVATION	701.43	701.06	N. / 18" / 697.01	S. / 18" / 697.01			<b>(EA)</b>	(LF)
	WIL 492101.20	AND CLEAN STRUCTURE	701.43	701.00					'	00
DP 1-1		CLEAN PIPE FROM DS 1-1 TO DS 1-2			18" / 697.91	18" / 697.01				66
DS 1-2	ML 493+00.92	CLEAN STRUCTURE	702.57	702.57	S. / 18" / 697.91				1	
DP 1-2		CLEAN PIPE FROM DS 1-1 TO DS 1-3			18" / 697.91	18" / 697.01				64
DS 1-3	ML 493+05.97	CLEAN STRUCTURE	702.66	702.66	N. / 18" / 697.91				1	
DS 2-1	ML 503+57.49	ALTER FRAME AND GRATE ELEVATION AND CLEAN STRUCTURE	709.83	709.46	W. / 12" / 703.35				1	
DP 2-1		CLEAN PIPE FROM DS 2-1 TO DS 2-2			12" / 703.35	12" / 702.37				27
DS 2-2	ML 500+81.24	ALTER FRAME AND GRATE ELEVATION AND CLEAN STRUCTURE	707.70	707.33	E. / 12" / 702.37	W. / 12" / 702.30			1	
DP 2-2		CLEAN PIPE FROM DS 2-2 TO DS 2-3			12" / 702.30	12" / 700.67				29
DS 2-3	ML 497+78.37	ALTER FRAME AND GRATE ELEVATION AND CLEAN STRUCTURE	705.49	705.12	E. / 12" / 700.67	W. / 12" / 700.63			1	
DP 2-3		CLEAN PIPE FROM DS 2-3 TO DS 2-4			12" / 700.63	12" / 698.21				29
DS 2-4	ML 494+80.04	ALTER FRAME AND GRATE ELEVATION	704.03	703.66	E. / 12" / 698.21	N. / 18" / 69821			1	
DP 2-4		AND CLEAN STRUCTURE  CLEAN PIPE FROM DS 2-4 TO OUTLET			18" / 698.21	18" / 698.00				10
DS 3-1	ML 506+79.45	ALTER FRAME AND GRATE ELEVATION	709.83	709.46	E. / 12" / 704.78				1	
DP 3-1	WE 300 173.43	AND CLEAN STRUCTURE	700.00	700.40		10" / 702 69			'	200
		CLEAN PIPE FROM DS 3-1 TO DS 3-2  ALTER FRAME AND GRATE ELEVATION			12" / 704.78	12" / 703.68				29
DS 3-2	ML 509+82.11	AND CLEAN STRUCTURE	708.53	708.16	W. / 12" / 703.68	E. / 12" / 703.67			1	
DP 3-2		CLEAN PIPE FROM DS 3-2 TO DS 3-3			12" / 703.67	12" / 699.07				29
DS 3-3	ML 512+80.47	ALTER FRAME AND GRATE ELEVATION AND CLEAN STRUCTURE	704.46	704.09	W. / 12" / 699.07	N. / 18" / 699.06			1	
DP 3-3		CLEAN PIPE FROM DS 3-3 TO OUTLET			18" / 699.06	18" / 698.00				12
DS 4-1	ML 514+91.12	CLEAN STRUCTURE	700.79	700.79	S. / 18" / 700.74				1	
DP 4-1		CLEAN PIPE FROM DS 4-1 TO DS 4-3			18" / 700.74	18" / 695.63				5
DS 4-2	ML 514+78.72	CLEAN STRUCTURE	700.91	700.91	N. / 18" / 700.85				1	
DP 4-2		CLEAN PIPE FROM DS 4-2 TO DS 4-3			18" / 700.85	18" / 695.65				50
DS 4-3	ML 515+03.12	CLEAN STRUCTURE	699.58	699.58	N. / 18" / 695.63	S. / 18" / 695.65	E. / 12" / 695.57		1	
DP 4-3		CLEAN PIPE FROM DS 4-3 TO DS 4-4			12" / 695.57	12" / 689.76				27
DS 4-4	ML 517+80.00	CLEAN STRUCTURE	694.38	694.38	W. / 12" / 689.76	N. / 18" / 682.90			1	
DP 4-4		CLEAN PIPE FROM DS 4-4 TO OUTLET			18" / 682.90	18" / 682.33				78
DS 5-1	ML 521+77.17	CLEAN STRUCTURE	691.43	691.43	N. / 18" / 684.49	10 7 302.00			1	,
	IVIL 521+11.11		091.43	091.43		4011 / 600 00			1	
DP 5-1		CLEAN PIPE FROM DS 5-1 TO OUTLET			18" / 684.49	18" / 683.92				10
DS 6-1	ML 526+29.76	CLEAN STRUCTURE	690.13	690.13	N. / 18" / 685.32				1	
DP 6-1		CLEAN PIPE FROM DS 6-1 TO OUTLET	SHEET 1 TOTA		18" / 685.32	18" / 679.35				10

IT IS A VIOLATION OF LAW FOR ANY PERSON, UNLESS THEY ARE ACTING
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AND INCLUDE THE NOTATION "ALTERED BY" FOLLOWED BY THEIR SIGNATURE,
THE DATE OF SUCH ALTERATION, AND A SPECIFIC DESCRIPTION OF THE
ALTERATION.

	DATE	DESCRIPTION	BY	SYM.									
Γ Ε,													

Thruway	TITLE OF PROJECT 1R MILL AND INLAY, SAFETY IMPROVEMENTS, AND MISC. WORK	CONTRACT NUMI	
Authority	LOCATION OF PROJECT MP 416.90 TO MP 419.40	DATE:	
	TITLE OF DRAWING	08/20/20	
	DRAINAGE TABLE	DRAWING NUMB	
		DDT	

DS#	STATION	DESC	RIPTION OF WORK	EXIST T.G. ELEV.	PROP T.G. ELEV.	SIDE / SIZE / INVERT ELEV.	621.04				
DS 7-1	ML 530+40.49		E AND GRATE ELEVATION	690.39	690.02	E. / 18" / 684.83				<b>(EA)</b>	Т
DP 7-1			E FROM DS 7-1 TO DS 7-2			18" / 684.83	18" / 684.63				
DS 7-2	ML 531+73.01		EAN STRUCTURE	689.17	689.17		S. / 18" / 684.61			1	
	WL 551+75.01			009.17	009.17					'	
DP 7-2			FROM DS 7-2 TO OUTLET			18" / 684.61	18" / 681.79				
DS 8-1	ML 534+74.40		EAN STRUCTURE	689.68	689.68	S. / 36" /683.29	N. / 36" / 683.64			1	
DP 8-1		CLEAN PIPE	FROM DS 8-1 TO OUTLET			36" / 683.64	36" / 683.92				
DP 8-2		CLEAN PIPE	FROM DS 8-1 TO OUTLET			36" / 683.29	36" / 682.69				
DS 9-1	ML 539+73.49	CLI	EAN STRUCTURE	691.37	691.37	S. / 18" / 686.62				1	
DP 9-1		CLEAN PIPE	FROM DS 9-1 TO OUTLET			18" / 686.62	18" / 684.91				
DS 10-1	ML 543+75.43	CLI	EAN STRUCTURE	693.00	693.00	S. / 18" / 688.81				1	
DP 10-1		CLEAN PIPE	FROM DS 10-1 TO OUTLET			18" / 688.81	18" / 687.67				
DS 11-1	ML 548+05.32	CLI	EAN STRUCTURE	694.57	694.57	S. / 18" / 691.08				1	
DP 11-1		CLEAN PIPE	FROM DS 11-1 TO OUTLET			18" / 691.08	18" / 690.50				
DS 12-1	ML 551+75.36	CLI	EAN STRUCTURE	695.75	695.75	S. / 18" / 692.78				1	
DP 12-1		CLEAN PIPE	FROM DS 12-1 TO OUTLET			18" / 692.78	18" / 691.52				
DS 13-1	ML 555+73.57	CLI	EAN STRUCTURE	696.91	696.91	S. / 18" / 693.27				1	T
DP 13-1		CLEAN PIPE	FROM DS 13-1 TO OUTLET			18" / 693.27	18" / 692.85				
DS 14-1	ML 562+74.49	CLI	EAN STRUCTURE	697.25	697.25	S. / 18" / 693.38				1	
DP 14-1		CLEAN PIPE	FROM DS 14-1 TO OUTLET			18" / 693.38	18" / 692.44				H
DS 15-1	ML 566+73.80	CLI	EAN STRUCTURE	696.03	696.03	S. / 18" / 692.37				1	
DP 15-1		CLEAN PIPE	FROM DS 15-1 TO OUTLET			18" / 692.37	18" / 690.98				
DS 16-1	ML 570+74.84	-	EAN STRUCTURE	694.84	694.84	S. / 18" / 690.31				1	
DP 16-1	WE 070*74.04		FROM DS 16-1 TO OUTLET	004.04	004.04	18" / 690.31	18" / 689.29			·	
	MI 574 74 00			CO2 CO	CO2 CO					4	
DS 17-1	ML 574+74.08		EAN STRUCTURE	693.68	693.68	N. / 18" / 688.29				1	
DP 17-1			FROM DS 17-1 TO OUTLET			24" / 688.29	24" / 687.76				
DP 17-2		CLEAN PIPE	FROM DS 17-1 TO OUTLET			18" / 688.29	18" / 688.98				
DS 18-1	ML 578+74.34	CLI	EAN STRUCTURE	694.79	694.79	S. / 24" / 690.45				1	
DP 18-1		CLEAN PIPE	FROM DS 18-1 TO OUTLET			24" / 690.45	24" / 689.71				
DS 19-1	ML 582+37.13	CLI	EAN STRUCTURE	695.95	695.95	N. / 36" / 689.94	S. / 36" / 689.94			1	
DP 19-1		CLEAN PIPE	FROM DS 19-1 TO OUTLET			36" / 689.94	36" / 690.67				
DP 19-2		CLEAN PIPE	FROM DS 19-1 TO OUTLET			36" / 689.94	36" / 689.43				
				SHEET 2 TOTA	ALS					14	<u> </u>

DRAINAGE TABLE -- SHEET 2 OF 3

08/21/2025

		REVISIONS								
	DATE	DESCRIPTION	BY	SYM.						
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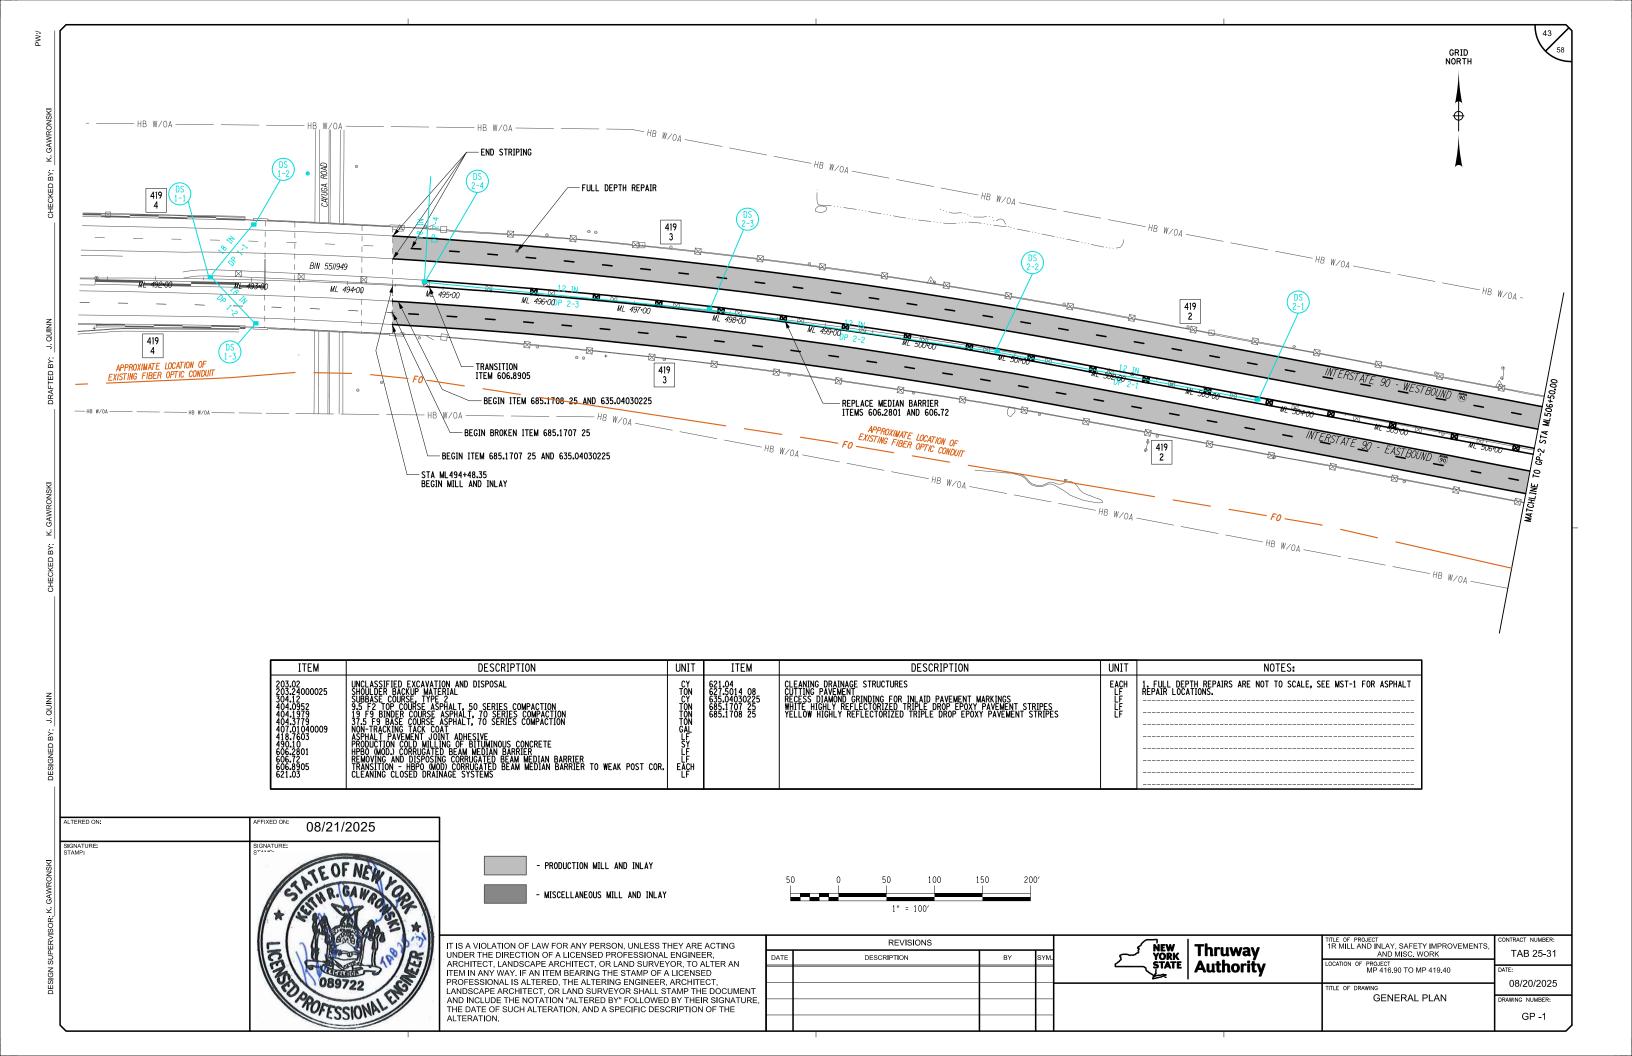
Thruway	TITLE OF PROJECT 1R MILL AND INLAY, SAFETY IMPROVEMENTS, AND MISC. WORK	CONTRACT NUMBER: TAB 25-31	
Authority	LOCATION OF PROJECT MP 416,90 TO MP 419,40	DATE: 08/20/2025	
	DRAINAGE TABLE	DRAWING NUMBER:	
		DRT-2	


	DRAINAGE TABLE SHEET 3 OF 3										
DS#	STATION	DESCRIPTION OF WORK	EXIST T.G. ELEV.	PROP T.G. ELEV.	SIDE / SIZE / INVERT ELEV.	621.04	621.03				
DS 20-1	ML 598+73.71	CLEAN STRUCTURE	695.08	695.08	S. / 18" / 691.27				<b>(EA)</b>	(LF)	
DP 20-1	-	CLEAN PIPE FROM DS 20-1 TO OUTLET			18" / 691.27	18" / 690.64				86	
DS 21-1	ML 594+73.80	CLEAN STRUCTURE	696.33	696.33	N. / 24" / 693.28	S. / 24" / 693.12			1		
DP 21-1		CLEAN PIPE FROM DS 21-1 TO OUTLET	,		24" / 693.28	24" / 684.04				74	
DP 21-2		CLEAN PIPE FROM DS 21-1 TO OUTLET			24" / 693.12	24" / 690.75				83	
DS 21-2	ML 595+43.91	CLEAN STRUCTURE							1		
DS 22-1	ML 598+72.51	CLEAN STRUCTURE	695.05	695.05	S. / 24" / 692.58				1		
DP 22-1		CLEAN PIPE FROM DS 22-1 TO OUTLET			24" / 692.58	24" / 694.48				61	
DP 22-2		CLEAN PIPE FROM INTLET TO OUTLET			24" / 692.09	24" / 691.68				90	
DS 23-1	ML 602+72.31	CLEAN STRUCTURE	696.37	696.37	N. / 24" / 693.09				1		
DP 23-1		CLEAN PIPE FROM DS 23-1 TO OUTLET			24" / 693.45	24" / 693.09				93	
DP 23-2		CLEAN PIPE FROM DS 23-1 TO OUTLET			24" / 693.09	24" / 692.94				72	
DS 24-1	ML 604+97.78	CLEAN STRUCTURE	696.92	696.92	S. / 18" / 694.60				1		
DP 24-1		CLEAN PIPE FROM DS 24-1 TO OUTLET			18" / 694.60	18" / 694.11				90	
DS 25-1	ML 608+58.19	CLEAN STRUCTURE	698.08	698.08	N. / 36" / 693.93	S. / 36" / 693.93			1		
DP 25-1		CLEAN PIPE FROM DS 25-1 TO OUTLET			36" / 694.01	36" / 693.93				83	
DP 25-2		CLEAN PIPE FROM DS 25-1 TO OUTLET			36" / 693.93	36" / 693.79				82	
DP 25-3		CLEAN PIPE FROM INLET TO OUTLET			36" / 694.00	36" / 693.75				167	
DS 26-1	ML 614+24.31	CLEAN STRUCTURE	708.50	708.50	S. / 18" /698.84				1		
DP 26-1		CLEAN PIPE FROM DS 26-1 TO OUTLET			18" / 698.84	18" / 6697.81				91	
DS 27-1	ML 620+92.78	CLEAN STRUCTURE	718.59	718.59	S. / 12" / 714.00				1		
DP27-1		CLEAN PIPE FROM DS 27-1 TO DS 27-2			12" / 714.00	12" / 713.14				52	
DS 27-2	ML 620+76.50	CLEAN STRUCTURE	717.81	717.81	N. / 12" / 713.14	S. / 12" / 713.15			1		
DP 27-2		CLEAN PIPE FROM DS 27-2 TO DS 27-3			12" / 713.15	12" / 712.59				68	
DS 27-3	ML 621+08.62	CLEAN STRUCTURE	718.36	718.36	N. / 12" / 712.59	S. / 12" / 712.31			1		
DP 27-3		CLEAN PIPE FROM DS 27-3 TO OUTLET			12" / 712.31	12" / 700.91				41	
SHEET 3 TOTALS										1233	
			SHEET 2 TOTA	ALS					14	1467	
			SHEET 1 TOTA						16	2478	
			TOTALS						41	5178	
DEVISIONS											


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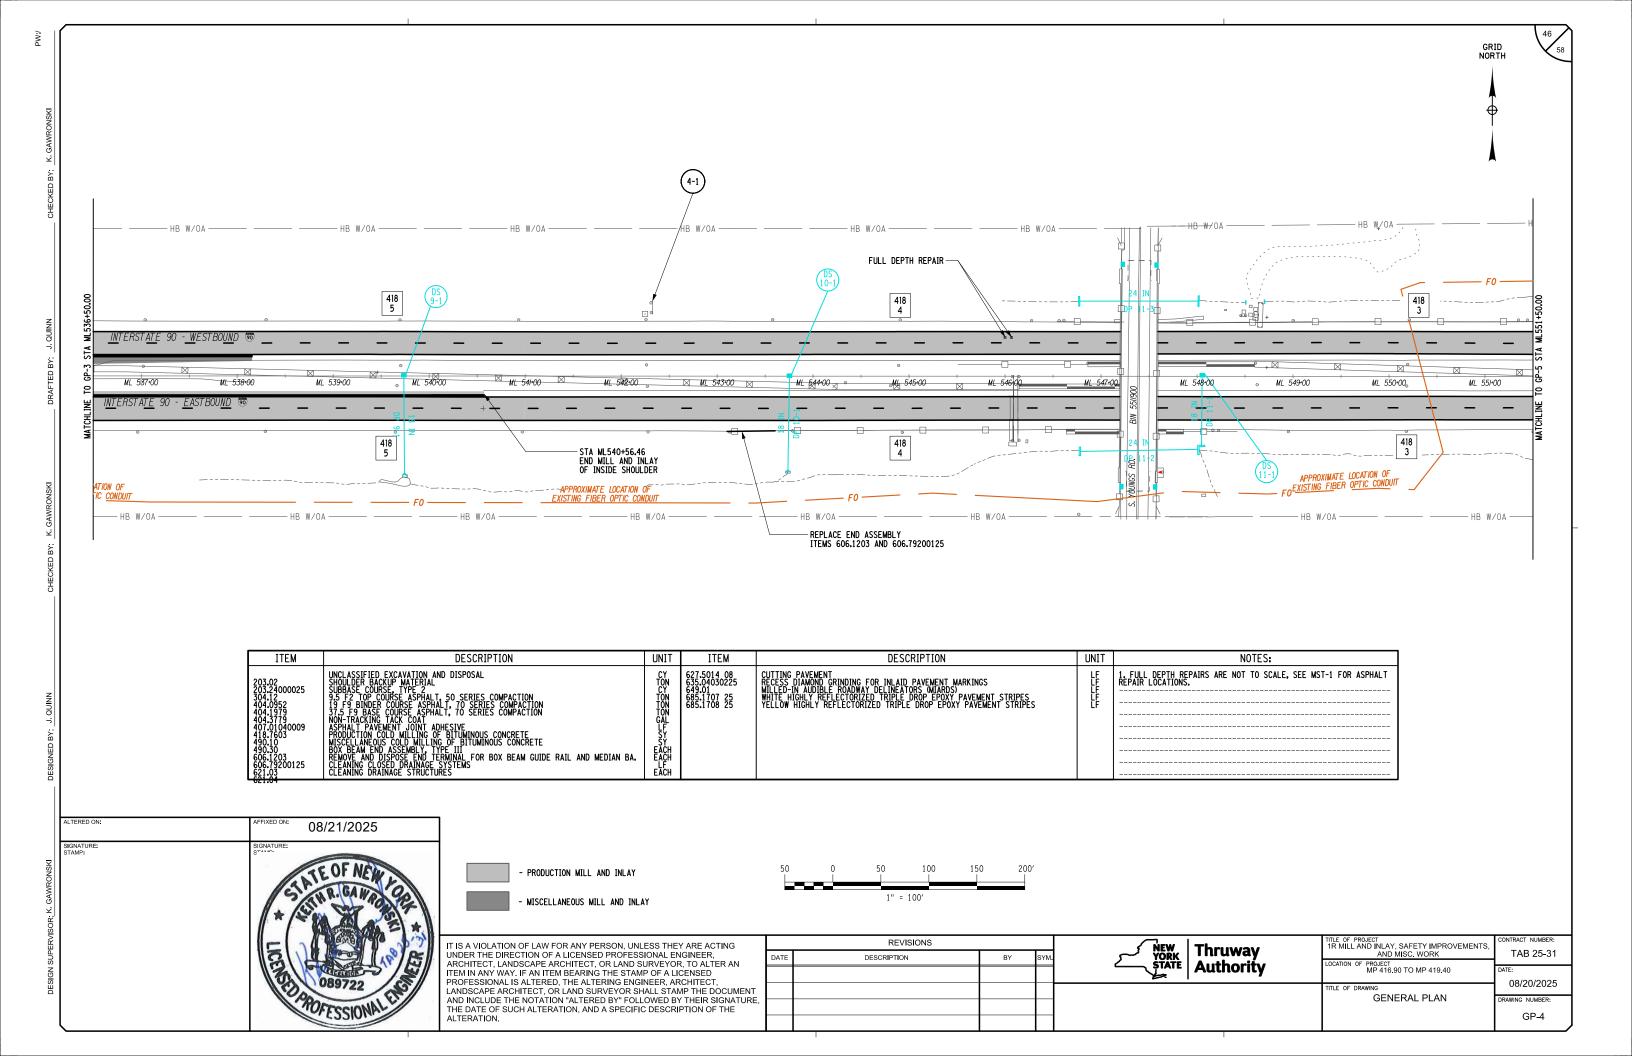
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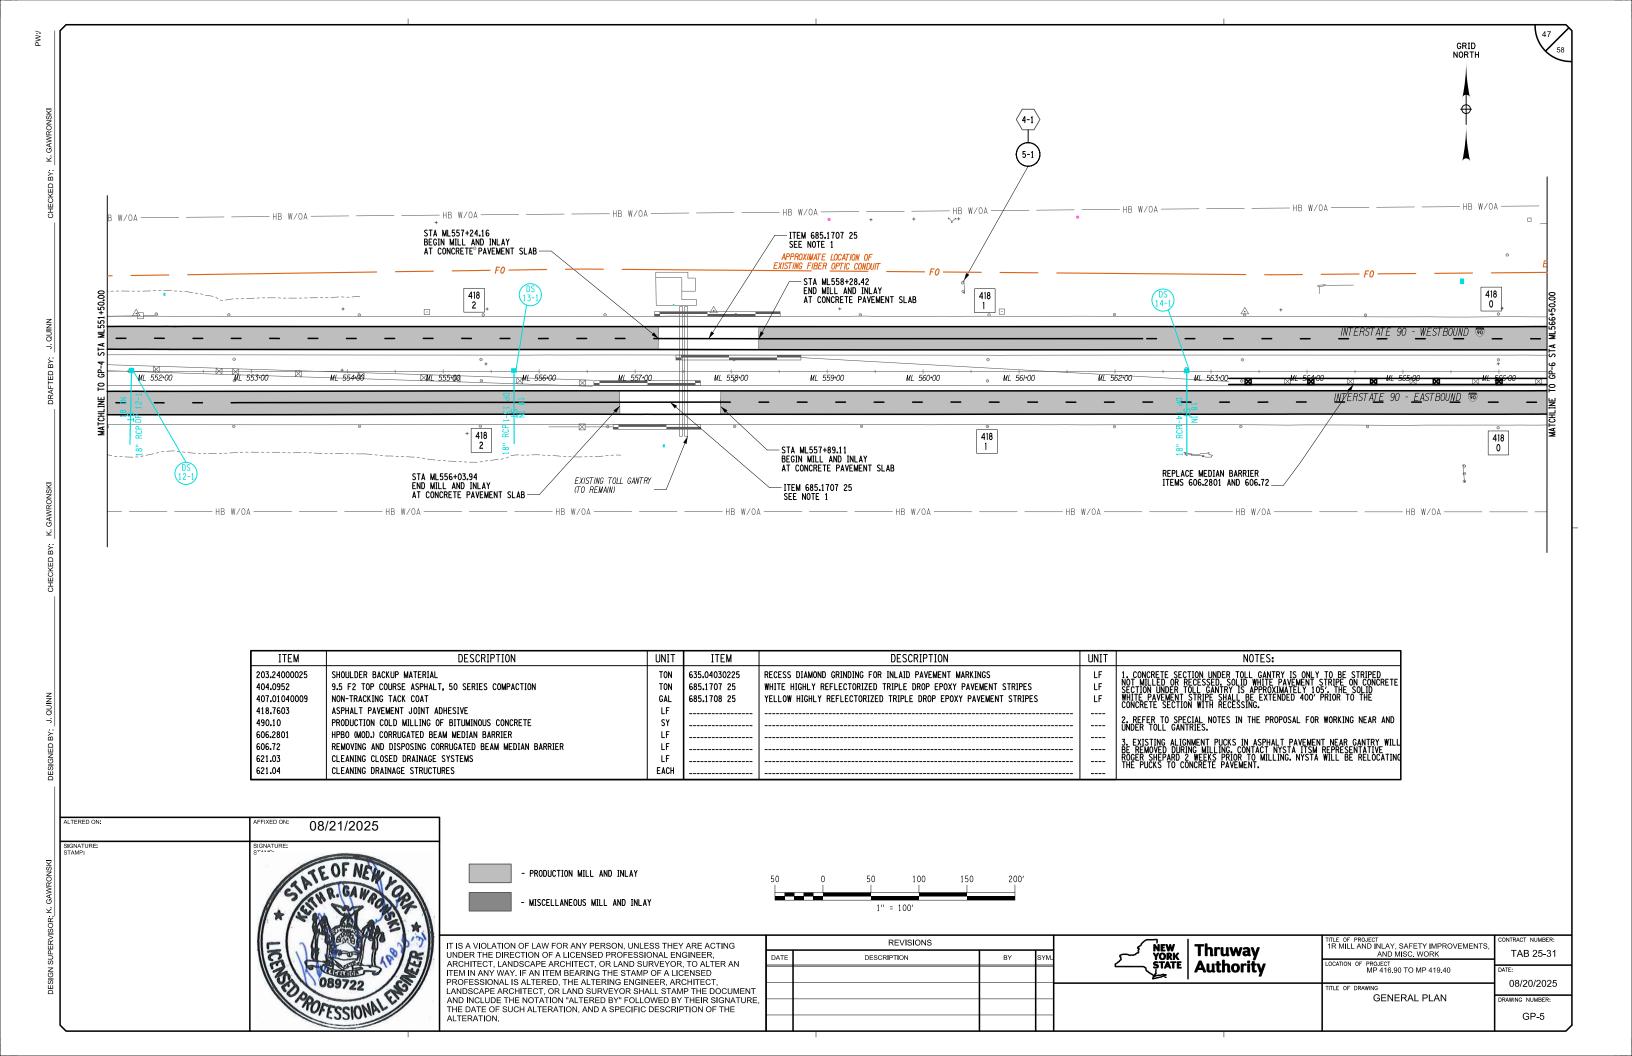
NEW YORK	Thruway	TITLE OF PROJECT 1R MILL AND INLAY, SAFETY IMPROVEMENTS, AND MISC. WORK	TAB 25-3
YORK STATE	Authority	LOCATION OF PROJECT MP 416.90 TO MP 419.40	DATE: 08/20/202
		TITLE OF DRAWING  DRAINAGE TABLE	DRAWING NUMBER:
			DDT 3










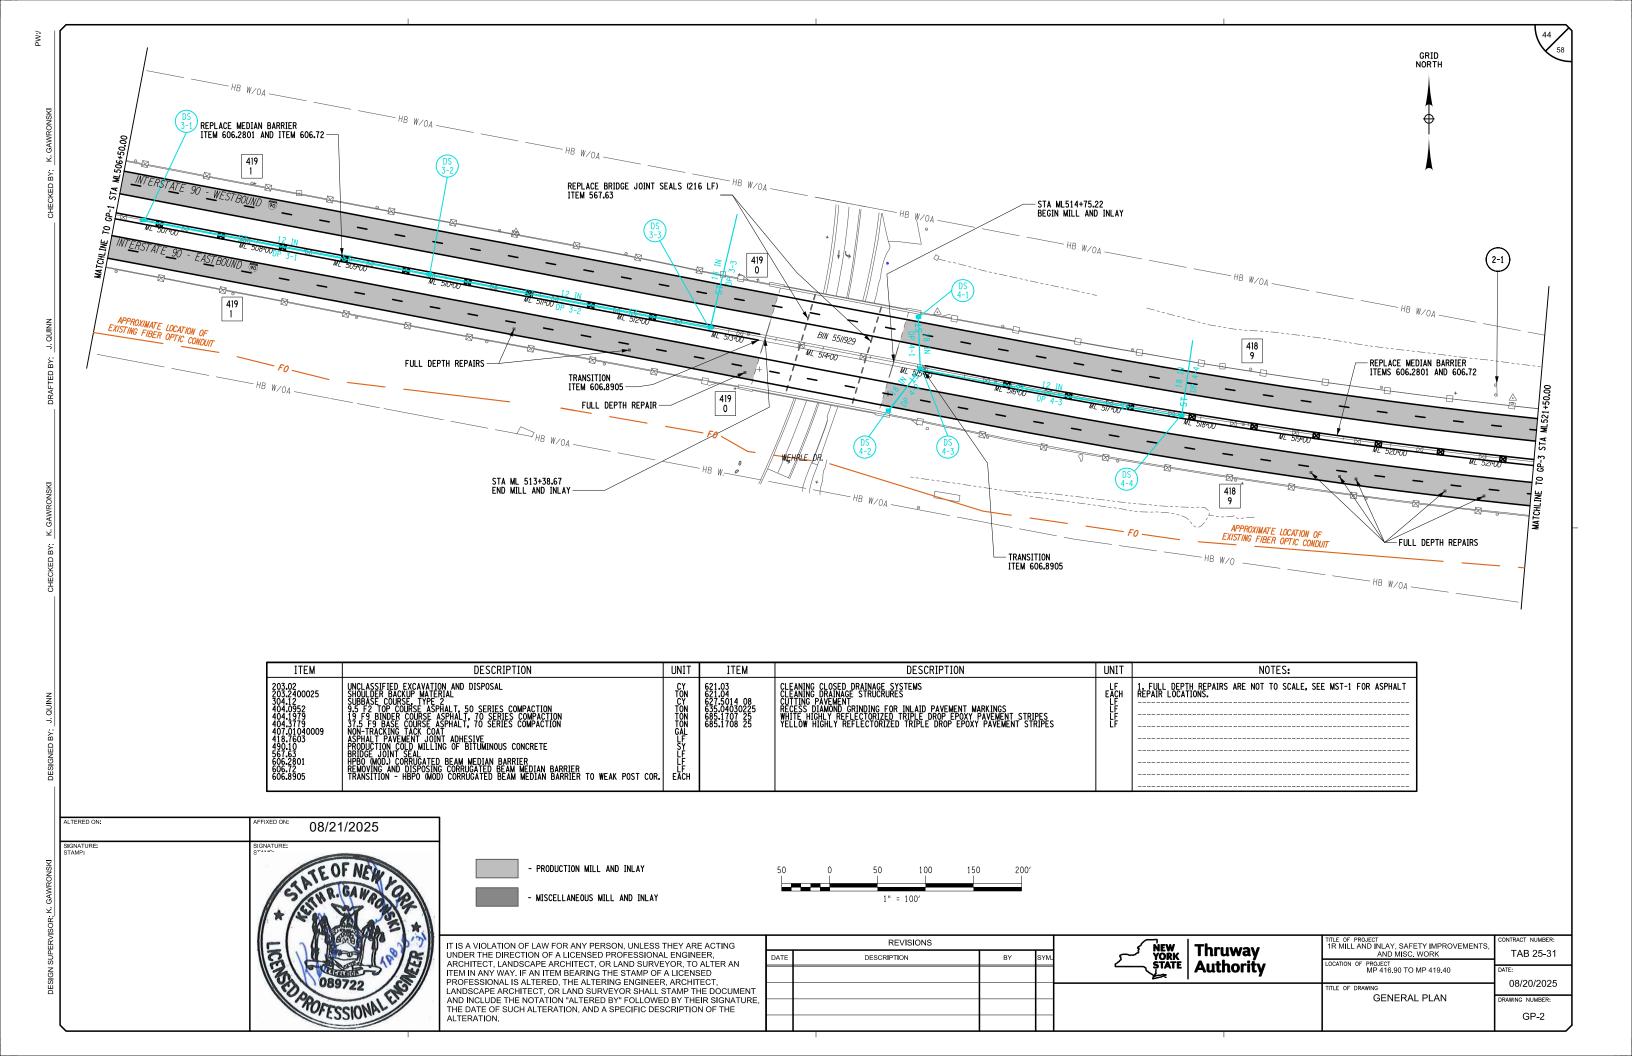


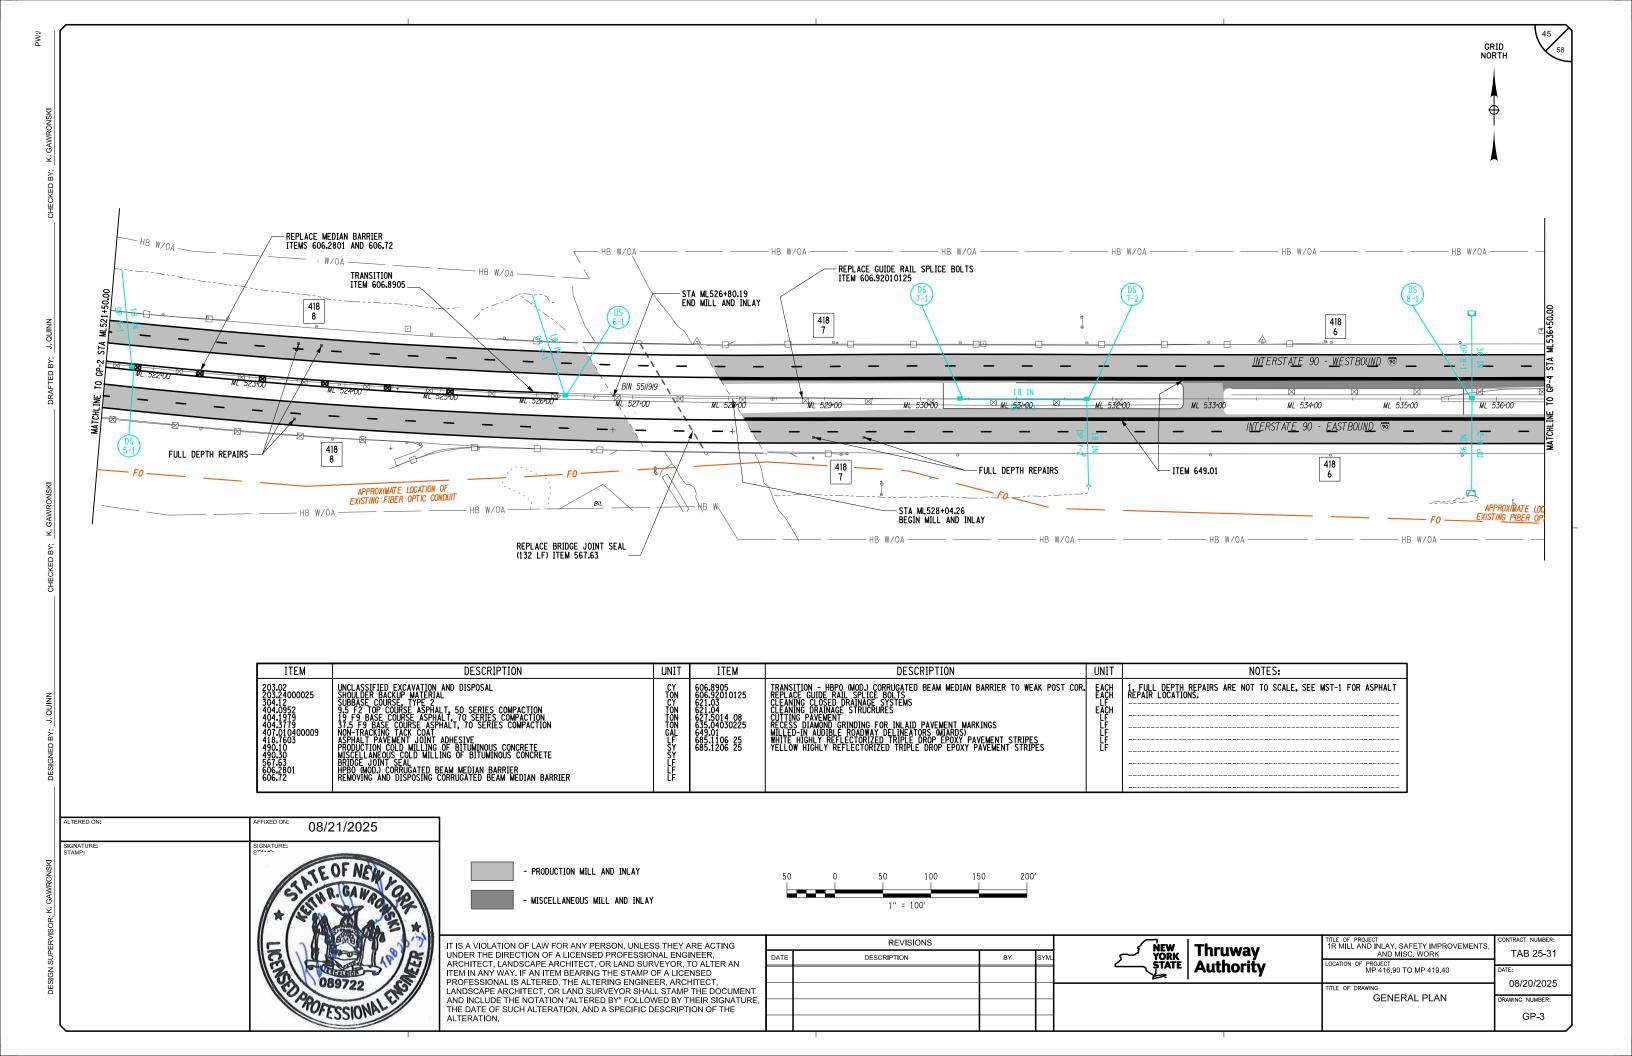


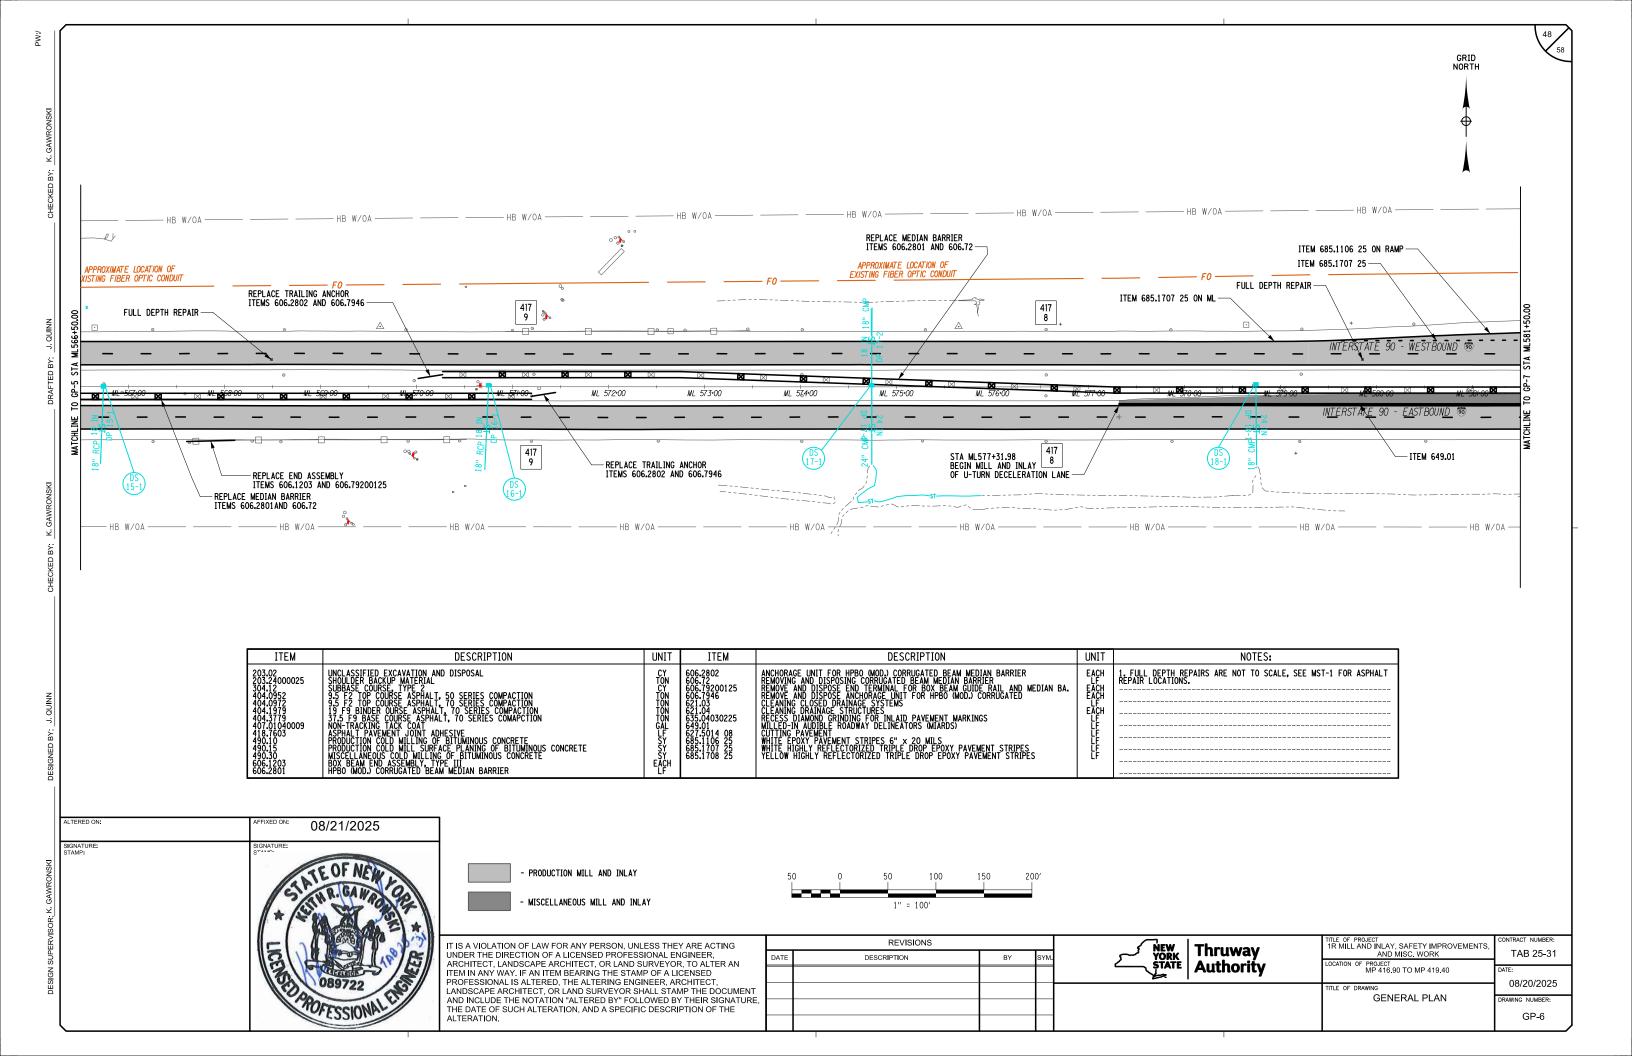


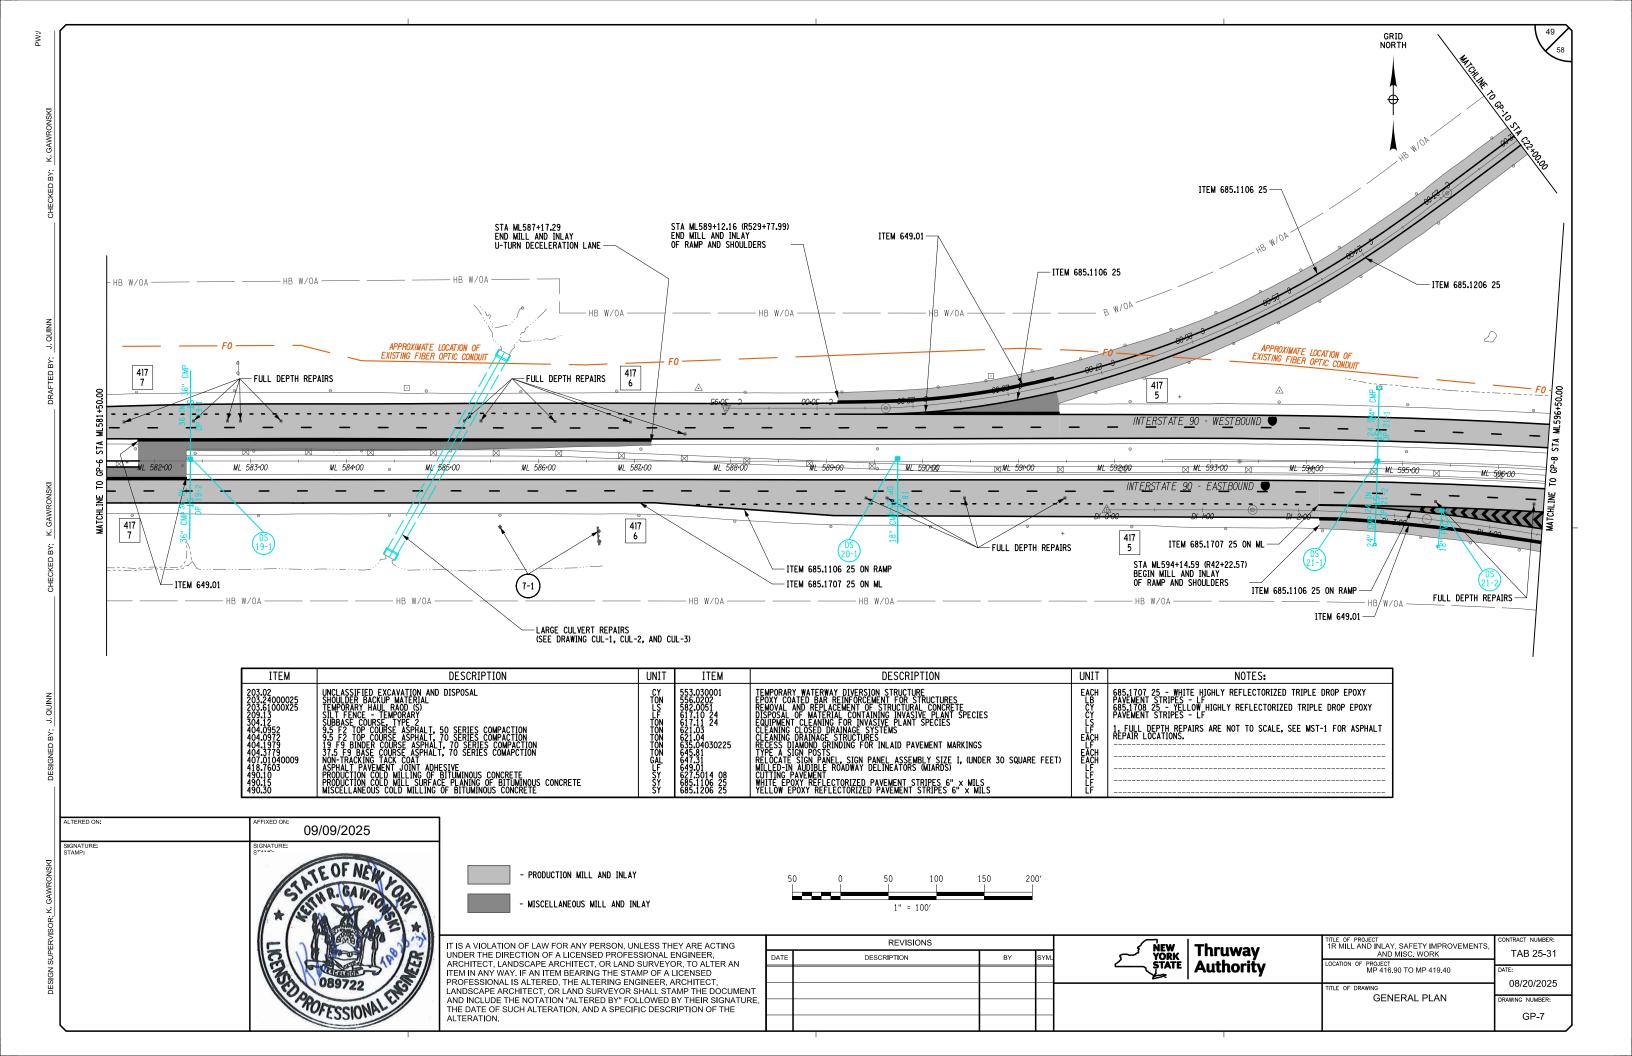

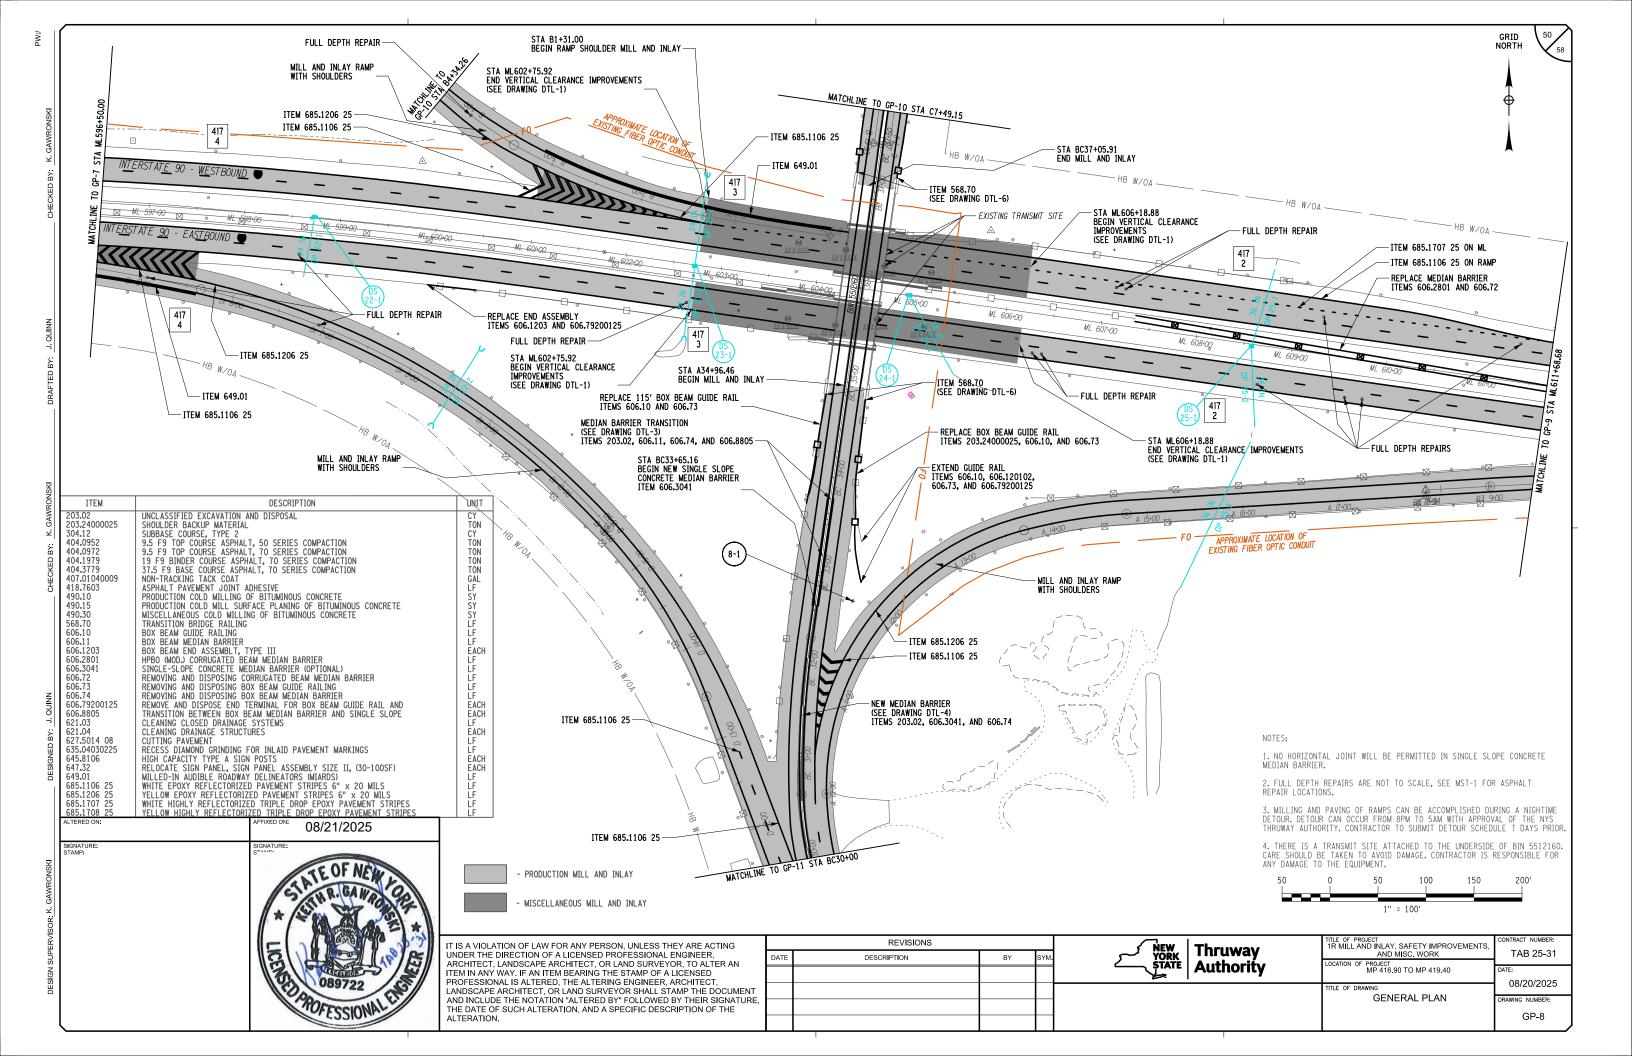

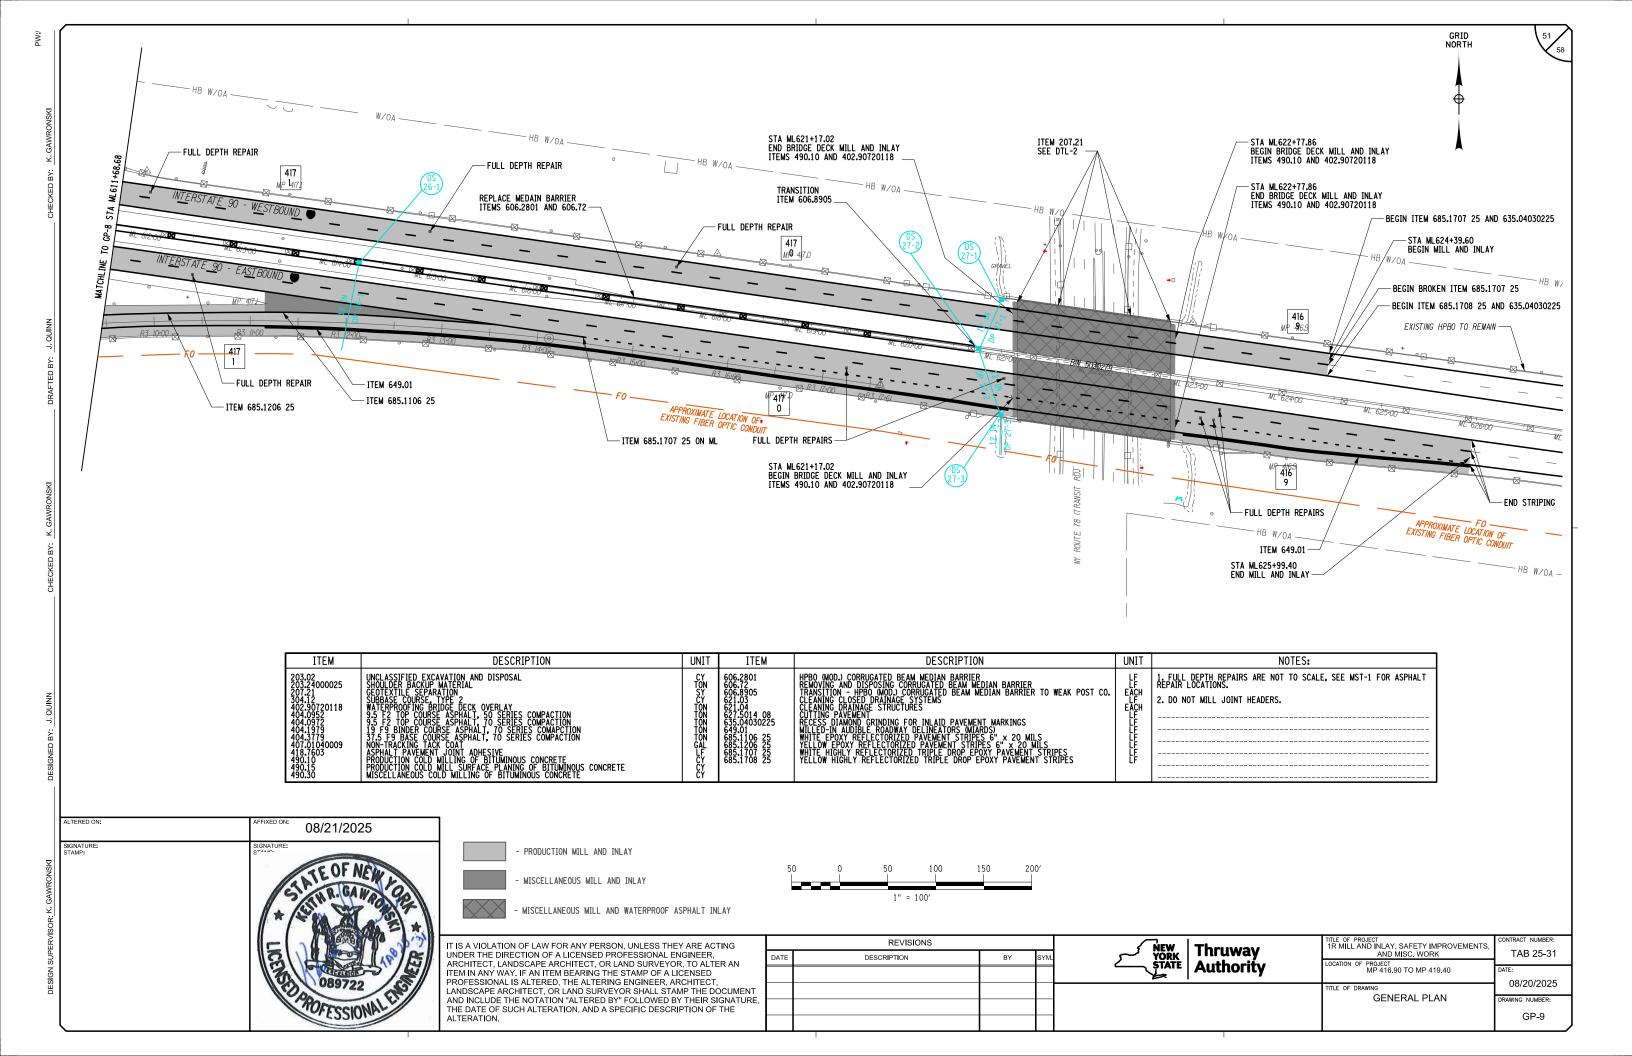

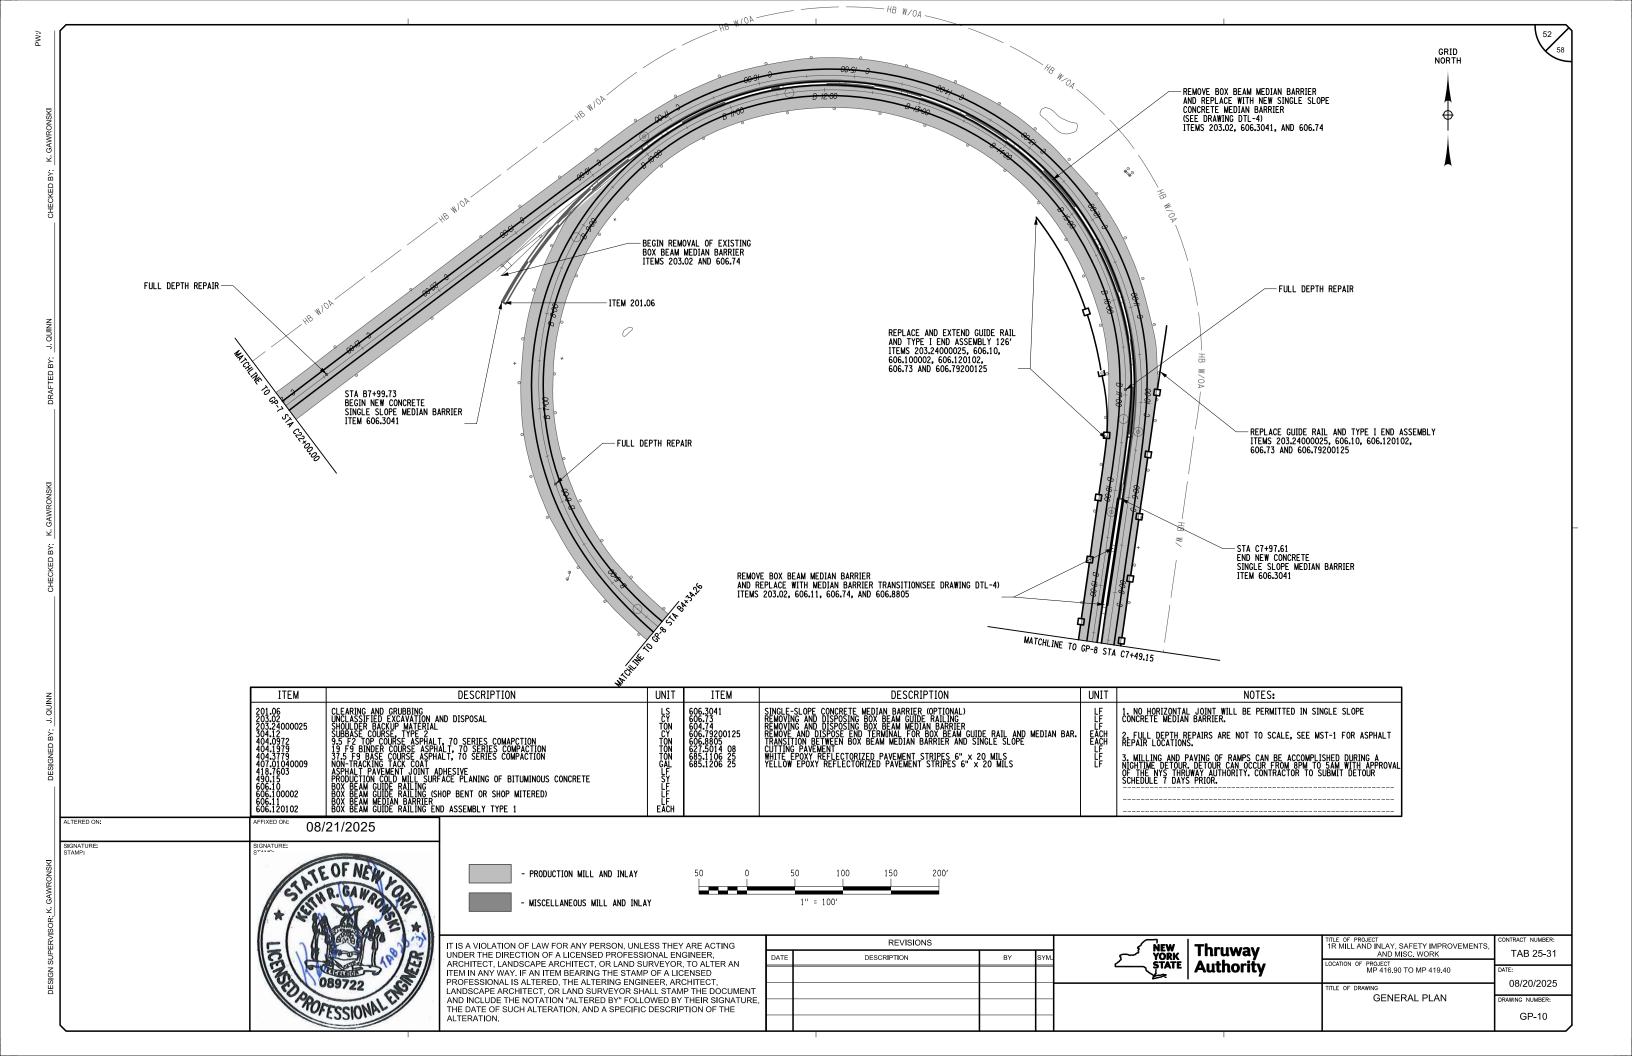

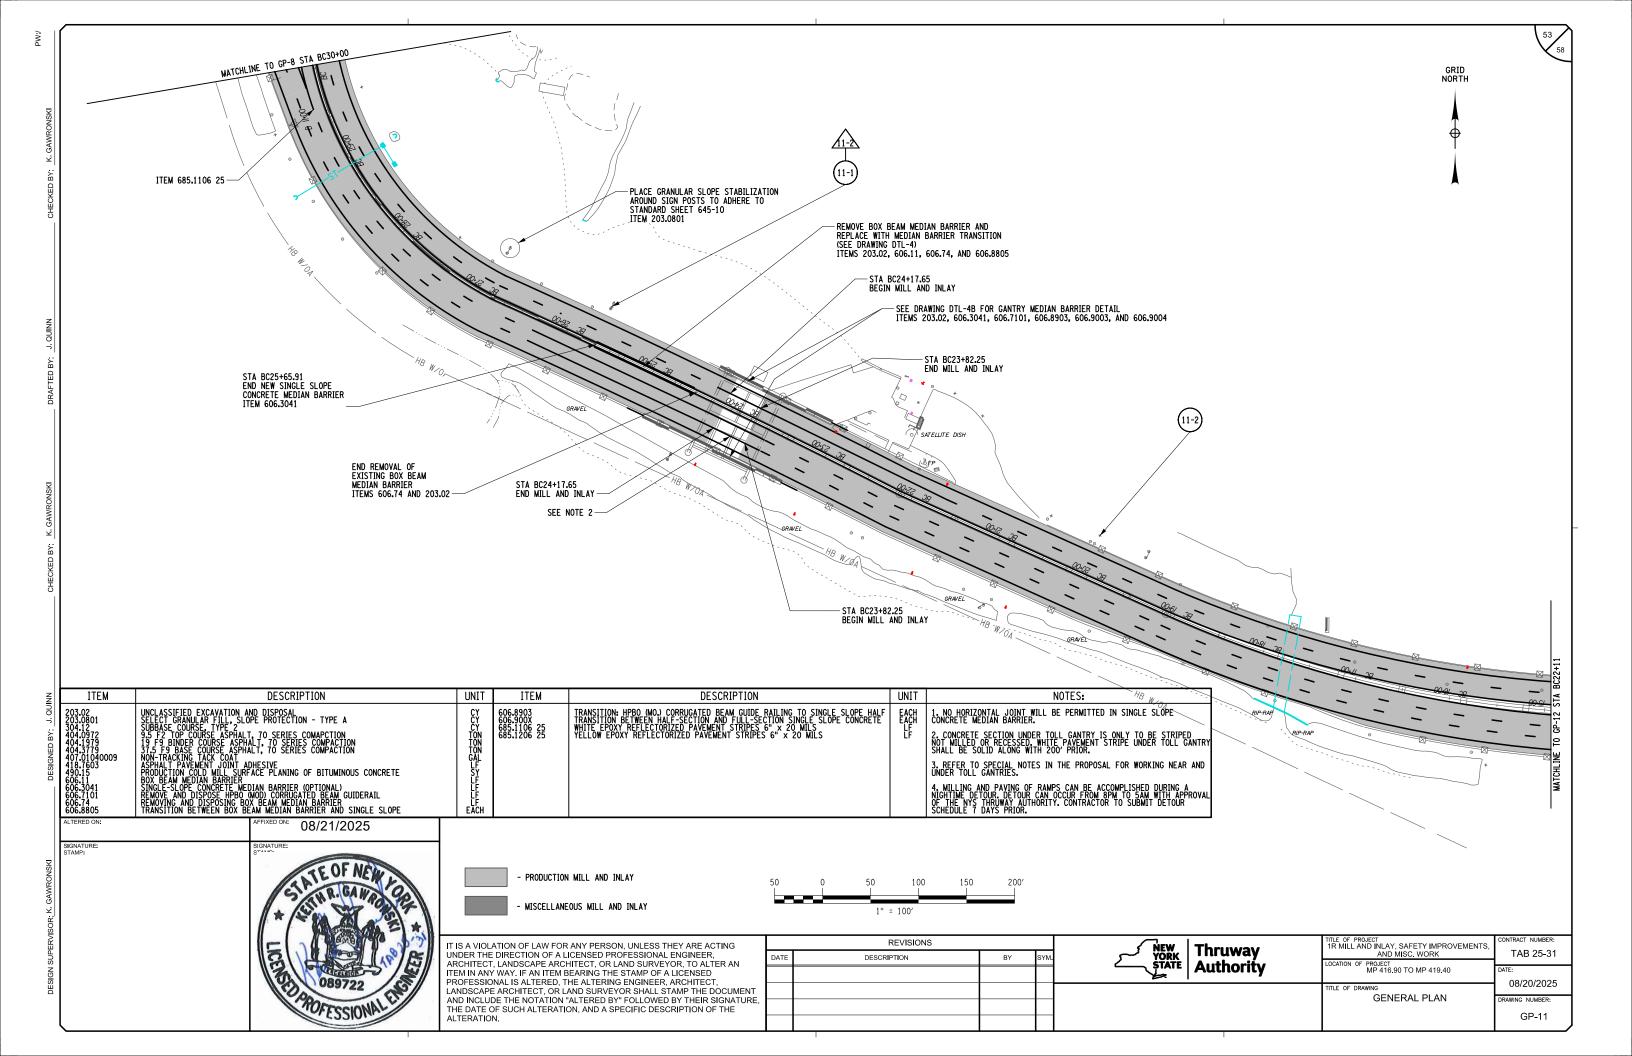



ALTERED ON:

08/21/2025



- PRODUCTION MILL AND INLAY

- MISCELLANEOUS MILL AND INLAY

50	0	50	100	150	200
		1" =	100′		

STA BC22+11	PAVERS PAVERS & &	
MATCHLINE TO GP-11	38 00-11 38	— STA BC10+38.47 END MILL AND INLAY
	ITEM 685.1406 25	

STA BC10+52.43 END MILL AND INLAY


ITEM	DESCRIPTION	UNIT	ITEM	DESCRIPTION	UNIT	NOTES:
404.0972	9.5 F2 TOP COURSE ASPHALT, 70 SERIES COMPACTION	TON				1. MILLING AND PAVING OF RAMPS CAN BE ACCOMPLISHED DURING A
407.01040009	NON-TRACKING TACK COAT	GAL				NIGHTIME DETOUR, DETOUR CAN OCCUR FROM 8PM TO 5AM WITH APPROVAL OF THE NYS THRUWAY AUTHORITY, CONTRACTOR TO SUBMIT DETOUR
418.7603	ASPHALT PAVEMENT JOINT ADHESIVE	LF				SCHEDULE 7 DAYS PRIOR
490.15	PRODUCTION COLD MILL SURFACE PLANING OF BITUMINOUS CONCRETE	SY				
685.1106 25	WHITE EPOXY REFLECTORIZED PAVEMENT STRIPES 6" x 20 MILS	LF				
685.1206 25	YELLOW EPOXY REFLECTORIZED PAVEMENT STRIPES 6" x 20 MILS	LF				
685.1306 25	WHITE EPOXY REFLECTORIZED PAVEMENT LETTERS	EACH				
685.1406 25	WHITE EPOXY REFLECTORIZED PAVEMENT SYMBOLS	EACH				


50	0	50	100	150	200′
		1" =	100′		


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THE DATE OF SUCH ALTERATION, AND A SPECIFIC DESCRIPTION OF THE	L
ALTERATION.	ı

	REVISIONS			NFW Therenes	TITLE OF PROJECT 1R MILL AND INLAY, SAFETY IMPROVEMENTS,	CONTRACT NUMBER:
Έ	DESCRIPTION	BY	SYM.	NEW YORK Thruway STATE Authority	AND MISC. WORK	TAB 25-31
T				<b>STATE</b> Authority	MP 416.90 TO MP 419.40	DATE:
П					TITLE OF DRAWING	08/20/2025
7					GENERAL PLAN	DRAWING NUMBER:
+						GP-12

GRID NORTH

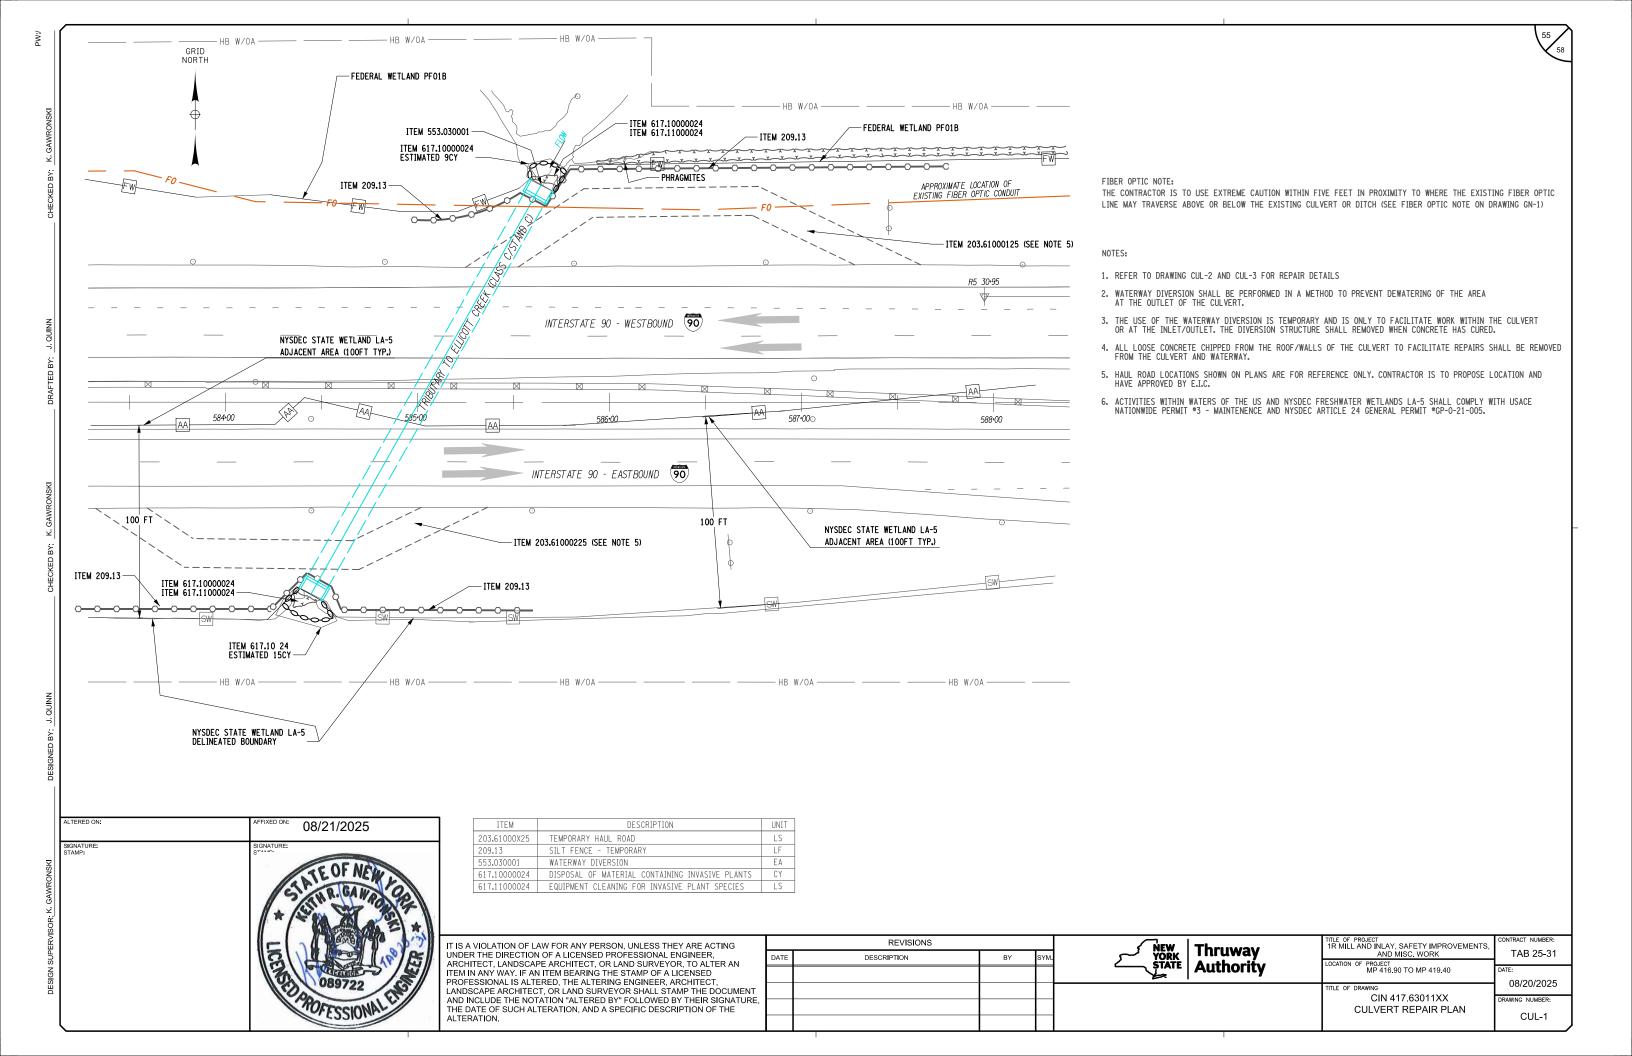

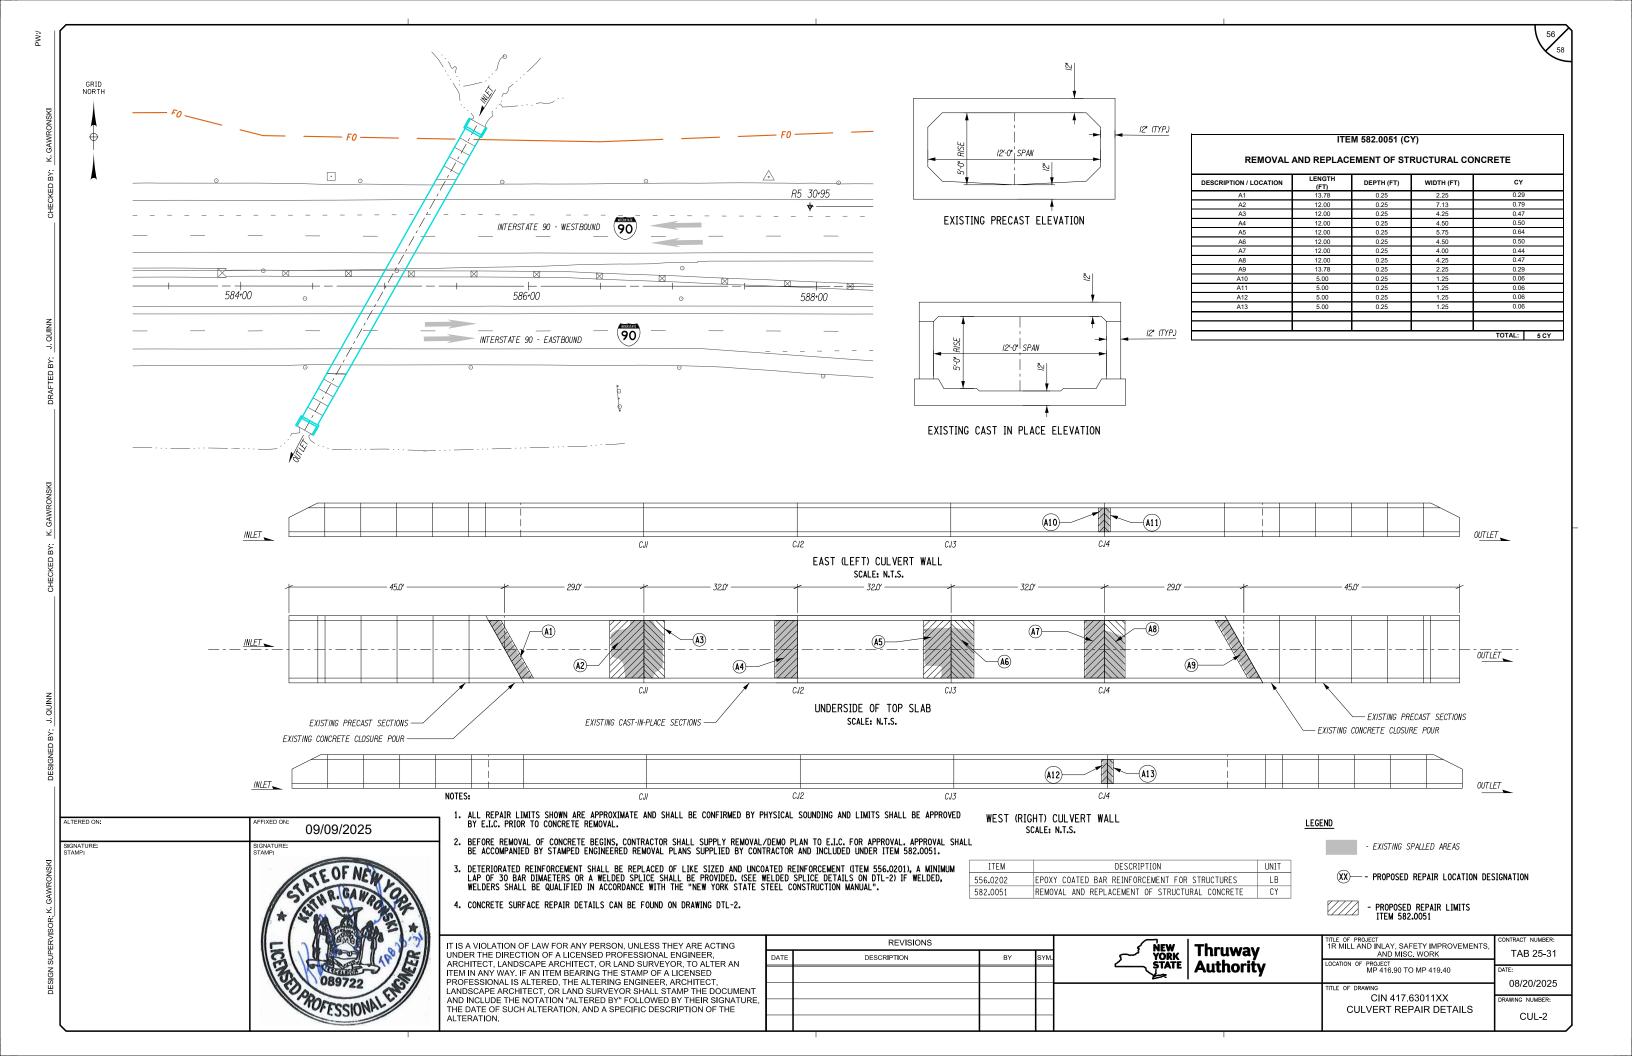

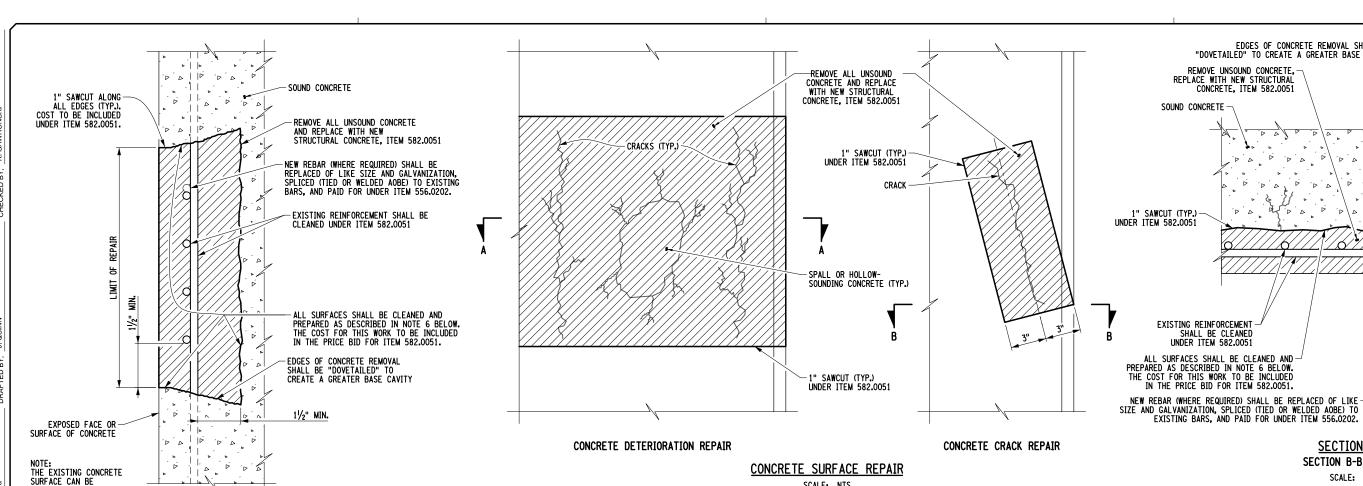

TYPICAL CONCRETE SURFACE REPAIR SECTION


SCALE: NTS

ITEM	DESCRIPTION	UNIT
556.0202 559.02 582.0051	EPOXY COATED BAR REINFORCEMENT FOR STRUCTURES PROTECTIVE SEALING OF STRUCTURAL CONCRETE REMOVAL AND REPLACMENT OF STRUCTURAL CONCRETE	LB SF CY

## CONCRETE REPAIR NOTES:


PLANAR OR CURVED

- 1. FOR GENERAL NOTES, SEE DRAWING ST-1.
- 2. FOR LOCATION OF CONCRETE REPAIRS, SEE DRAWINGS CUL-1 THROUGH CUL-2.
- 3. SUBSTRUCTURE DETERIORATION REQUIRING REPAIR AS INDICATED ON THE PLANS HAS BEEN DETERMINED BY A FIELD INSPECTION. ALL OF THE MAJOR AREAS KNOWN TO EXIST AT THE TIME HAVE BEEN SHOWN TO INDICATE THE APPROXIMATE EXTENT OF DETERIORATION THAT WILL HAVE TO
- 4. THE ANTICIPATED EXTENT OF CONCRETE REPAIR HAS BEEN INDICATED ON THE CONTRACT PLANS. THE PROJECT ENGINEER SHALL EXAMINE THE SUBSTRUCTURE CONCRETE AND ESTABLISH THOSE AREAS OF REPAIR TO BE MADE SHALL BE APPROVED BY THE PROJECT ENGINEER.
- 5. DETERIORATED REINFORCEMENT SHALL BE REPLACED OF LIKE SIZE AND COATING (ITEM 556,0202), AND A MINIMUM LAP OF 30 BAR DIAMETERS OR A WELDED SPLICE SHALL BE PROVIDED. (SEE WELDED SPLICE DETAILS ON THIS DRAWING.) IF WELDED, WELDERS SHALL BE QUALIFIED IN ACCORDANCE WITH THE "NEW YORK STATE STEEL CONSTRUCTION MANUAL."
- 6. WHEN JOINING FRESH CONCRETE TO NEW CONCRETE WHICH HAS ALREADY BEEN SET, OR TO EXISTING CONCRETE, THE CONCRETE IN PLACE SHALL HAVE ITS SURFACE SCOURED OR ABRADED WITH A SUITABLE TOOL TO REMOVE ALL LOOSE AND FOREIGN MATERIALS. THIS SURFACE SHALL BE SCRUBBED WITH WIRE BROOMS. AFTER THE SURFACE PREPARATION HAS BEEN ACCEPTED, THIS SURFACE SHALL BE THOROUGHLY WET AND KEPT SO FOR A PERIOD OF 12 HOURS IMMEDIATELY PRIOR TO PLACING THE NEW CONCRETE. THIS MAY BE ACCOMPLISHED BY CONTINUOUS WETTING WITH SOAKER HOSES OR THE USE OF BURLAP/BURLENE/ETC. SO THAT MOISTURE CAN BE MAINTAINED. IF, IN THE OPINION OF THE ENGINEER, CONDITIONS OR THE SITUATION PROHIBITS THIS, THEN THE SURFACE SHALL BE WETTED FOR AS LONG AS POSSIBLE. THE CONTRACTOR SHALL REMOVE ANY PUDDLES OR FREE-STANDING WATER WITH OIL—FREE COMPRESSED AIR AND PROTECT THE SURFACE FROM MYRING SO THAT THE EXISTING CONCRETE REMAINS IN A CLEAN, SATURATED, SURFACE-DRY CONDITION UNTIL PLACEMENT OF THE NEW CONCRETE. IMMEDIATELY BEFORE PLACING THE NEW CONCRETE, THE FORMS SHALL BE DRAWN TIGHT AGAINST THE CONCRETE ALREADY IN PLACE.
- 7. AT ALL CONCRETE REMOVAL LOCATIONS, THE MINIMUM DEPTH OF REMOVAL SHALL BE NO LESS THAN 11/2" BEHIND THE INNERMOST LAYER OF EXPOSED REINFORCING BARS, OR TO SOUND CONCRETE, WHICHEVER IS GREATER.
- WHERE CONCRETE REMOVAL AND REPLACEMENT NECESSITATES ADJACENT SEPARATE CONCRETE PLACEMENTS, CONCRETE REMOVAL SHALL NOT BE ALLOWED WITHIN 1 FOOT OF ADJACENT REPAIR AREAS. ADJACENT AREAS WHERE THIS 1 FOOT BUFFER IS NOT ATTAINABLE SHALL BE COMBINED
- 9. IN SEQUENCING WORK, THE CONTRACTOR SHALL NOT BEGIN CONCRETE REMOVAL AT A LOCATION ADJACENT TO A COMPLETED REPAIR AREA UNTIL A MINIMUM OF 7 CURING DAYS HAVE PASSED.
- 10. A PROTECTIVE OR PENETRATING SEALER FOR CONCRETE SHALL BE APPLIED TO ALL PROPOSED SUBSTRUCTURE CONCRETE SURFACE REPAIRS AND NO MORE THAN 2' BEYOND THE EXTENT OF THE REPAIRS (ITEM 559.02).
- 11. THE EXTENT OF CONCRETE REMOVAL FOR ANY COMPONENT SHALL NOT JEOPARDIZE ITS STRUCTURAL INTEGRITY. THE CONTRACTOR SHALL SUBMIT, PRIOR TO COMMENCEMENT OF THIS WORK, A REMOVAL PLAN AND SCHEDULE FOR PROJECT ENGINEER APPROVAL.
- 12. ALTHOUGH THE DEPTH OF REMOVAL TO SOUND CONCRETE MAY, AT SOME LOCATIONS, EXTEND TO DEPTHS GREATER THAN 5 INCHES, IT IS THE INTENT OF THIS PROJECT THAT THE CONTRACTOR SHALL MAKE ALL NECESSARY REPAIRS WITH NEW CONCRETE PER ITEM 582.0051.

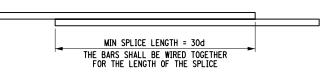

SCALE: NTS

TIED SPLICE LAP d = BAR SIZE/DIAMETER PLAN

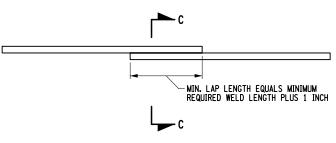

SCALE: NTS

WELDED SPLICE LAP PLAN SCALE: NTS

## MINIMUM WELD LENGTHS

EDGES OF CONCRETE REMOVAL SHALL BE "DOVETAILED" TO CREATE A GREATER BASE CAVITY

REMOVE UNSOUND CONCRETE. -

CONCRETE, ITEM 582.0051


REPLACE WITH NEW STRUCTURAL

SOUND CONCRETE -

EXISTING REINFORCEMENT -SHALL BE CLEANED

UNDER ITEM 582,0051

BAR SIZE	SINGLE FLARE L1 V-GROOVE WELD	DOUBLE FLARE L2 V-GROOVE WELD
5	4"	21/2"
6	41/2"	2¾"
7	5"	3"
8	51/2"	31/4"
9	6"	31/2"

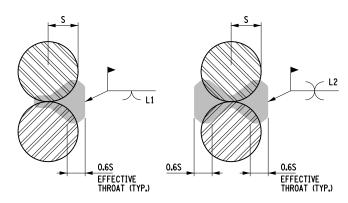

SINGLE FLARE V-GROOVE WELD

DOUBLE FLARE V-GROOVE WELD

SECTION A-A

SECTION B-B SIMILAR

SCALE: NTS

SECTION C-C SCALE: NTS

REINFORCING BAR NOMINAL RADIUS (TYP.)

	REVISIONS			NEW Thruway	TITLE OF PROJECT 1R MILL AND INLAY, SAFETY IMPROVEMENTS,	CONTRACT NUMBER:
DATE	DESCRIPTION	BY	SYM.	~ YORK   IIII UWAY	AND MISC, WORK	TAB 25-31
				<b>STATE</b> Authority		DATE:
					TITLE OF DRAWING	08/20/2025
			$\vdash$		CIN 417.63011XX	DRAWING NUMBER:
			$\vdash$		CONCRETE REPAIR DETAILS	CUL-3

## 58 58

## SIGNING NOTES:

- SIGN LOCATIONS AS SHOWN ON PLANS ARE APPROXIMATE. THE CONTRACTOR SHALL INSTALL NEW SIGNS AND RELOCATE EXISTING SIGNS IN ACCORDANCE WITH THE MUTCD AND NYS SUPPLEMENT.
- 2. THE COLOR IS ONLY SHOWN WHEN THERE IS AN OPTION THAT MUST BE SPECIFIED.
- 3. THE AREA AND PAYMENT AREA FOR SIGNS ARE FROM THE APPLICABLE STANDARD SHEETS OR SIGN FACE LAYOUTS.

	SIGN REMOVAL						
MP	SIDE	DESCRIPTION	ITEM NUMBER				
418.10	WB	REMOVE TYPE B SIGN POSTS AND SIGN. NEW AMHERST TONAWANDA SIGN AT MP 418.46.	645.51000125 645.830202 647.52 647.65				

SIGNING SUMMARY TABLE ( PANELS AND POSTS )								
ITEM NUMBER	QUANTITY							
645.51000125 645.8106 645.8106 645.830202 645.830402 645.830702 647.31 647.32 647.52 647.65	765 SF 1 EA 2 EA 2 EA 4 EA 1 EA 2 EA 2 EA							

DESIGNATION	LOCATION	ТЕХТ	ITEM	SIZE	PAYMENT AREA (SEE NOTE 3)
& COLOR (SEE NOTE 2)	LOCATION		IILW	AREA (SEE NOTE 3)	TOTAL PAYMENT AREA
WHITE ON GREEN	TITE ON GREEN  (MP 418.87)  1	645.830702	9′-6"×2′-6" 20′-0"×13′-0"	284 SF	
WILL ON SHEEK			645.51000125	23.75 SF 260 SF	
WHITE ON GREEN	E ON GREEN (MP 418.10)  1	645.830702	9'-6"x2'-6" 20'-0"x13'-0"	284 SF	
		645,51000125	23.75 SF 260 SF		
WHITE ON GREEN	4-1 (MP 418.46)	4-1 Tonawanda	645.51000125 645.830202	11'-0"x7'-0"	77 SF
	(MP 418.46) EXIT 50	647 <b>.</b> 52 647 <b>.</b> 65	77 SF	<b>v</b>	
WHITE ON GREEN	11-1 West East 90 Keep Keep Right	1. 1 1 1 1	645.830402	12'-0"×10'-0"	120 SF
		645.51000125	120 SF		
M1-1, M1-1, M3-2P, M3-4P,	8-1 WEST EAST 90 • 90 • 90 • 1	645.8106	36"×18" (2) 36"×36" (2) 30"×21" (2)	36 SF	
M6-2P, M6-3P		1 2	647.32	4.5 SF (2) 9 SF (2) 4.375 SF (2)	JU 31
WHITE ON GREEN	7-1	EMERGENCY DETOUR	645.81 647.31	36"×36"	9 SF
WILL ON OUTEN		F≯		9 SF	
M1-1, M1-1, M3-2P, M3-4P, M5-4P, M5-6P	WEST EAST  OFFICIAL PROPERTY OF THE PARTY OF	645.8106 647.32	36"x18" (2) 36"x36" (2) 36"x24" (2)	39 SF	
M5-4P, M5-6P			4.5 SF (2) 9 SF (2) 6 F (2)	33 SI	

ITEM	DESCRIPTION	UNIT	NOTES:
645.51000125 645.810 645.830202 645.830202 645.830702 647.31 647.32 647.52 647.65	INSTALL GROUND-MOUNTED SIGN PANELS (AUTHORITY SUPPLIED) TYPE A SIGN POSTS HIGH CAPACITY TYPE A SIGN POSTS TYPE B SIGN POST, CALVANIZED, W649 SECTION, BI-DIRECTIONAL BREAKAWAY TYPE B SIGN POST, CALVANIZED, W12x26 SECTION, BI-DIRECTIONAL BREAKAWAY TYPE B SIGN POST, CALVANIZED, W12x26 SECTION, BI-DIRECTIONAL BREAKAWAY TYPE B SIGN POST, CALVANIZED, W12x26 SECTION, BI-DIRECTIONAL BREAKAWAY RELOCATE SIGN PANEL, SIGN PANEL ASSEMBLY SIZE I, (UNDER 30 SF) RELOCATE SIGN PANEL, SIGN PANEL ASSEMBLY SIZE II, (30-100 SF) REMOVE AND DISPOSE SIGN PANEL, SIGN PANEL ASSEMBLY SIZE II, (30-100 SF) REMOVE AND DISPOSE TYPE B GROUND MOUNTED SIGN SUPPORT AND FOUNDATION	SF EACH EACH EACH EACH EACH EACH EACH EACH	1. REMOVAL AND DISPOSAL OF TYPE A SIGN POSTS SHALL BE INCLUDED IN RELOCATION ITEM.

	ALIERED ON:	09/09/2025
DESIGN SUPERVISOR: KELLH GAWKONSKI	SIGNATURE: STAMP:	SIGNATURE:  STAND  TE OF NEW  OB9722  OB9722

IT IS A VIOLATION OF LAW FOR ANY PERSON, UNLESS THEY ARE ACTING
UNDER THE DIRECTION OF A LICENSED PROFESSIONAL ENGINEER,
ARCHITECT, LANDSCAPE ARCHITECT, OR LAND SURVEYOR, TO ALTER AN
ITEM IN ANY WAY. IF AN ITEM BEARING THE STAMP OF A LICENSED
PROFESSIONAL IS ALTERED, THE ALTERING ENGINEER, ARCHITECT,
LANDSCAPE ARCHITECT, OR LAND SURVEYOR SHALL STAMP THE DOCUMENT
AND INCLUDE THE NOTATION "ALTERED BY" FOLLOWED BY THEIR SIGNATURE,
THE DATE OF SUCH ALTERATION, AND A SPECIFIC DESCRIPTION OF THE
ALTERATION

REVISIONS				NEW   Thereneses	TITLE OF PROJECT 1R MILL AND INLAY, SAFETY IMPROVEMENTS,	CONTRACT NUMBER:
ATE	DESCRIPTION	BY	SYM.	NEW YORK Thruway STATE Authority	AND MISC. WORK	TAB 25-31
				<b>STATE</b> Authority	MP 416.90 TO MP 419.40	DATE:
					TITLE OF DRAWING	08/20/25
					SIGN DATA SHEET	DRAWING NUMBER:
						SDS-1